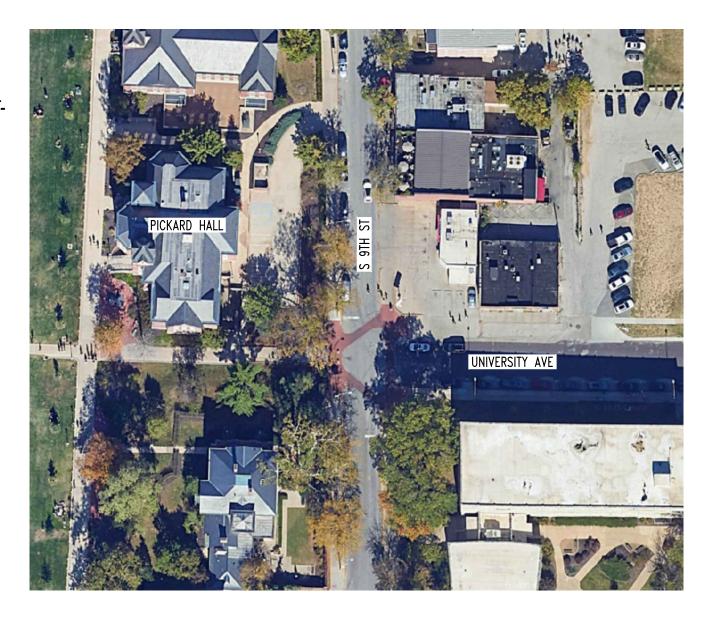


# CP242862 - PICKARD HALL - PHASE 1 - SELECT **DEMOLITION AND RAD CHARACTERIZATION** FOR THE CURATORS OF THE UNIVERSITY OF MISSOURI **PROJECT NO. CP242862**

## LOCATION MAP NOT TO SCALE



## **DEFERRED SUBMITTALS:**

N/A

## **APPLICABLE CODE LIST:**

INTERNATIONAL BUILDING CODE – 2024 INTERNATIONAL EXISTING BUILDING CODE - 2024 NATIONAL ELECTRIC CODE/NFPA 70 – 2023

## **UTILITY NOTES:**

ALL UTILITIES ARE UNIVERSITY OF MISSOURI, EXCEPT AS NOTED BELOW. THE LOCATIONS, SIZES, AND MATERIAL TYPES OF UNDERGROUND UTILITIES INDICATED ON THE PLAT, NOT VISIBLE OR APPARENT FROM THE SURFACE, ARE SHOWN IN THEIR APPROXIMATE LOCATIONS FROM A MISSOURI ONE CALL SYSTEM LOCATE, OR UTILITY COMPANY RECORDS AND WERE NOT VERIFIED IN THE FIELD. IRRIGATION LINES NOT SHOWN. UNDERGROUND ELECTRIC TO LIGHT STANDARDS NOT SHOWN.

UNIVERSITY OF MISSOURI

- ENERGY MANAGEMENT OFFICE 417 SOUTH FIFTH STREET
- COLUMBIA, MISSOURI 65211
- CONTACT: 573-882-3094
- ELECTRIC, TELECOMMUNICATIONS, STEAM, WATER CHILLED WATER, SANITARY SEWER, STORM SEWER
- WATER
- CITY OF COLUMBIA WATER & LIGHT DEPARTMENT P.O. BOX 6015 COLUMBIA, MISSOURI 65205 CONTACT: JOE STRODTMAN 573-874-6308

ELECTRIC

CITY OF COLUMBIA WATER & LIGHT DEPARTMENT P.O. BOX 6015 COLUMBIA, MISSOURI 65205

GAS

AMEREN MISSOURI 2001 MAGUIRE BOULEVARD COLUMBIA, MISSOURI 65201 CONTACT: CHAD WARREN 573-876-3063

CONTACT: DAN CLARK 573-874-7738

TELECOMMUNICATIONS CENTURYLINK 625 E. CHERRY STREET COLUMBIA, MISSOURI 65201

CONTACT: TIM DISHMAN 573-886-3505 MEDIACOM

1211 WILKES BOULEVARD COLUMBIA, MISSOURI 65201 CONTACT: BOB BONER 573-443-1536

CITY OF COLUMBIA WATER & LIGHT DEPARTMENT P.O. BOX 6015 COLUMBIA, MISSOURI 65205

CONTACT: ERIC WORTS 573-874-6246

CHARTER COMMUNICATIONS 904 RAIN FOREST PARKWAY COLUMBIA, MISSOURI 65202 CONTACT: JEREMY EPPERSON 573-745-0208

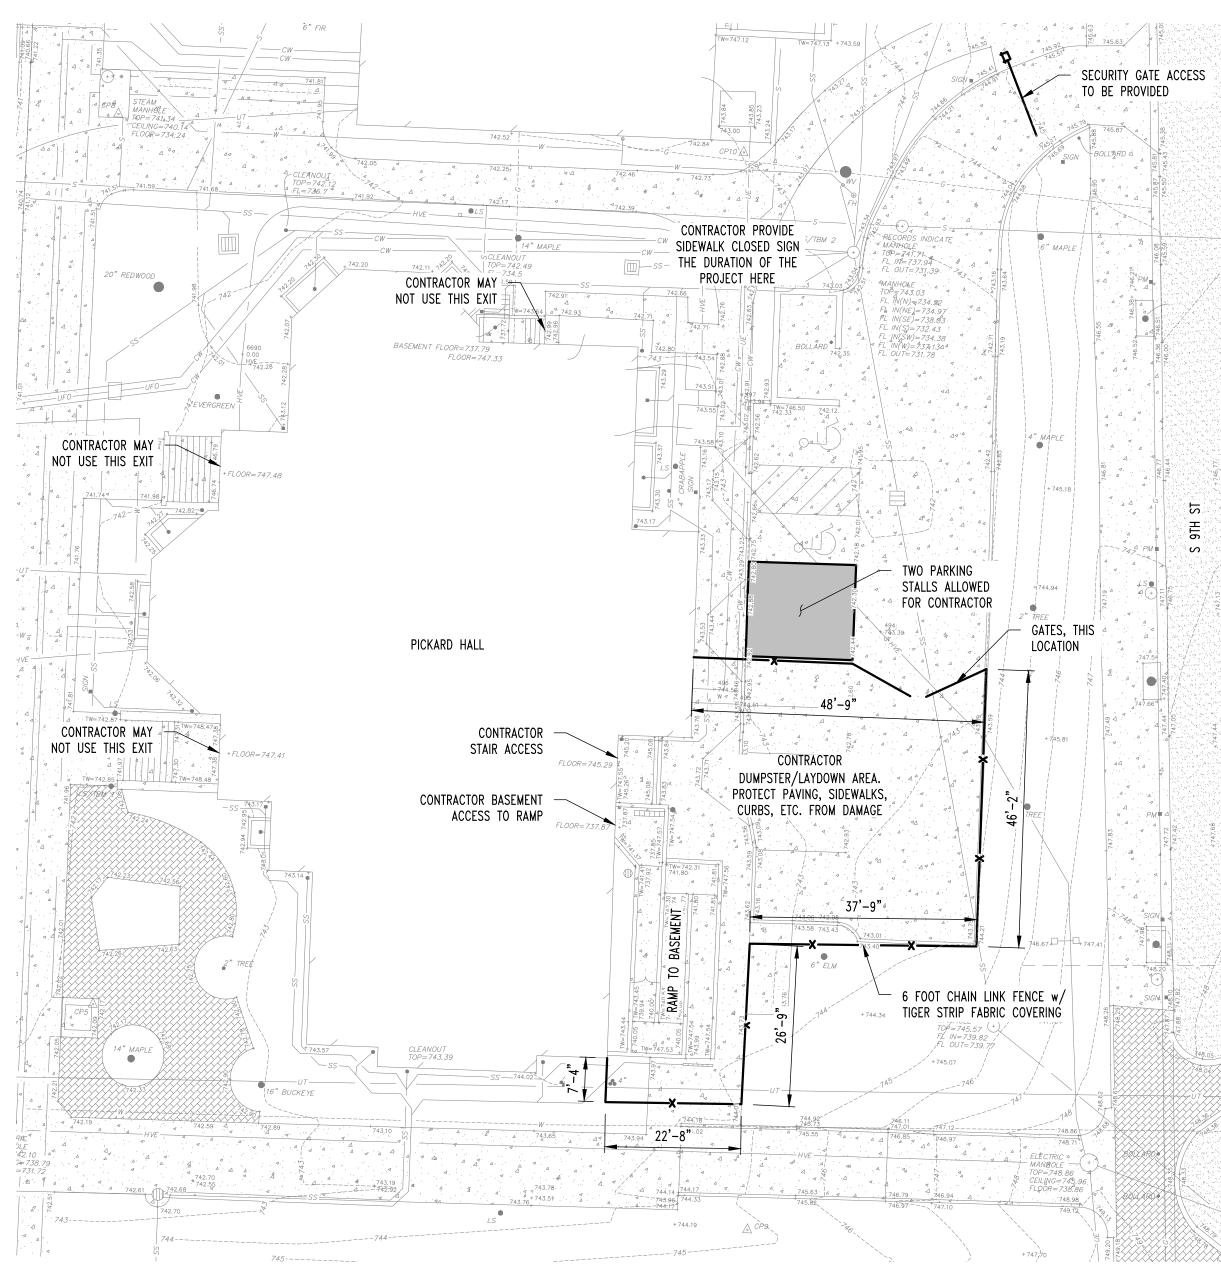
SANITARY SEWER CITY OF COLUMBIA UTILITIES DEPARTMENT P.O. BOX 6015 COLUMBIA, MISSOURI 65205 CONTACT: ERIN KEYS 573-874-7502 AS SHOWN

STORM SEWER

CITY OF COLUMBIA UTILITIES DEPARTMENT P.O. BOX 6015 COLUMBIA, MISSOURI 65205 CONTACT: TOM WELLMAN 573-874-7250

AS SHOWN

## EXISTING SURVEY/SITE LOGISTICS PLAN



## **CONTRACTOR NOTES:**

• THE INTENT OF THIS PROJECT IS TO REMOVE INTERIOR FINISHES THAT WERE INSTALLED AFTER THE BUILDING WAS ORIGINALLY CONSTRUCTED. ALL INTERIOR FURRING WALLS, CEILING, FLOORING, AND GYPCRETE SUBFLOORING ARE INTENDED TO BE REMOVED REGARDLESS OF THE NOTES ON THE FLOOR PLANS. IT WILL BE THE CONTRACTOR'S RESPONSIBILITY TO VERIFY WITH THE ENGINEER THAT ALL THE • FINISHES HAVE BEEN REMOVED PRIOR TO THE PROJECT FINISHING. ORIGINAL MASONRY WALLS WITH PLASTER, ORIGINAL AND NON ORIGINAL BASEMENT CONCRETE FLOORS ON GRADE, ORIGINAL WOOD FRAMING, WOOD SUBFLOORS AND PLASTER CEILINGS, ALONG WITH ATTIC/ROOF FRAMING ARE TO REMAIN. ACM AND RAD MATERIALS ARE PRESENT CURRENTLY WITHIN THIS BUILDING FOOTPRINT. IT IS EXPECTED THAT THE ACM MATERIALS WILL BE REMOVED BY THE PROJECT CONTRACTOR FIRST, THEN GENERAL DEMOLITION CAN BEGIN. EHS/CHASE WILL BE ONSITE TO TEST FOR RAD CONTAMINATION THE DURATION OF THE PROJECT. ALL ON-SITE PERSONEL SHALL HAVE RAD TRAINING PRIOR TO WORKING AT THIS PROJECT SITE, A PROJECT SPECIFIC SPECIFICATION INDICATING ACM & LEAD MATERIAL TO BE REMOVED IS PROVIDED IN THE DIVISION #1 DOCUMENTS.

- MOST FIXTURES SUCH AS LIGHTING, OUTLETS, LAVATORIES, AND WATER CLOSETS ARE INTENDED TO THE REMOVED AS PART OF THIS PROJECT; HOWEVER, MECHANICAL SYSTEMS, MAIN ELECTRICAL SYSTEMS, AND STEAM SYSTEMS WILL REMAIN NEED TO BE MAINTAINED AND OPERATIONAL AT THE END OF THE PROJECT.
- IT IS EXPECTED THAT EITHER THE FIRE ALARM SYSTEM OR A FIRE WATCH WILL BE MAINTAINED AT ALL TIMES DURING AND AFTER THE PROJECT. THIS PROJECT IS INTENDED TO BE CONSIDERED A TURNKEY PROJECT BY THE CONTRACTOR, SO THE CONTRACTOR SHOULD CLOSELY REVIEW THE STRUCTURAL, ELECTRICAL, AND SUPPLIER DRAWINGS TO CLEARLY UNDERSTAND WHICH NEW MATERIALS WILL BE SUPPLIED AND WHICH WILL BE THE RESPONSIBILITY OF THE CONTRACTOR.
- COORDINATE LAY DOWN AREAS w/ OWNER'S REPRESENTATIVE CONTRACTOR TO PROTECT EXISTING UTILITIES, LANDSCAPING, STRUCTURES, & PAVEMENT THAT IS TO REMAIN. ALL DAMAGED ITEMS OUTSIDE THE SCOPE OF WORK TO BE REPLACED OR REPAIRED TO ORIGINAL CONDITION AT THE CONTRACTORS EXPENSE.
- CONTRACTOR SHALL IMPLEMENT DUST CONTROL MEASURE ACCEPTABLE TO CHASE ENVIRONMENTAL THE DURATION OF THE PROJECT BOTH INTERIOR AND AT DUMPSTER.

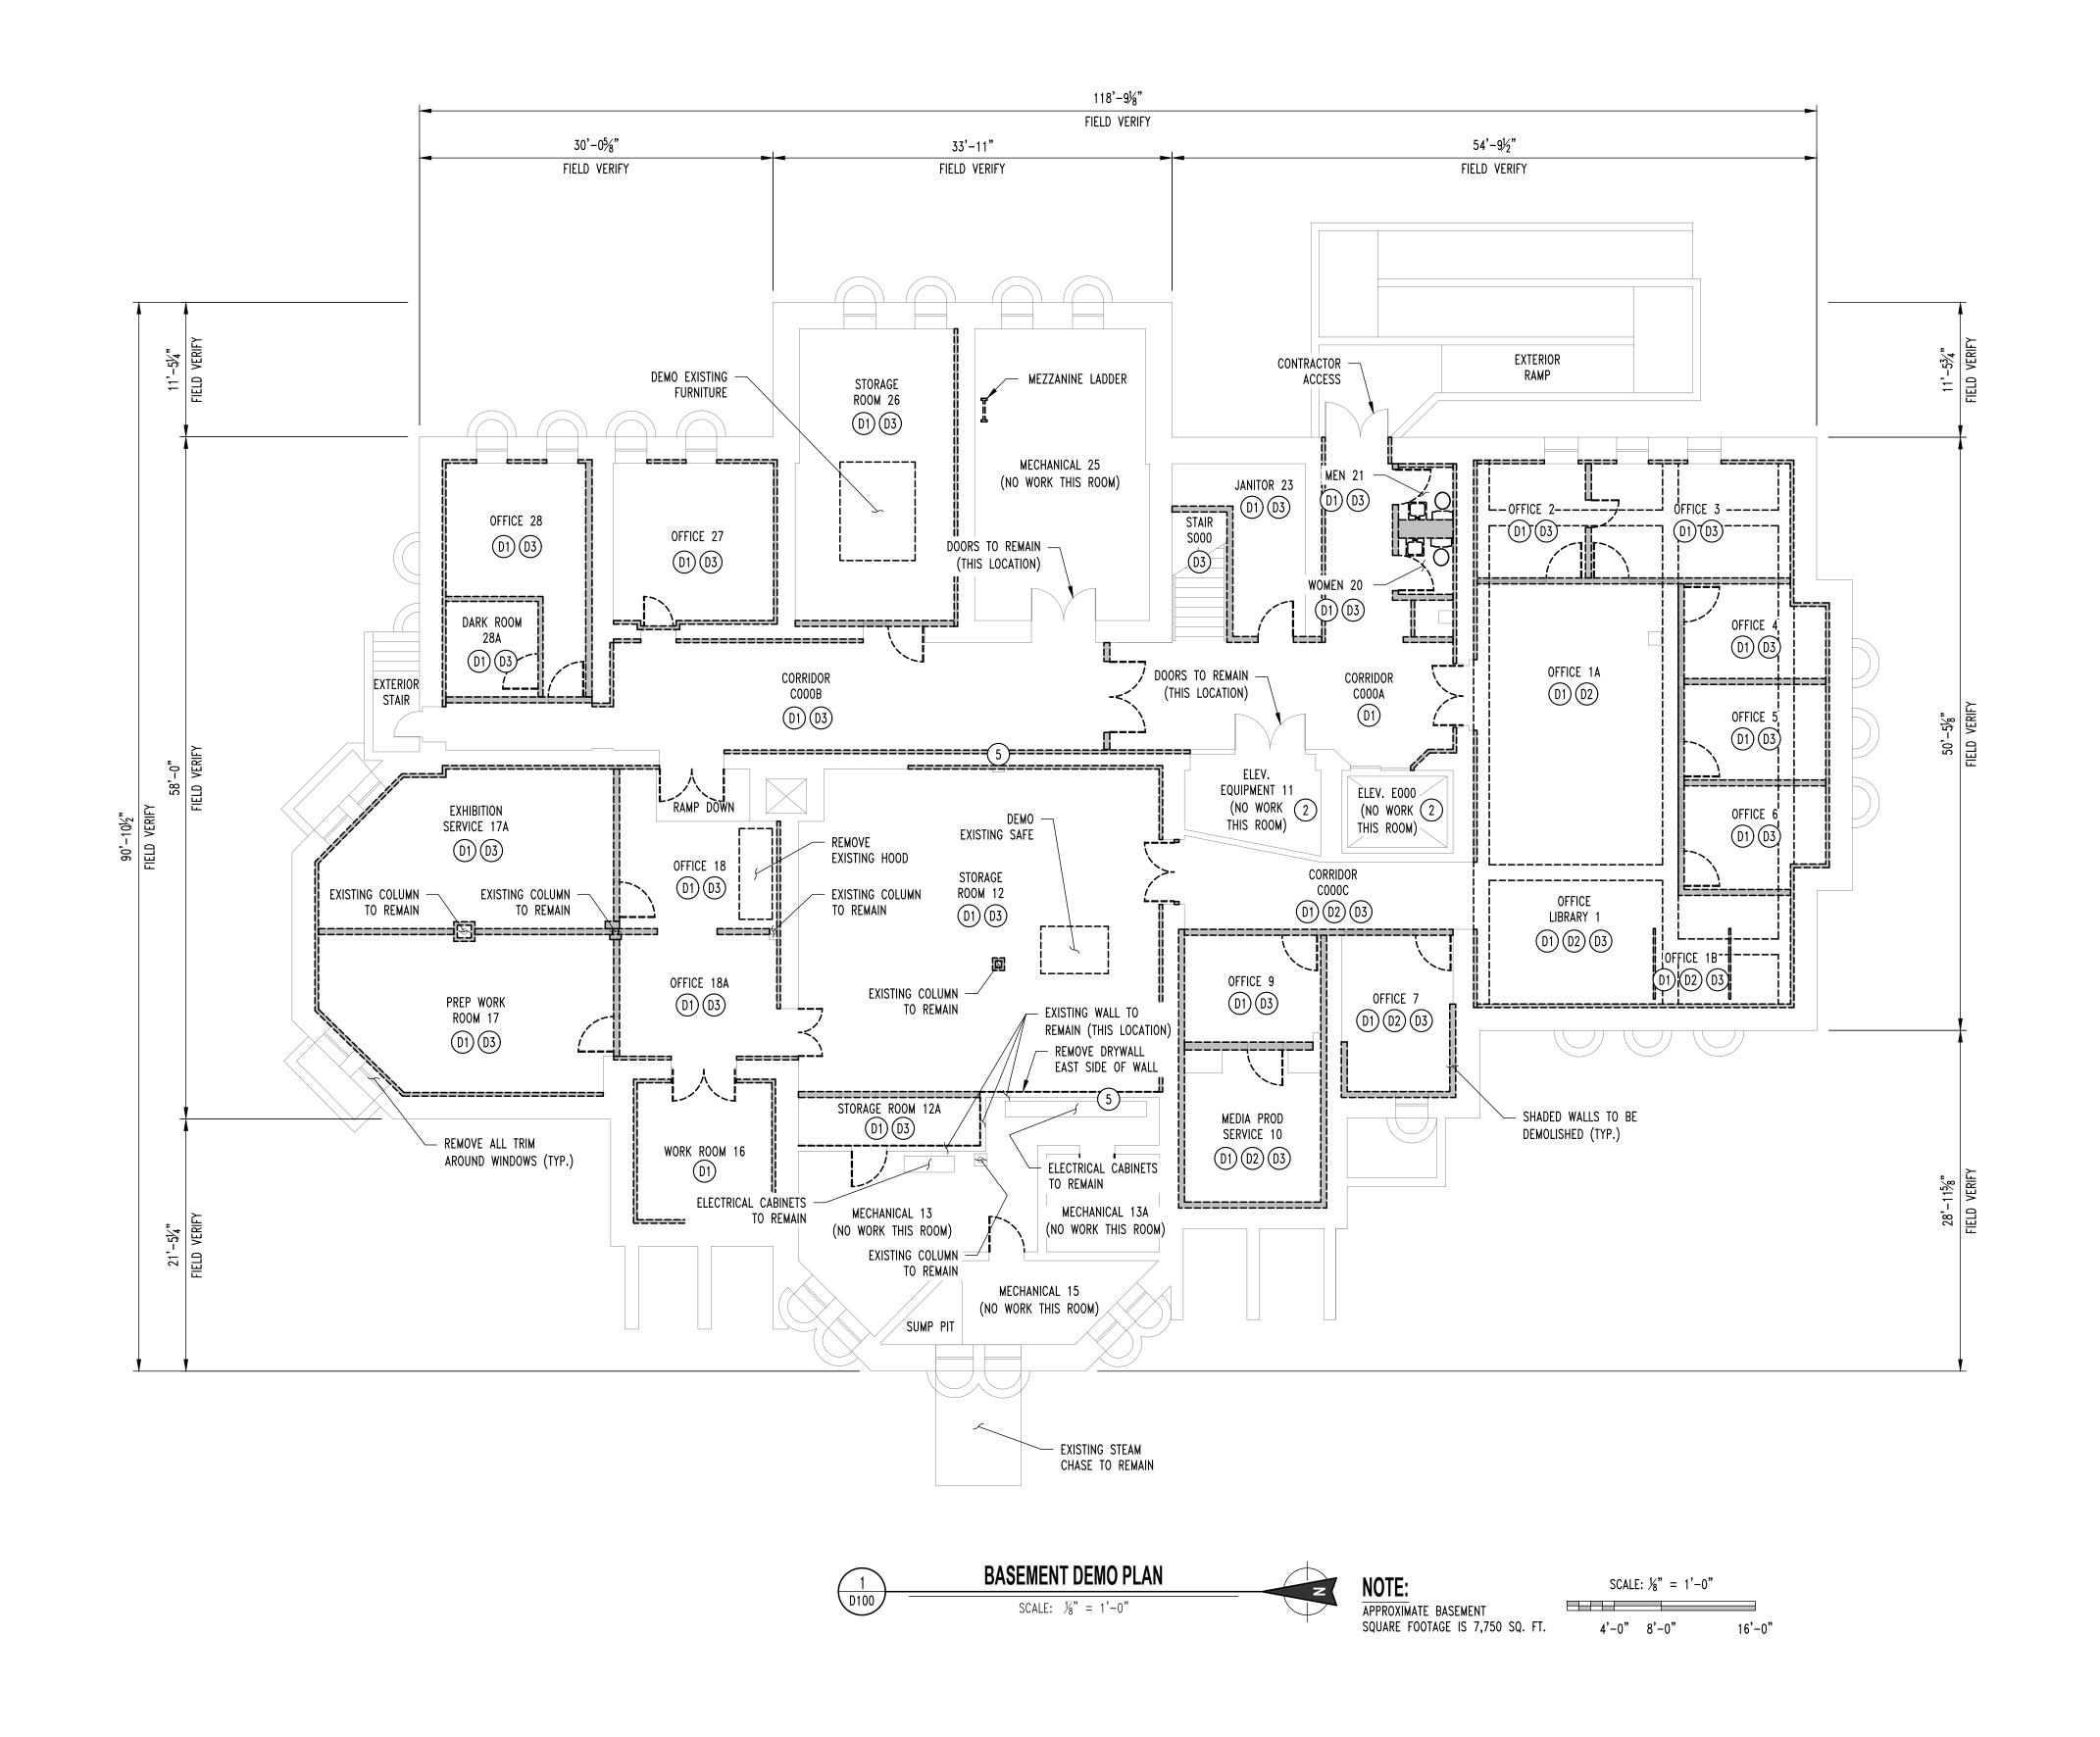


TIGER STRIPE FENCE SCREENING PATTERN

IVE		NO. BID SET THIS SHEET HAS SEALED AND DATED SEALED AND DATED GREGG	ELECTRONICALLY
	J-SQUARED ENGINEERING 2400 Bluff Creek Drive, Suite 101 Columbia, Missouri 65201 573 - 234 - 4492 phone www.j-squaredeng.com	GREGORY L. LI MO LICENSE - CONSULTANTS CONSULTANTS CONSULTANTS CONSULTANTS CONSULTANTS CONSULTANTS	73) 447-0292 ettengineering.com eering Consultants, LLC rifficate of Authority 2000151301
JAMES P. WATSON NUMBER PE-2015017071	MEP         IHEREBY CERTIFY THAT THESE DRAWINGS AND/OR         SPECIFICATIONS HAVE BEEN PREPARED BY ME, OR UNDER MY         SUPERVISION. I FURTHER CERTIFY THAT TO THE BEST OF MY         KNOWLEDGE THESE DRAWINGS AND/OR SPECIFICATIONS ARE         AS REQUIRED BY AND IN COMPLIANCE WITH THE BUILDING         CODES OF THE UNIVERSITY OF MISSOURI.    SIGNATURE:	CLIENT: UNIVERSITY OF MISSOURI	COLUMBIA, MISSOURI 65211
GREGORY L. LINNEMAN - PE MO LICENSE - 2005001013		Pickard Hall - Phase 1 - Selective on and RAD Characterization	405 S 9th ST BOONE COUNTY, MISSOURI
	SHEET INDEX: STRUCTURAL: COVER - COVER SHEET D100 - BASEMENT DEMO PLAN D101 - FIRST FLOOR DEMO PLAN D102 - SECOND FLOOR DEMO PLAN MECHANICAL/ELECTRICAL/PLUMBING: ME101 - MECHANICAL ELECTRICAL PLAN - BASEMENT ME102 - MECHANICAL ELECTRICAL PLAN - FIRST FLOOR ME103 - MECHANICAL ELECTRICAL PLAN - SECOND FLOOR FA101 - FIRE ALARM PLAN - BASEMENT EA102 - EIRE ALARM PLAN - EIRST FLOOP	CP242862 - Pic Demolition	COLUMBIA,
	FA102 - FIRE ALARM PLAN - FIRST FLOOR FA103 - FIRE ALARM PLAN - SECOND FLOOR	COVER S DESIGNED: DRAWN: CEC PROJECT NO	GLL RCA

COVER

REVISIONS




## **GENERAL NOTES**

- 1 REFER TO 1974 PRINTS FOR SPECIFICS ON FINISHES THAT WERE ADDED TO THE BUILDING SUCH AS FLOORING, CEILING, AND WALL FURRING.
- 2 ELEVATOR IS NOT TO BE UTILIZED FOR THIS DEMO PROJECT.
- ALL SURFACES TO REMAIN SHALL BE FREE & CLEAR OF NAILS, PROTRUSIONS, ETC. TO ALLOW FOR SCANNING.
- (4) REFER TO ASBESTOS, LEAD, & UNIVERSAL WASTE REPORT PRIOR TO DEMOLITION.
- 5 LEAVE FINISHES BEHIND ALL MAJOR CONDUIT/PIPING & BEHIND MISC. CONTROL PANELS.
- 6 FIRE EXTINGUISHERS SHALL BE REMOVED & INSTALLED IN SAME GENERAL LOCATION AS THEY WERE ORIGINALLY.

## DEMOLITION NOTES

- D1) REMOVE ALL DRYWALL & FURRING STUD WALLS.
- D2) REMOVE ALL CARPET.
- D3 REMOVE ALL NON-PLASTER CEILINGS & SOFFITS.

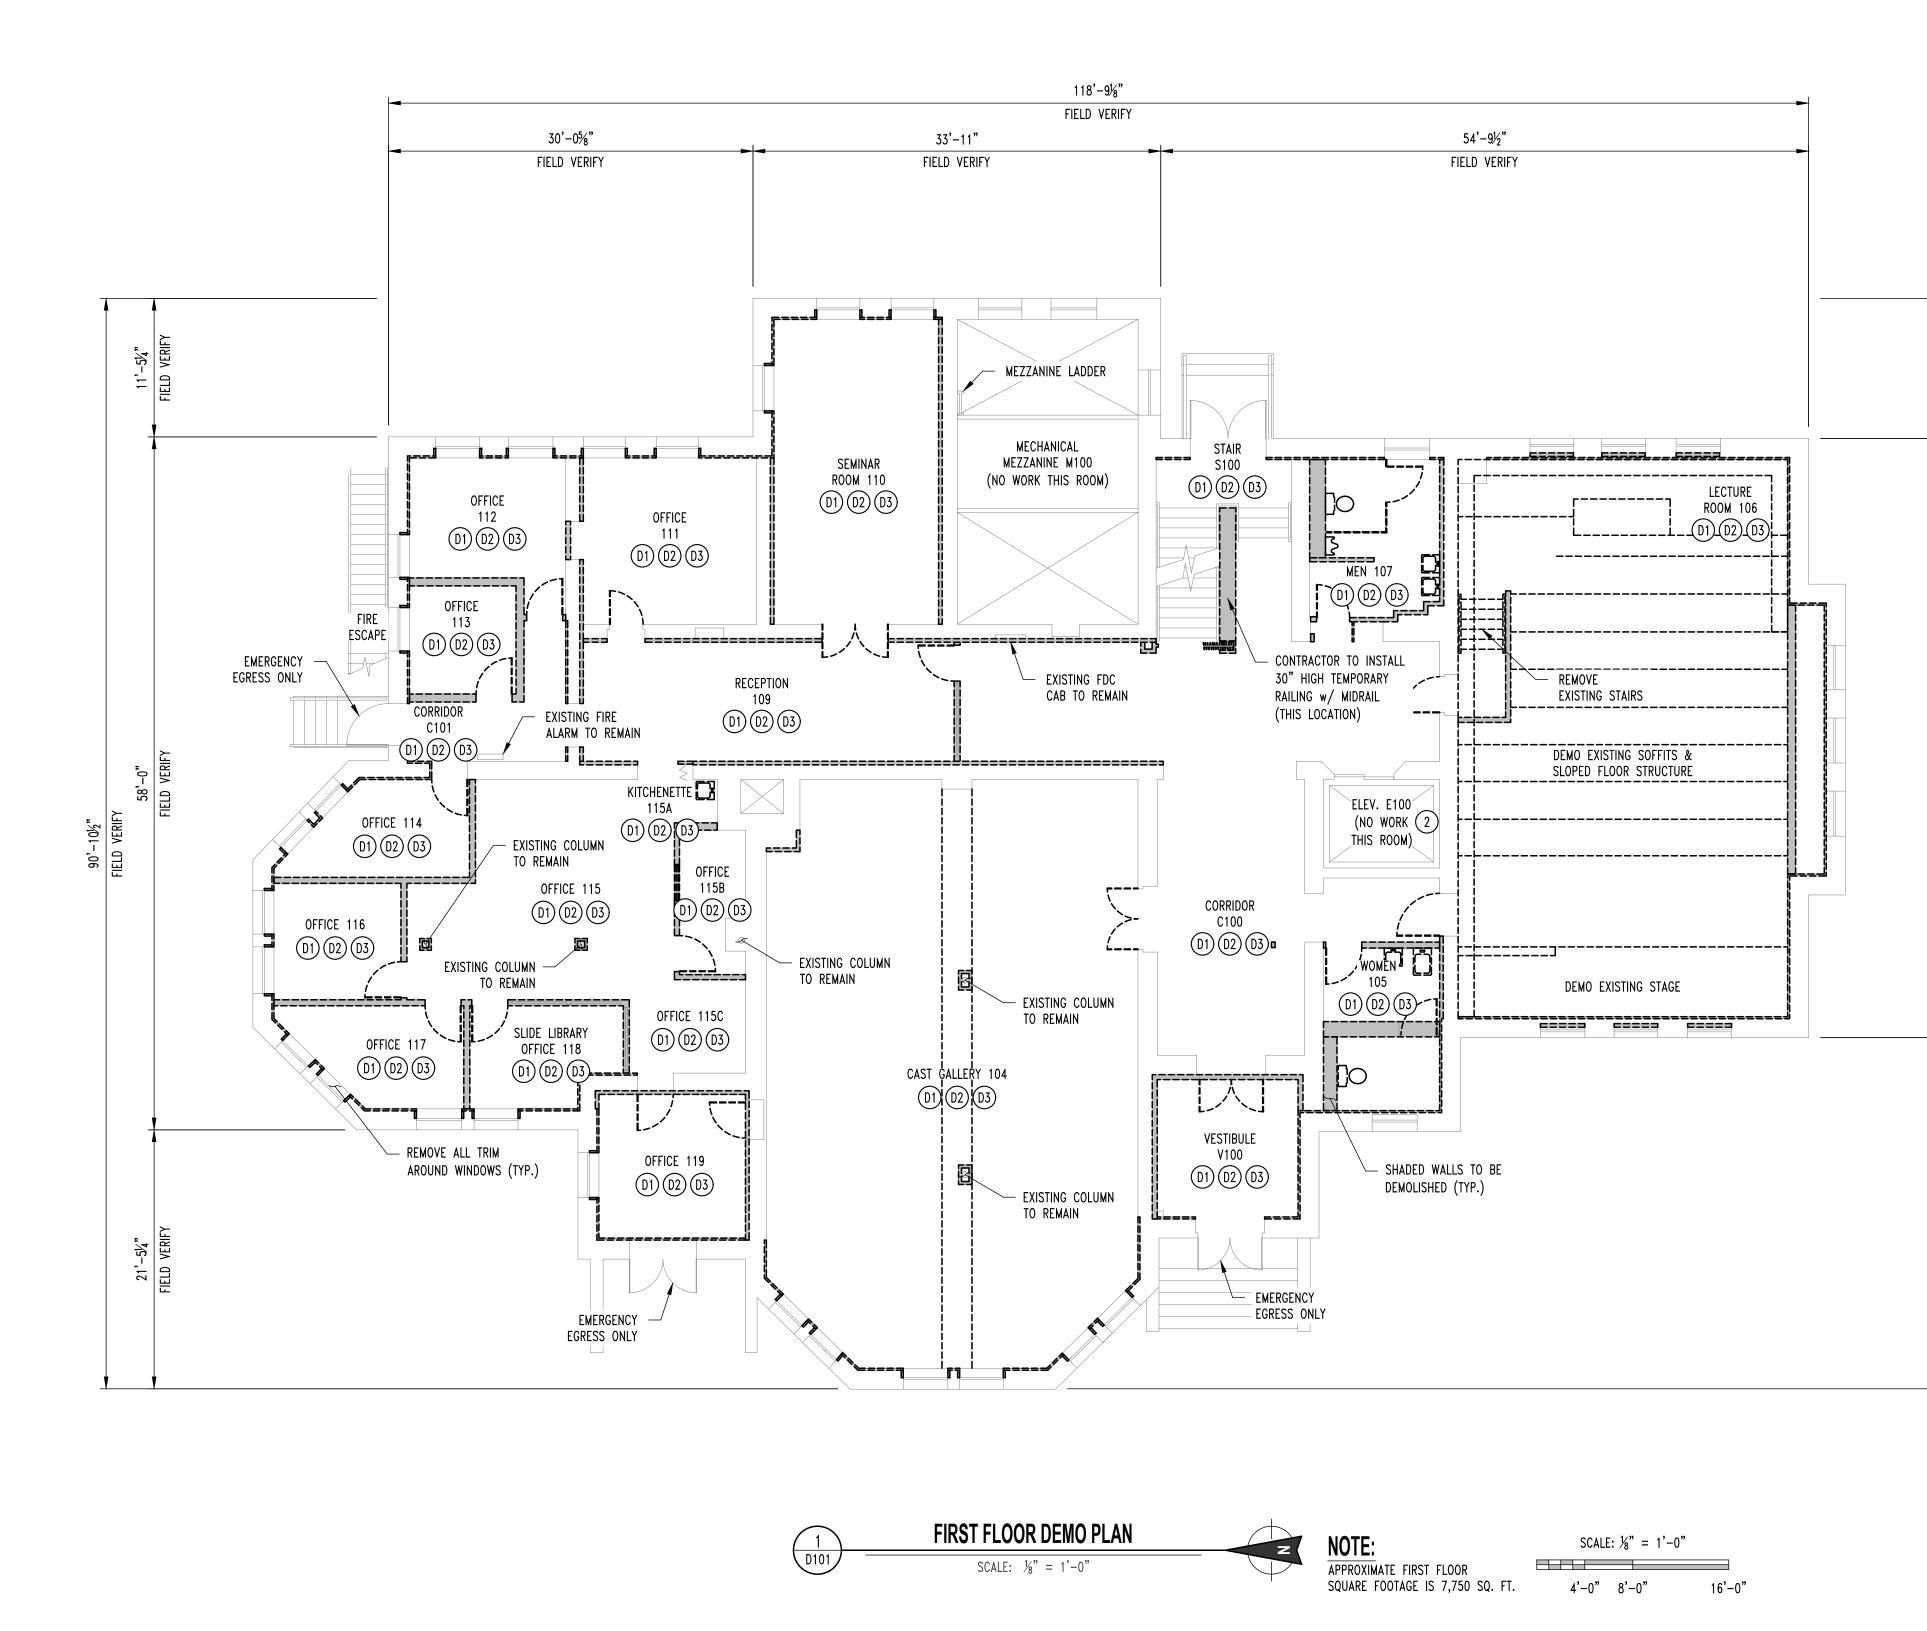REVISIONS:	Data	
No. BID SET	Date 04/24/2025	
	S BEEN SIGNED,	
SEALED AND DATED ELECTRONICALLY OF M/SS GREGORY L. UNNEMAN NUMBER PE-2005001013 4/23/25 GREGORY L. LINNEMAN - PE MO LICENSE - 2005001013		
STRUCTURAL ENGINEER:	Columbia, Missouri 65203 (573) 447-0292 w w w.crockettengineering.com Crockett Engineering Consultants, LLC Missouri Certificate of Authority #2000151301	
CLIENT: UNIVERSITY OF MISSOURI 225 UNIVERSITY HALL COLUMBIA, MISSOURI 65211		
42862 - Pickard Hall - Phase 1 - Selective Demolition and RAD Characterization	л ST DUNTY, MISS	
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## **GENERAL NOTES**


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## **DEMOLITION NOTES**

- D1 REMOVE ALL DRYWALL & FURRING STUD WALLS.
- D2) REMOVE ALL BRICK/CARPET FLOORING & 2" THICK GYPCRETE.
- D3 REMOVE ALL NON-PLASTER CEILINGS & SOFFITS.

REVISIONS:			
	ate 04/24/2025		
THIS SHEET HAS BEEN SIGNED, SEALED AND DATED ELECTRONICALLY OF M/SSO GREGORY L. UNNEMAN NUMBER PE-2005001013 4/23/25 GREGORY L. LINNEMAN - PE MO LICENSE - 2005001013			
STRUCTURAL ENGINEER:	www.crockettengineering.com Crockett Engineering Consultants, LLC Missouri Certificate of Authority #2000151301		
CLIENT: UNIVERSITY OF MISSOURI 225 UNIVERSITY HALL	Ŭ		
CP242862 - Pickard Hall - Phase 1 - Selective Demolition and RAD Characterization	405 S 9th ST COLUMBIA, BOONE COUNTY, MISSOURI		
DRAWING INCLUDES: FIRST FLOOR DEMO PLAN			
DESIGNED:	GLL		
DRAWN:	RCA		
	RCA		





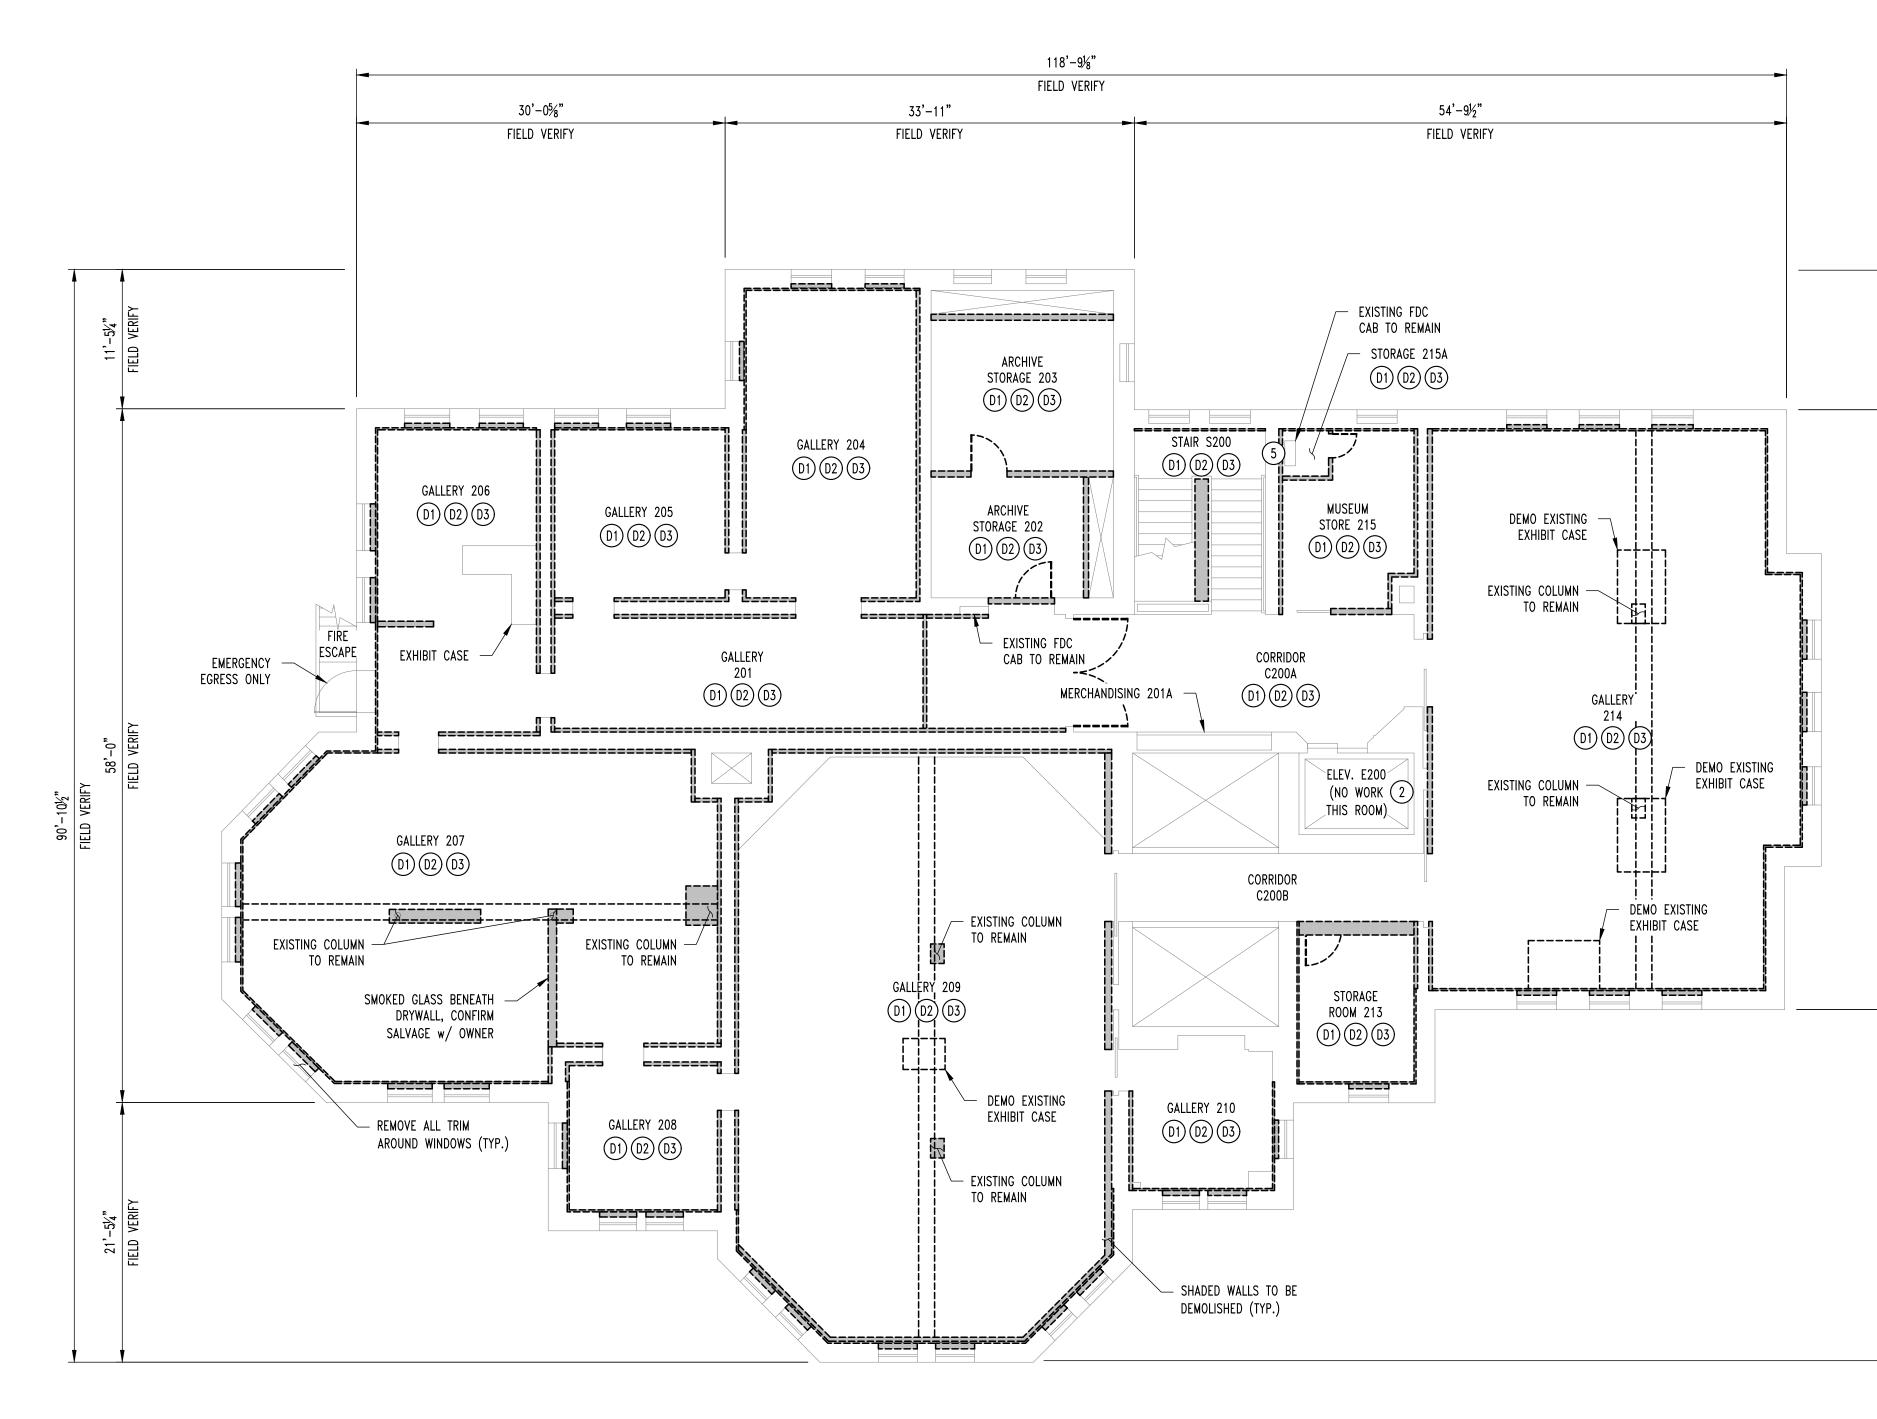

## **GENERAL NOTES**

- 1 REFER TO 1974 PRINTS FOR SPECIFICS ON FINISHES THAT WERE ADDED TO THE BUILDING SUCH AS FLOORING, CEILING, AND WALL FURRING.
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Gg	5001013	
STRUCTURAL ENGINEER: CONTRACTION ENGINEERING CONSULTANT: Columbia, Missouri 65203 (573) 447-0292	www.crockettengineering.com Crockett Engineering Consultants, LLC Missouri Certificate of Authority #2000151301	
CLIENT: UNIVERSITY OF MISSOURI 225 UNIVERSITY HALL COLUMBIA, MISSOURI 65211		
CP242862 - Pickard Hall - Phase 1 - Selective Demolition and RAD Characterization	405 S 9th ST COLUMBIA, BOONE COUNTY, MISSOURI	
DRAWING INCLUDES: SECOND FLOOR DEMO PLAN		
DESIGNED:	GLL	
DESIGNED: DRAWN:	GLL RCA	



#### LIGHT FIXTURE LEGEND

 $\bigcirc$ 

- LED EMERGENCY EGRESS LIGHT (EQUAL TO SURE-LITES #SEL60) X1
- COMBINATION LED EXIT SIGN & EMERGENCY LIGHT (EQUAL TO SURE-LITES #APCH7RG) X2

TEMPORARY LIGHTING - ROUND HIGH BAY (EQUAL TO ILP #RB4-14L-U-35-BLK-FRL)

#### **MECHANICAL - ELECTRICAL PLAN GENERAL NOTES:**

- 1. ALL ITEMS LABELED AS EXISTING ARE TO REMAIN IN SERVICE.
- 2. REFER TO 1974 PRINTS FOR APPROXIMATE EXISTING CONDITIONS. IT IS THE CONTRACTOR'S RESPONSIBILITY TO REVIEW THE SITE & UNDERSTAND THE SCOPE OF WORK. NO CHANGE ORDERS WILL BE PAID FOR CONTRACTOR'S FAILURE TO UNDERSTAND COMPLETE SCOPE OF WORK. THE INTENT OF THIS PROJECT IS TO REMOVE ALL
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- 2.2. ALL HVAC BRANCH DUCTWORK IS TO BE REMOVED BACK TO MAIN TRUNKS (SUPPLY & RETURN).
- 2.3. ALL EXHAUST DUCTWORK IS TO BE REMOVED. ANY EXTERIOR PENETRATIONS SHALL BE PATCHED.
- 2.4. ALL EXISTING STEAM & CHILLED WATER PIPING SHALL REMAIN IN SERVICE. 2.5. ALL ABOVE GRADE PLUMBING NOT CONCEALED IN WALLS SHALL BE DEMOLISHED.
- 2.6. EXISTING WATER SERVICE ENTRANCE & METERING SHALL REMAIN.
- 2.7. ALL SEWER LINES SHALL BE CAPPED AT FLOORS OR WALLS WITH GAS-TIGHT CAPS.
- 3. CONTRACTOR SHALL INSTALL NEW 20 AMP SINGLE POLE BREAKER IN EXISTING PANEL THIS FLOOR TO POWER TEMPORARY EMERGENCY LIGHTING. 4. HANG TEMPORARY LIGHTS 6" BELOW CEILING STRUCTURE. FEED ALL TEMPORARY LIGHT FIXTURES FROM SAME
- CIRCUIT AS TEMPORARY EMERGENCY LIGHTING.
- 5. ALL WIRING MAY BE DONE IN MC CABLE STRAPPED TO STRUCTURE.

#### MECHANICAL ELECTRICAL PLAN KEY NOTES:

\_\_\_\_\_

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TO NEW 20-1 BREAKER IN

EXISTING PANEL THIS FLOOR

(SEE GENERAL NOTE #3)

O TL

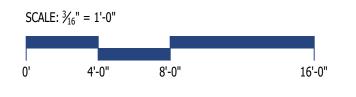
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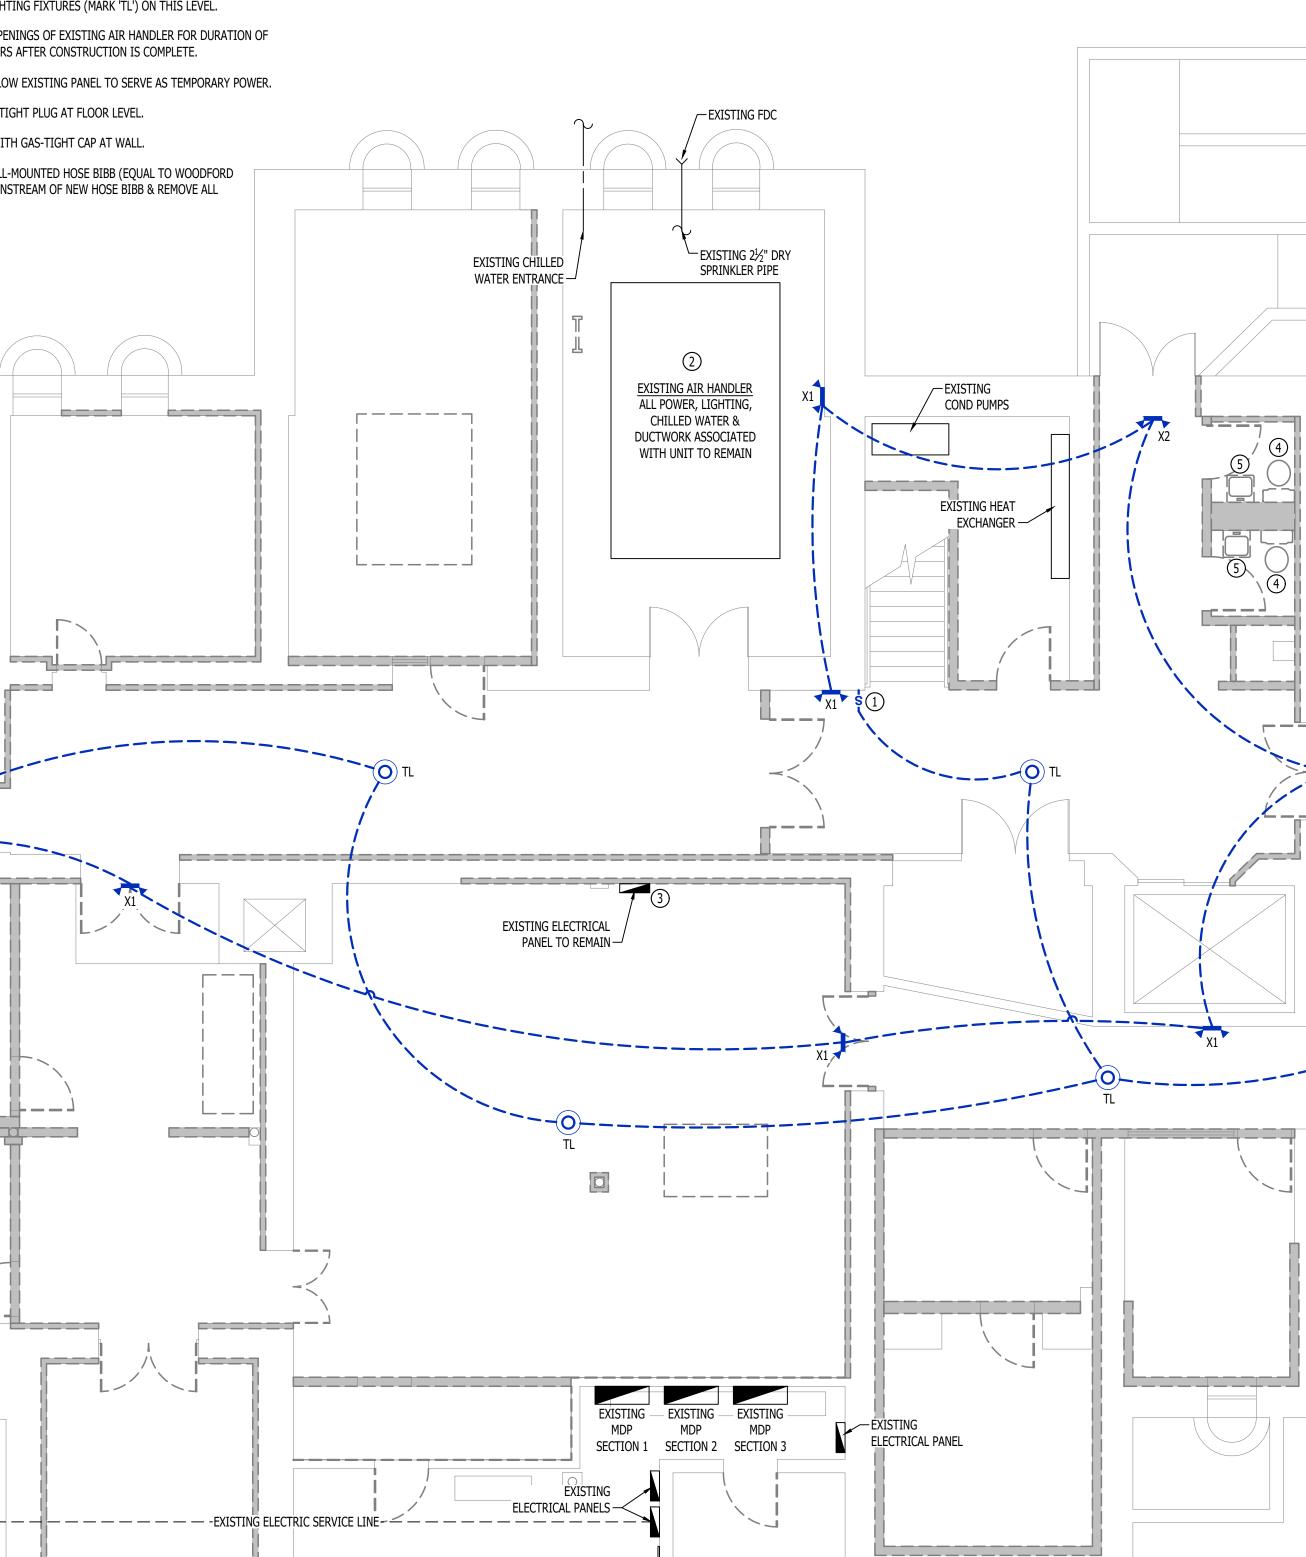
EXISTING 4" PVC

- 1 INSTALL NEW SWITCH TO CONTROL TEMPORARY LIGHTING FIXTURES (MARK 'TL') ON THIS LEVEL. (2) INSTALL CONSTRUCTION FILTERS ON RETURN AIR OPENINGS OF EXISTING AIR HANDLER FOR DURATION OF
- DEMOLITION / REMODEL. INSTALL NEW MERV8 FILTERS AFTER CONSTRUCTION IS COMPLETE.
- (3) CONTRACTOR SHALL INSTALL QUAD RECEPTACLE BELOW EXISTING PANEL TO SERVE AS TEMPORARY POWER.
- (4) REMOVE EXISTING WATER CLOSET & CAP WITH GAS-TIGHT PLUG AT FLOOR LEVEL.
- (5) DEMOLISH EXISTING SINK & CAP EXISTING SEWER WITH GAS-TIGHT CAP AT WALL.
- (6) DEMOLISH EXISTING HOSE BIBB & INSTALL NEW WALL-MOUNTED HOSE BIBB (EQUAL TO WOODFORD #MODEL 21 CHROME FINISH). CAP WATER LINE DOWNSTREAM OF NEW HOSE BIBB & REMOVE ALL EXISTING DOMESTIC WATER PIPING & EQUIPMENT.

\_\_\_\_\_







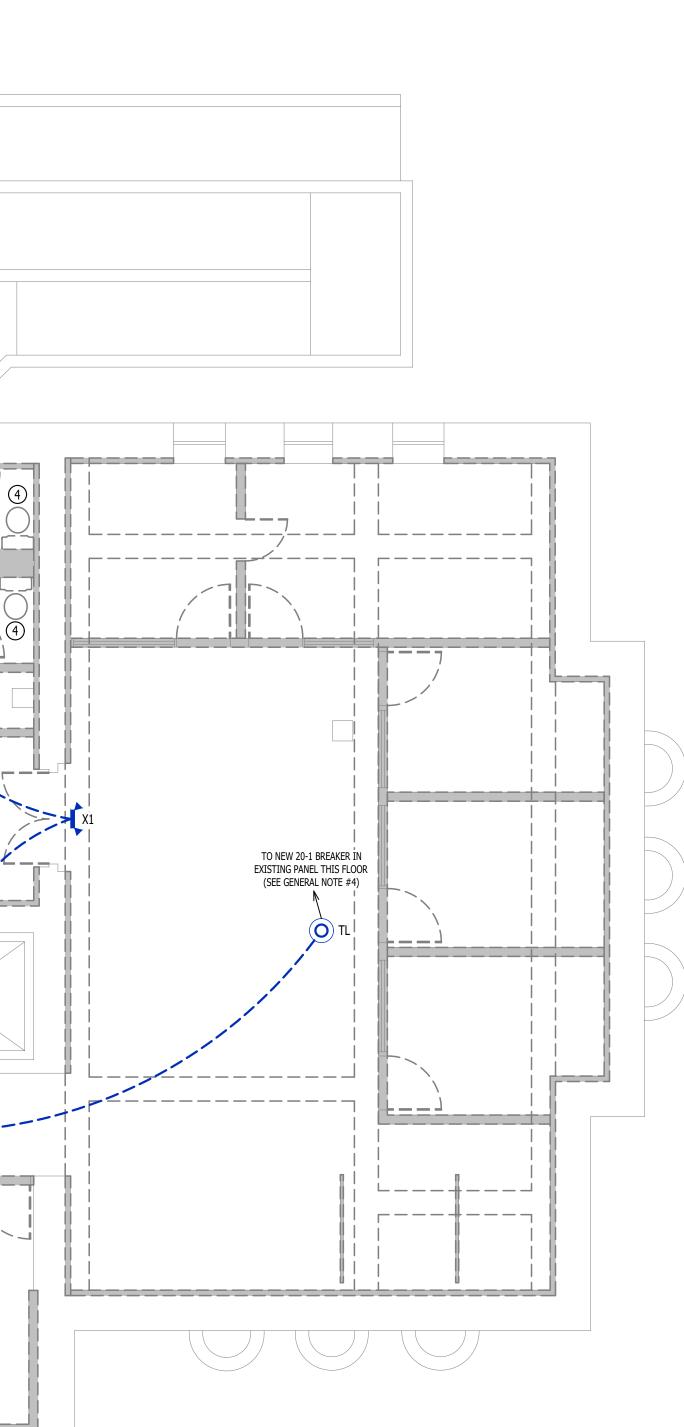
**MECHANICAL ELECTRICAL PLAN - BASEMENT** SCALE: 3/16" = 1'-0"

-EXISTING WATER ENTRANCE

-EXISTING STEAM

ENTRANCE

EXISTING TELEPHONE BOARD





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SHEET TITLE

MECHANICAL **ELECTRICAL PLAN -**BASEMENT



#### LIGHT FIXTURE LEGEND

- LED EMERGENCY EGRESS LIGHT (EQUAL TO SURE-LITES #SEL60) X1
- COMBINATION LED EXIT SIGN & EMERGENCY LIGHT (EQUAL TO SURE-LITES #APCH7RG) ×2

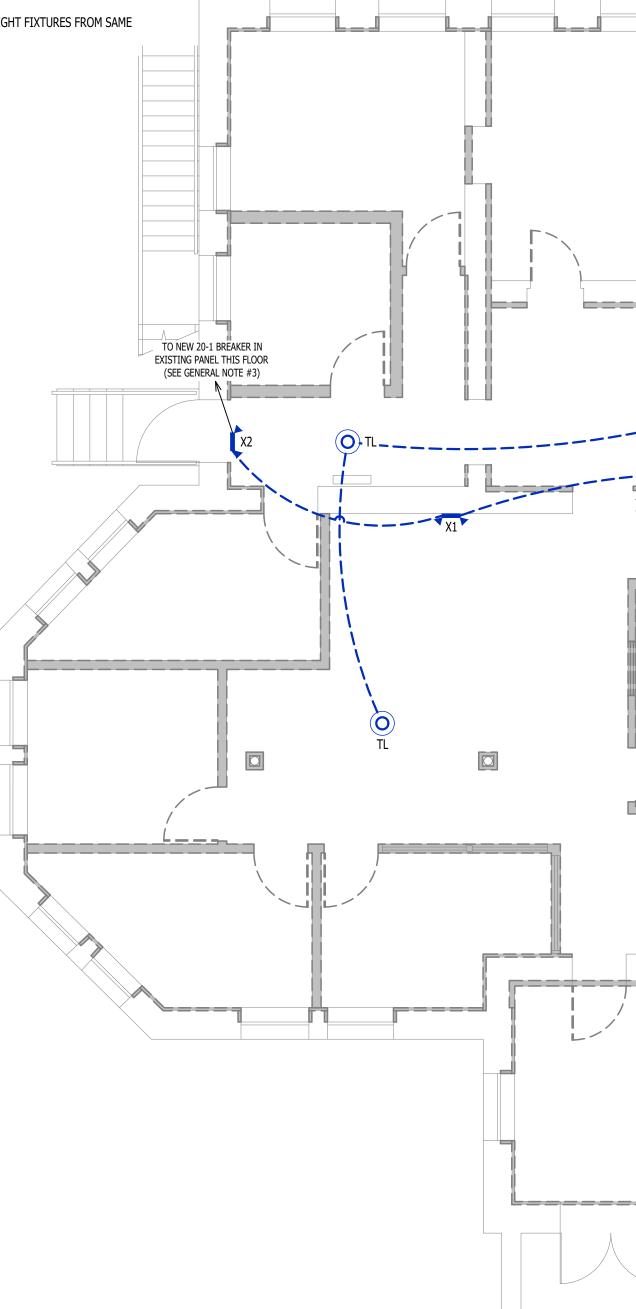
 $\bigcirc$ TEMPORARY LIGHTING - ROUND HIGH BAY (EQUAL TO ILP #RB4-14L-U-35-BLK-FRL)

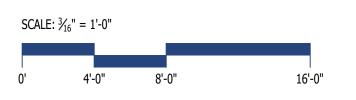
#### MECHANICAL - ELECTRICAL PLAN GENERAL NOTES:

- 1. ALL ITEMS LABELED AS EXISTING ARE TO REMAIN IN SERVICE.
- 2. REFER TO 1974 PRINTS FOR APPROXIMATE EXISTING CONDITIONS. IT IS THE CONTRACTOR'S RESPONSIBILITY TO REVIEW THE SITE & UNDERSTAND THE SCOPE OF WORK. NO CHANGE ORDERS WILL BE PAID FOR CONTRACTOR'S FAILURE TO UNDERSTAND COMPLETE SCOPE OF WORK. THE INTENT OF THIS PROJECT IS TO REMOVE ALL MATERIALS BACK TO THE ORIGINAL STRUCTURE.
- 2.1. ALL ELECTRICAL SHALL BE REMOVED BACK TO PANELS (PANELS & FEEDER TO PANEL SHALL REMAIN) EXCEPT FOR FEEDS TO ELEVATOR, ITEMS ASSOCIATED WITH ELEVATOR, FEEDS TO HVAC EQUIPMENT, HVAC CONTROLS, LIGHTING IN MECHANICAL ROOMS, CONDENSATE PUMPS, METERING EQUIPMENT, AND FIRE
- ALARM DEVICES. 2.2. ALL HVAC BRANCH DUCTWORK IS TO BE REMOVED BACK TO MAIN TRUNKS (SUPPLY & RETURN).
- 2.3. ALL EXHAUST DUCTWORK IS TO BE REMOVED. ANY EXTERIOR PENETRATIONS SHALL BE PATCHED.
- 2.4. ALL EXISTING STEAM & CHILLED WATER PIPING SHALL REMAIN IN SERVICE.
- 2.5. ALL ABOVE GRADE PLUMBING NOT CONCEALED IN WALLS SHALL BE DEMOLISHED. 2.6. EXISTING WATER SERVICE ENTRANCE & METERING SHALL REMAIN.
- 2.7. ALL SEWER LINES SHALL BE CAPPED AT FLOORS OR WALLS WITH GAS-TIGHT CAPS.
- 3. CONTRACTOR SHALL INSTALL NEW 20 AMP SINGLE POLE BREAKER IN EXISTING PANEL THIS FLOOR TO POWER TEMPORARY EMERGENCY LIGHTING.
- 4. HANG TEMPORARY LIGHTS 6" BELOW CEILING STRUCTURE. FEED ALL TEMPORARY LIGHT FIXTURES FROM SAME CIRCUIT AS TEMPORARY EMERGENCY LIGHTING.
- 5. ALL WIRING MAY BE DONE IN MC CABLE STRAPPED TO STRUCTURE.

#### MECHANICAL ELECTRICAL PLAN KEY NOTES:


- 1 INSTALL NEW SWITCH TO CONTROL TEMPORARY LIGHTING FIXTURES (MARK 'TL') ON THIS LEVEL. (2) CONTRACTOR SHALL INSTALL QUAD RECEPTACLE BELOW EXISTING PANEL TO SERVE AS TEMPORARY POWER.
- (3) REMOVE EXISTING WATER CLOSET & CAP WITH GAS-TIGHT PLUG AT FLOOR LEVEL.
- (4) DEMOLISH EXISTING SINK & CAP EXISTING SEWER WITH GAS-TIGHT CAP AT WALL.
- 5 DEMOLISH EXISTING URINAL & CAP EXISTING SEWER WITH GAS-TIGHT CAP AT WALL.





\_\_\_\_\_ EXISTING AIR HANDLER \_\_\_\_\_ ALL POWER, LIGHTING, CHILLED WATER & DUCTWORK ASSOCIATED WITH UNIT TO REMAIN  $(\bigcirc 3)$ 55 1 1 1 1 1 1 -----~ \_ \_ \_ \_ \_ \_ X1 2 EXISTING PANEL 'IL1' TO REMAIN \_ \_ \_ \_ (4)  $(\mathbf{O})$ 3  $\sim$ TO NEW 20-1 BREAKER IN EXISTING PANEL THIS FLOOR (SEE GENERAL NOTE #4) \_\_\_\_\_ 
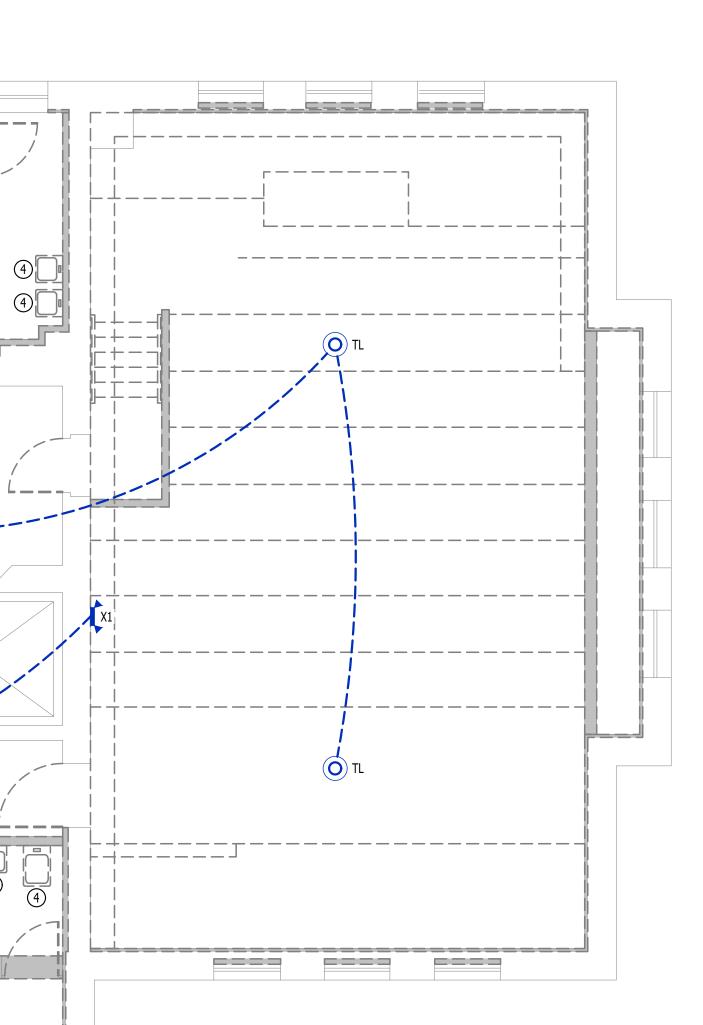
> MECHANICAL ELECTRICAL PLAN - FIRST FLOOR SCALE: 3/16" = 1'-0"



(4)



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SHEET TITLE

MECHANICAL **ELECTRICAL PLAN -**FIRST FLOOR



#### LIGHT FIXTURE LEGEND

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LED EMERGENCY EGRESS LIGHT (EQUAL TO SURE-LITES #SEL60) X1

COMBINATION LED EXIT SIGN & EMERGENCY LIGHT (EQUAL TO SURE-LITES #APCH7RG) ×2

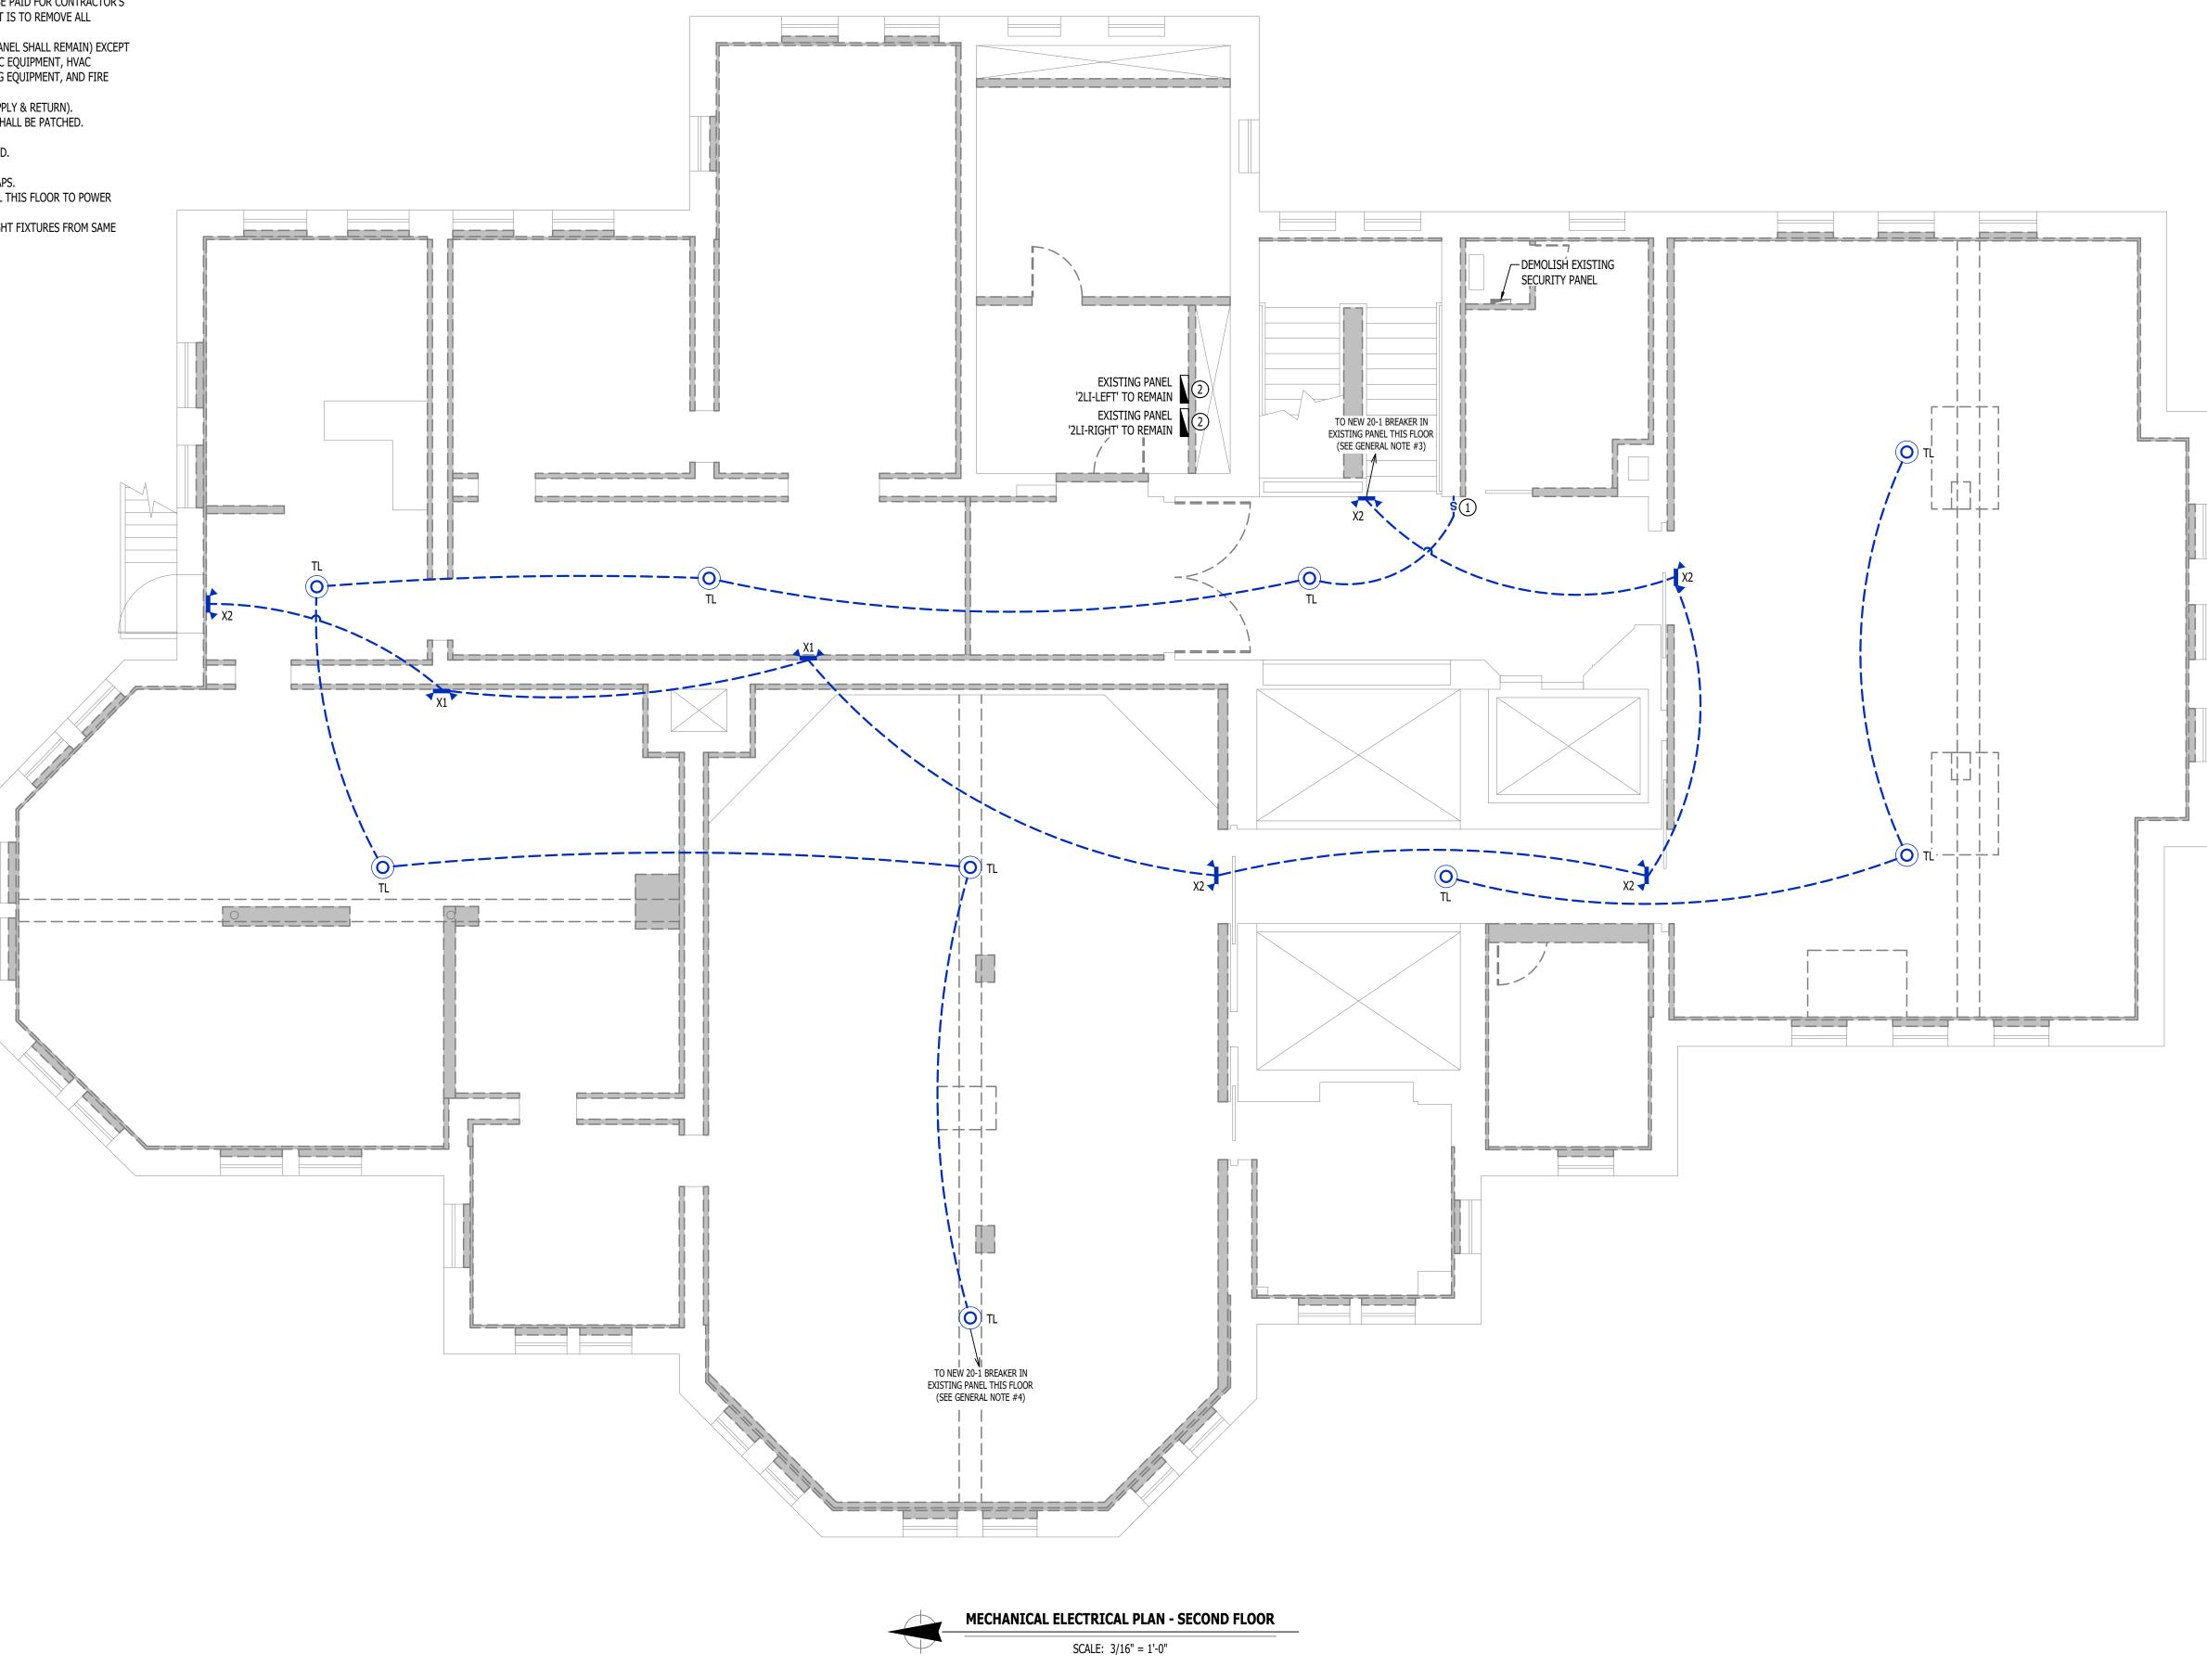
#### TEMPORARY LIGHTING - ROUND HIGH BAY (EQUAL TO ILP #RB4-14L-U-35-BLK-FRL)

#### **MECHANICAL - ELECTRICAL PLAN GENERAL NOTES:**

- 1. ALL ITEMS LABELED AS EXISTING ARE TO REMAIN IN SERVICE. 2. REFER TO 1974 PRINTS FOR APPROXIMATE EXISTING CONDITIONS. IT IS THE CONTRACTOR'S RESPONSIBILITY TO REVIEW THE SITE & UNDERSTAND THE SCOPE OF WORK. NO CHANGE ORDERS WILL BE PAID FOR CONTRACTOR'S FAILURE TO UNDERSTAND COMPLETE SCOPE OF WORK. THE INTENT OF THIS PROJECT IS TO REMOVE ALL MATERIALS BACK TO THE ORIGINAL STRUCTURE.
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- ALARM DEVICES. 2.2. ALL HVAC BRANCH DUCTWORK IS TO BE REMOVED BACK TO MAIN TRUNKS (SUPPLY & RETURN).
- 2.3. ALL EXHAUST DUCTWORK IS TO BE REMOVED. ANY EXTERIOR PENETRATIONS SHALL BE PATCHED.
- 2.4. ALL EXISTING STEAM & CHILLED WATER PIPING SHALL REMAIN IN SERVICE. 2.5. ALL ABOVE GRADE PLUMBING NOT CONCEALED IN WALLS SHALL BE DEMOLISHED.
- 2.6. EXISTING WATER SERVICE ENTRANCE & METERING SHALL REMAIN.
- 2.7. ALL SEWER LINES SHALL BE CAPPED AT FLOORS OR WALLS WITH GAS-TIGHT CAPS.
- 3. CONTRACTOR SHALL INSTALL NEW 20 AMP SINGLE POLE BREAKER IN EXISTING PANEL THIS FLOOR TO POWER TEMPORARY EMERGENCY LIGHTING. 4. HANG TEMPORARY LIGHTS 6" BELOW CEILING STRUCTURE. FEED ALL TEMPORARY LIGHT FIXTURES FROM SAME
- CIRCUIT AS TEMPORARY EMERGENCY LIGHTING. 5. ALL WIRING MAY BE DONE IN MC CABLE STRAPPED TO STRUCTURE.

### MECHANICAL ELECTRICAL PLAN KEY NOTES:

1 INSTALL NEW SWITCH TO CONTROL TEMPORARY LIGHTING FIXTURES (MARK 'TL') ON THIS LEVEL. (2) CONTRACTOR SHALL INSTALL QUAD RECEPTACLE BELOW EXISTING PANEL TO SERVE AS TEMPORARY POWER.





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SHEET TITLE

NICAL

MECHANICAL **ELECTRICAL PLAN -**SECOND FLOOR



#### DEFERRED SUBMITTAL NOTES

- 1. FIRE ALARM CONTRACTOR SHALL PROVIDE SHOP DRAWINGS FOR FIRE ALARM SYSTEM. SUBMITTAL SHALL INCLUDE BATTERY CALCULATIONS, VOLTAGE DROP CALCULATIONS, EQUIPMENT SPECIFICATIONS FOR DEVICES AND PANELS, ETC.
- 2. FIRE ALARM SYSTEM COMPONENTS SHOWN (IF APPLICABLE) ARE GENERAL AND SCHEMATIC IN NATURE, SHOWN FOR APPROXIMATE ROUGH-IN LOCATIONS AND QUANTITIES ONLY. SYSTEM SHALL BE DESIGNED FOR AN UNOCCUPIED BUILDING / BUILDING SHELL.
- 3. FIRE ALARM SHALL BE INSTALLED PRIOR TO DEMOLITION & SHALL BE INSTALLED SO EACH FLOOR CAN BE TAKEN OFFLINE INDEPENDENT OF EACH OTHER.

#### FIRE ALARM SYSTEM SPECIFICATIONS

- 1. FIRE ALARM SYSTEM SHALL BE AN ADDRESSABLE SYSTEM THAT IS NONCODED, UL-LISTED, WITH MULTIPLEX
- SIGNAL TRANSMISSION AND HORN/STROBE EVACUATION. 2. EVERY FIRE ALARM SYSTEM COMPONENT SHALL BE UL-LISTED AND UL-CERTIFIED, TESTED BY MANUFACTURERS AS A COMPLETE SYSTEM, AND MEET ALL APPLICABLE REQUIREMENTS OF NFPA 72.
- 3. ALL FIRE ALARM WIRING TO BE PLENUM RATED. 4. ALL INITIATING DEVICES INSTALLED IN UNCONDITIONED SPACES SHALL BE CONVENTIONAL DEVICES
- SUITABLE FOR USE IN EXTREME HIGH AND LOW TEMPERATURES AND HIGH HUMIDITY. SUCH DEVICES SHALL BE SUPERVISED BY ADDRESSABLE MONITOR MODULES LOCATED IN CONDITIONED SPACES. 5. QUANTITIES, TYPES, AND LOCATIONS OF INITIATING DEVICES AND OUTPUT MODULES FOR
- INTERCONNECTION WITH FIRE SUPPRESSION MUST BE COORDINATED WITH CONTRACTORS THAT ARE RESPONSIBLE FOR THOSE SYSTEMS.

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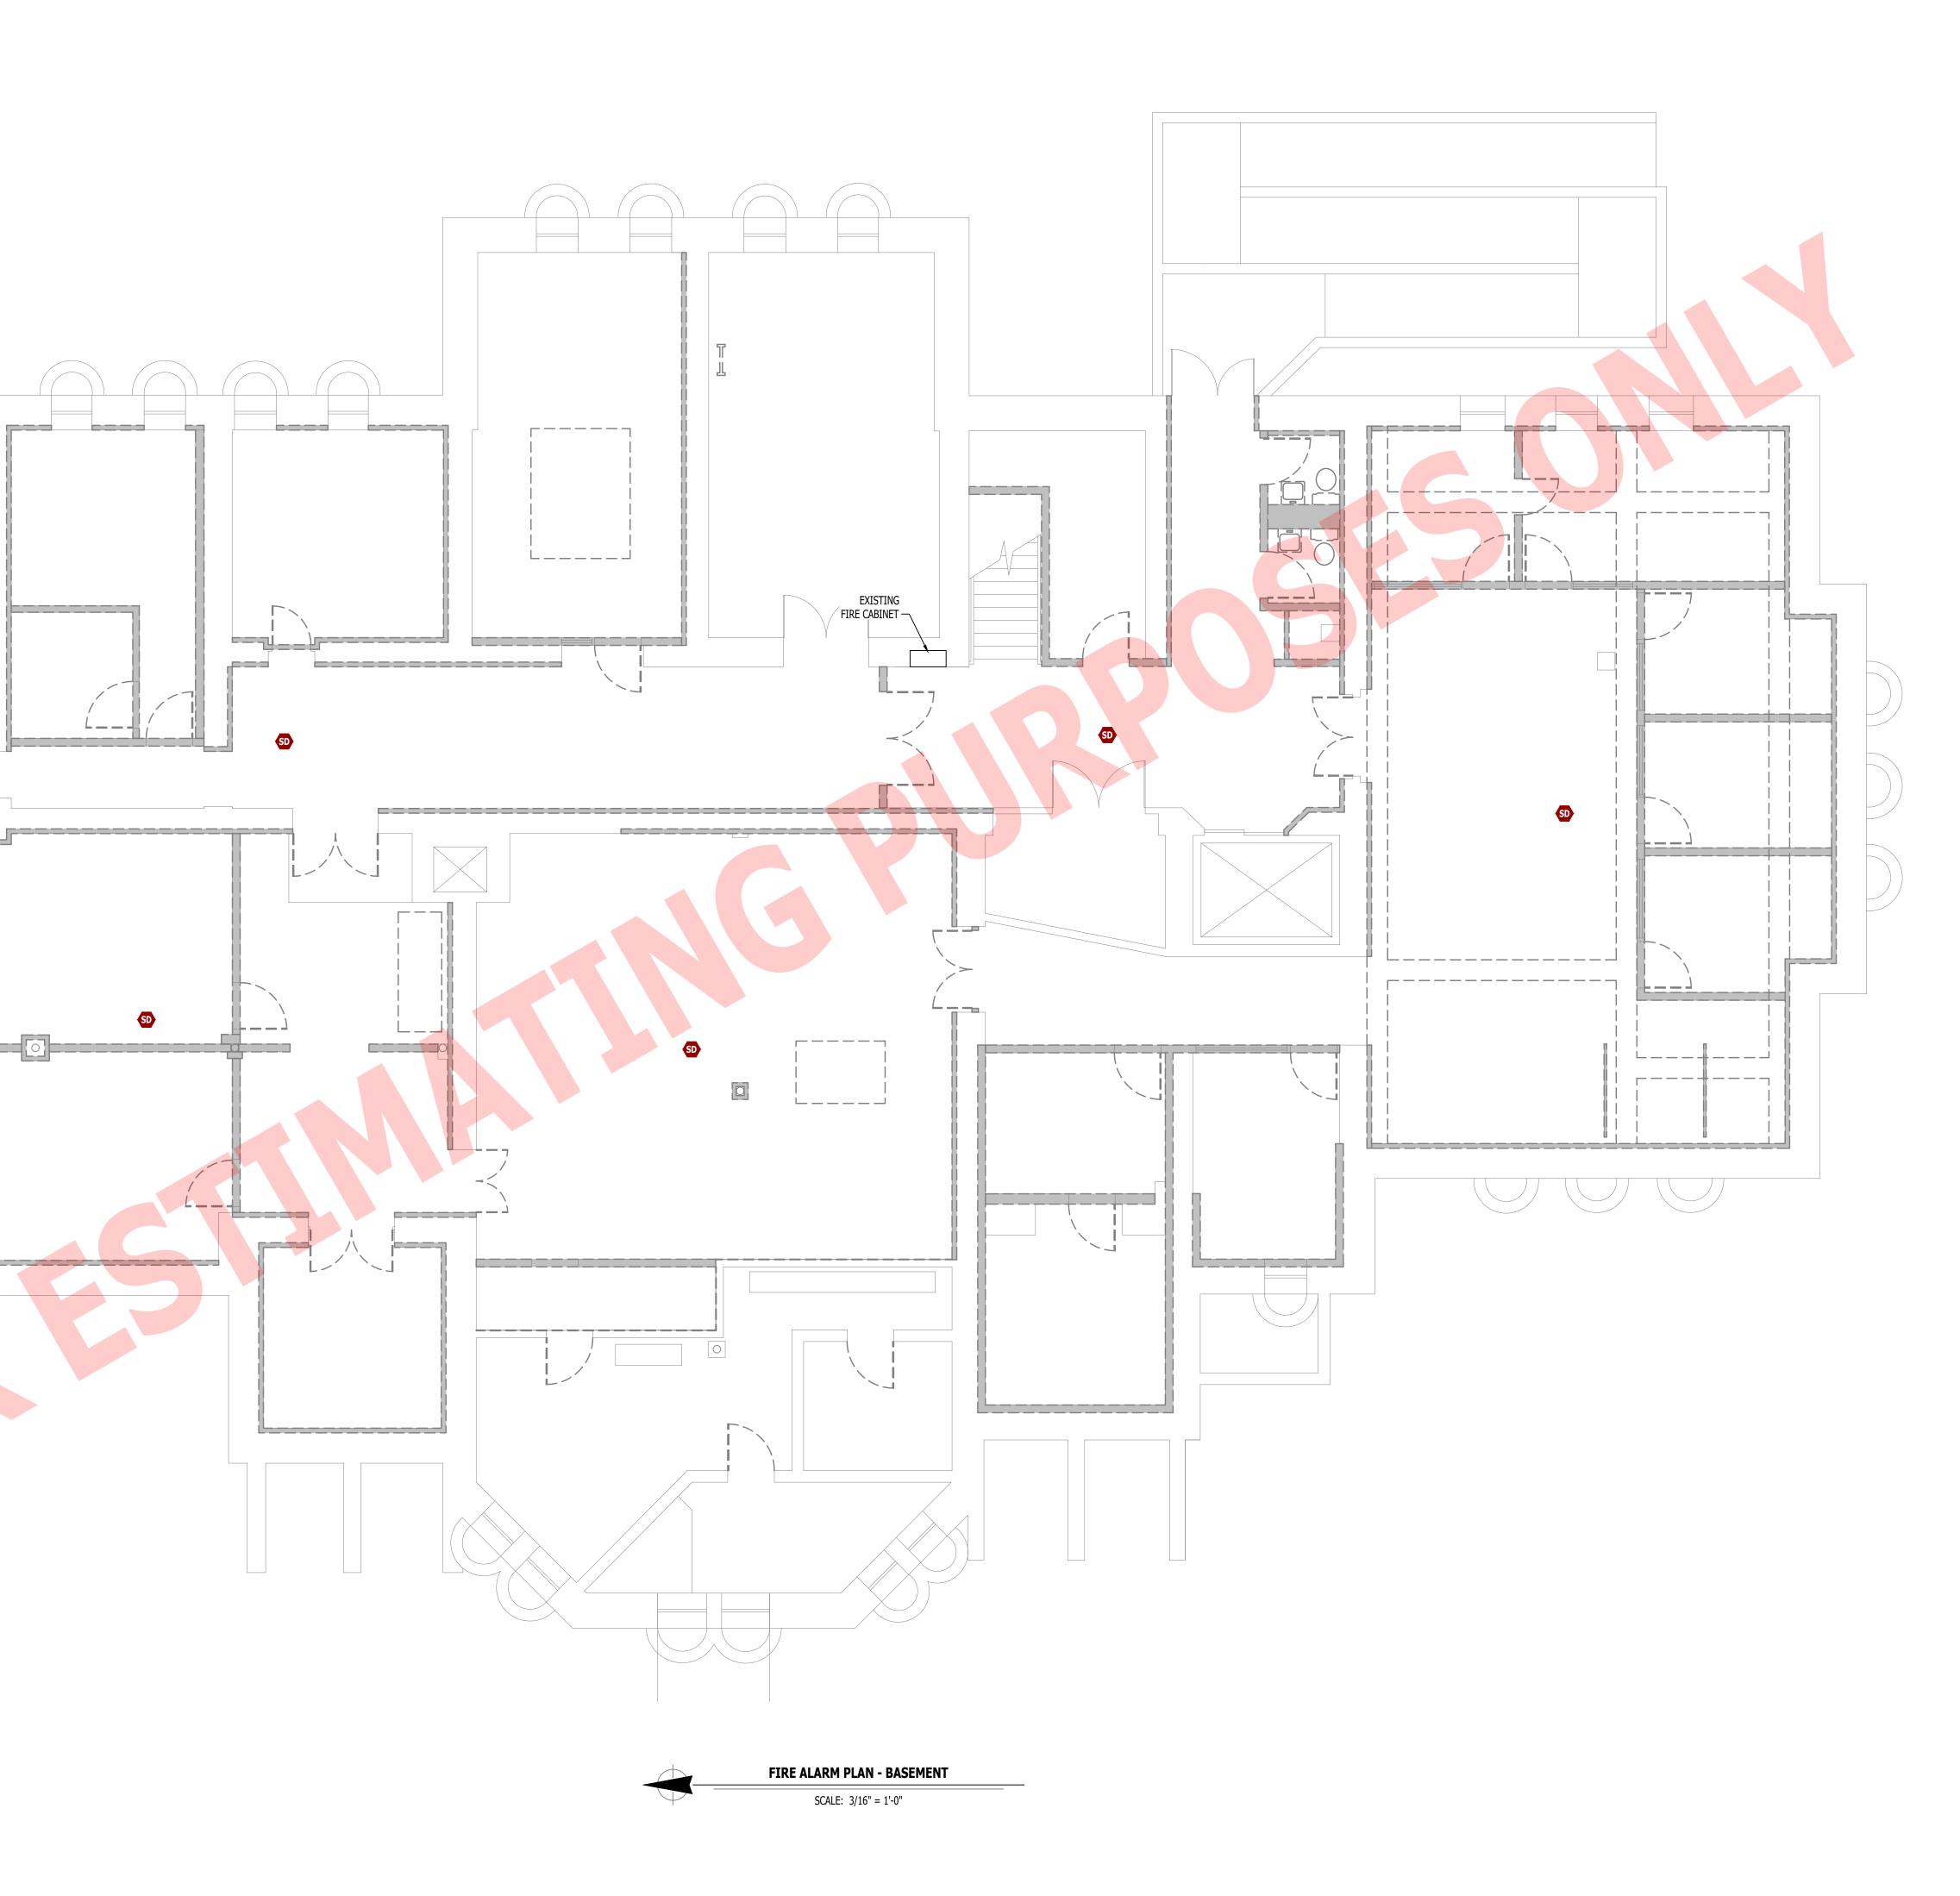
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SD

#### FIRE ALARM PLAN SYMBOL LEGEND

F	MANUAL PULL STATION
Μ	MODULE
Ο	OUTPUT MODULE
SD	SMOKE DETECTOR
	HEAT DETECTOR
CO	CARBON MONOXIDE DETECTOR
S	STROBE - CEILING MOUNT
<u>s</u>	STROBE - WALL MOUNT
HS	HORN STROBE - WALL MOUNT
Ĭ	HORN STROBE - CEILING MOUNT
SS	SPEAKER STROBE - WALL MOUNT
ŠŠ	SPEAKER STROBE - CEILING MOUNT
T	TAMPER SWITCH
WF	WATER FLOW SWITCH
FACP	FIRE ALARM CONTROL PANEL
ANN	FIRE ALARM ANNUNCIATOR

SCALE:  $\frac{3}{16}$ " = 1'-0" 0' 4'-0" 8'-0" 16'-0"







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FIRE ALARM PLAN -BASEMENT



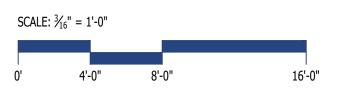
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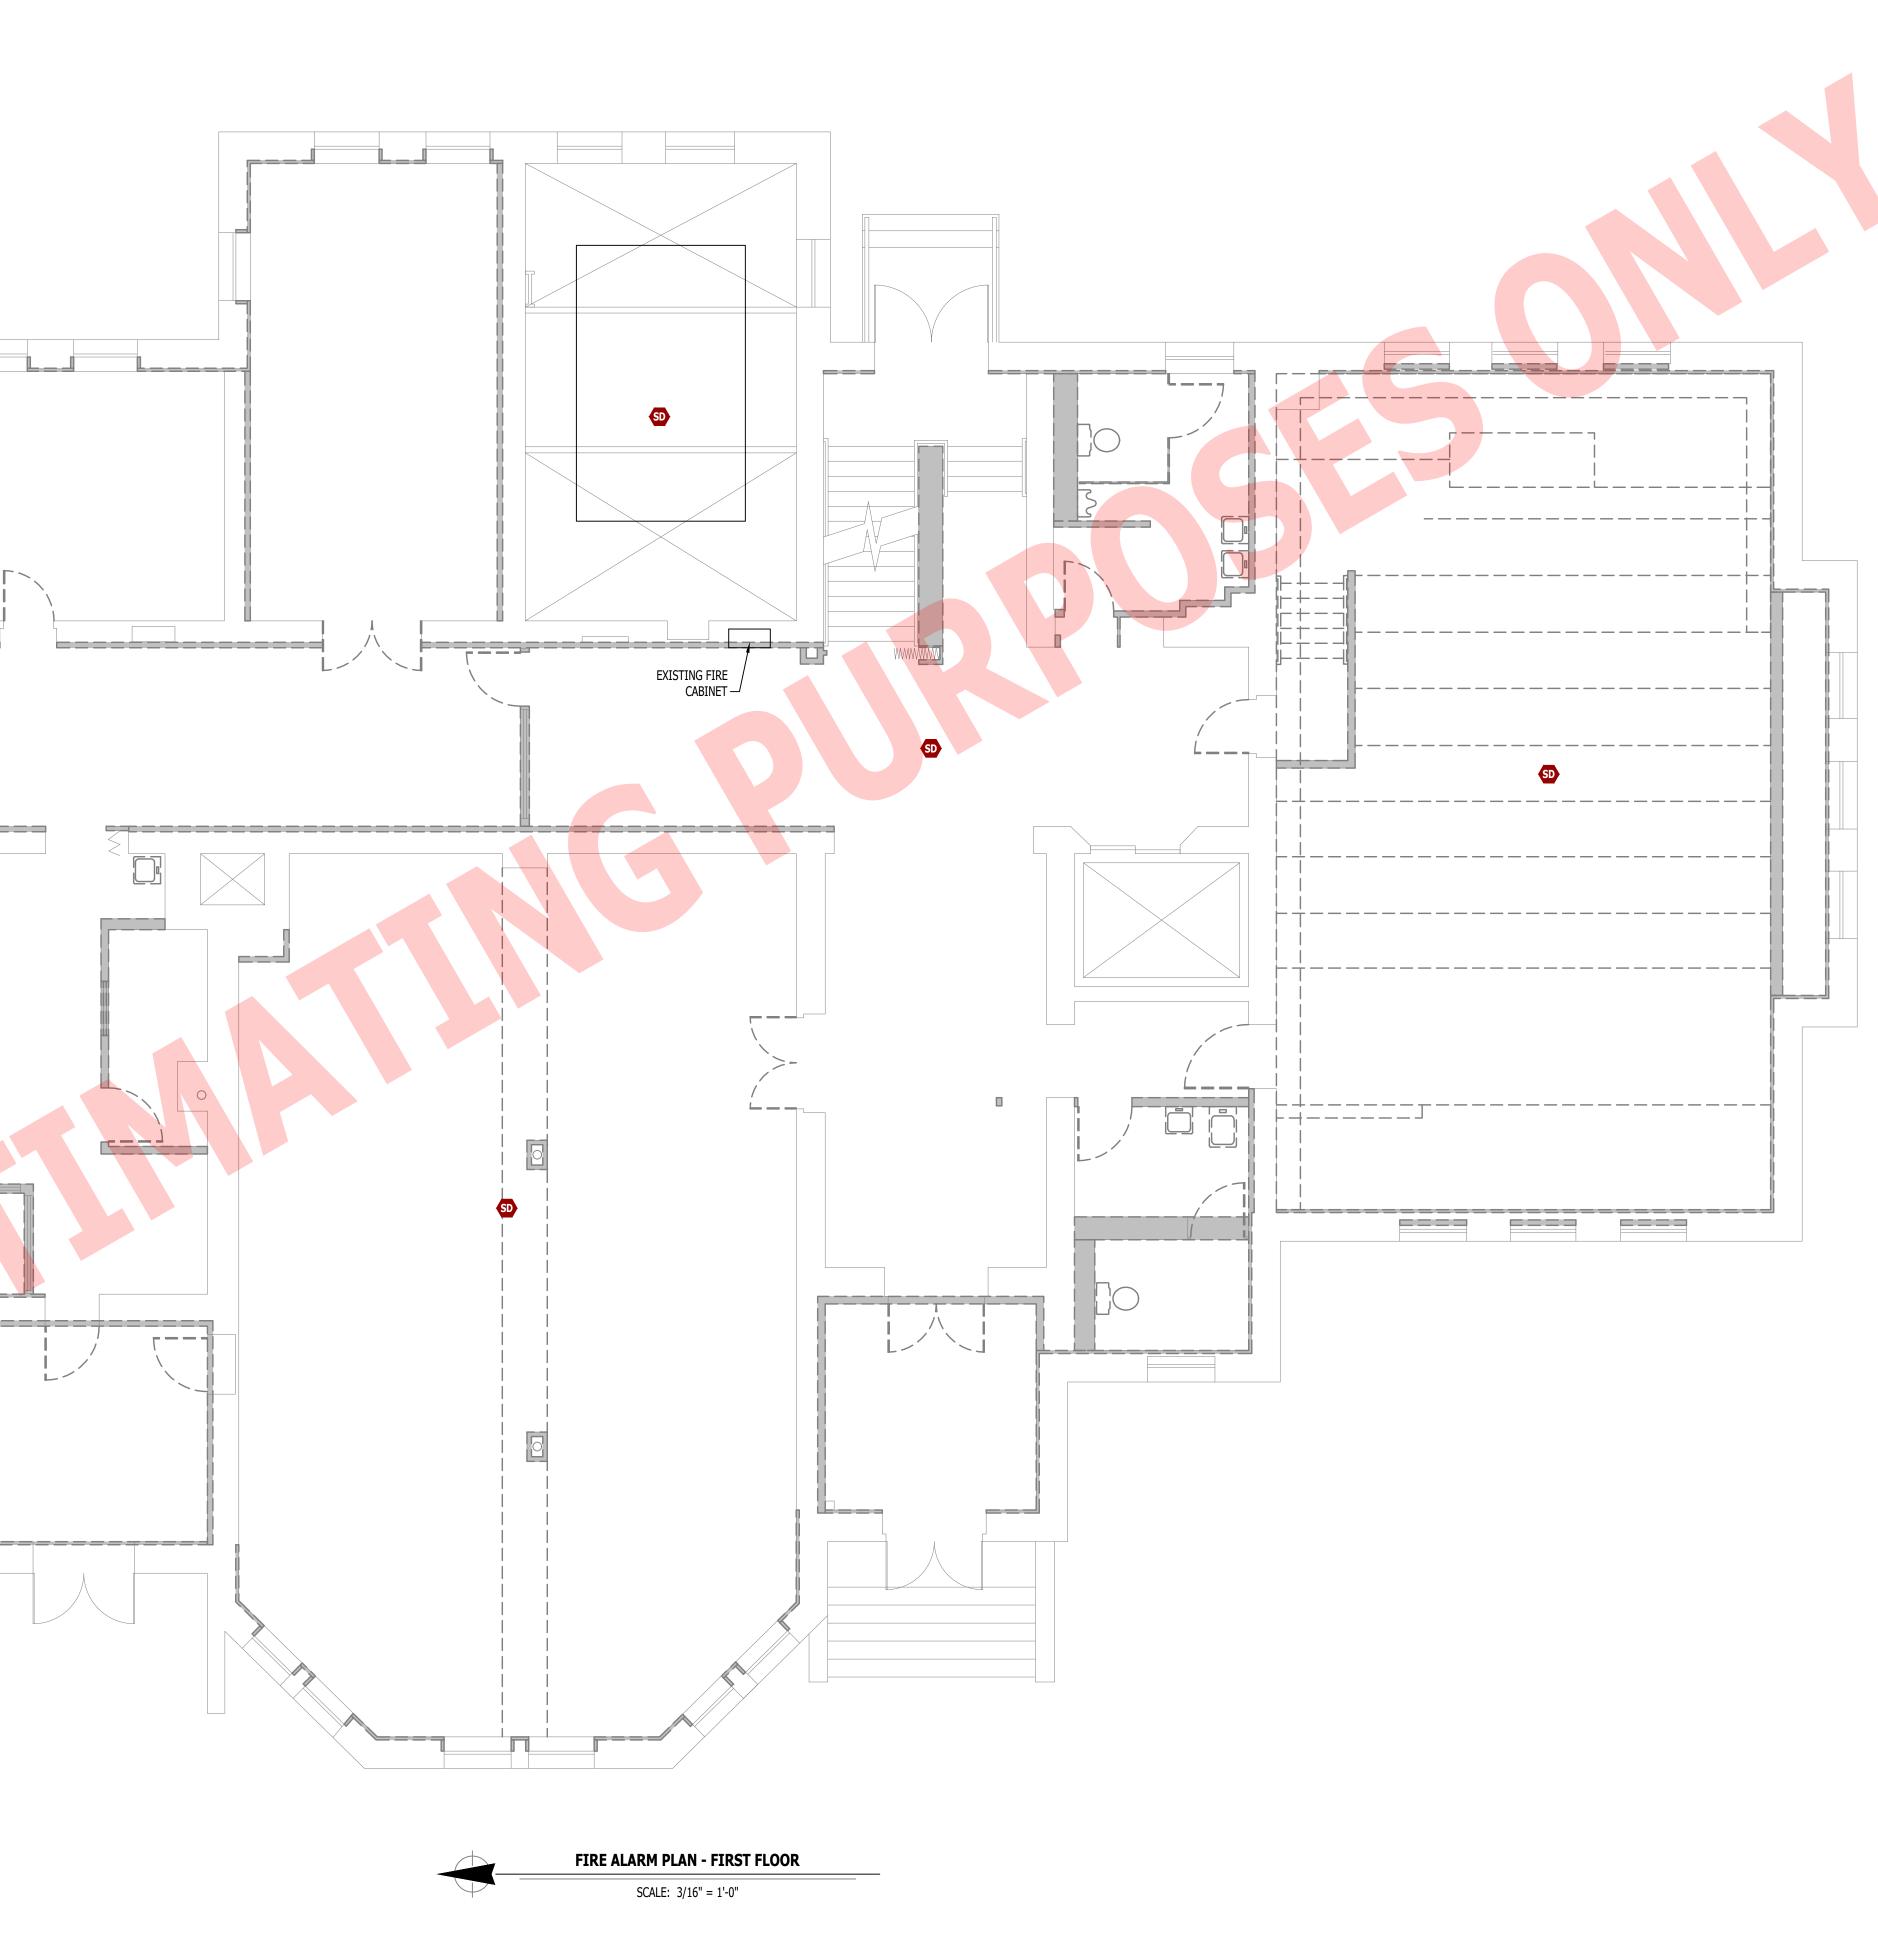
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F	MANUAL PULL STATION	
1	MODULE	
	OUTPUT MODULE	
	SMOKE DETECTOR	
	HEAT DETECTOR	
•	CARBON MONOXIDE DETECTOR	
	STROBE - CEILING MOUNT	
•	STROBE - WALL MOUNT	
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I	SPEAKER STROBE - WALL MOUNT	ÉXISTING FIRE ALARM CONTROL PANEL. CONTRACTOR TO UTILIZE EXISTING CONTROL PANEL IF POSSIBLE.
	SPEAKER STROBE - CEILING MOUNT	
	TAMPER SWITCH	
	WATER FLOW SWITCH	
P	FIRE ALARM CONTROL PANEL	
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FIRE ALARM PLAN -FIRST FLOOR



#### DEFERRED SUBMITTAL NOTES

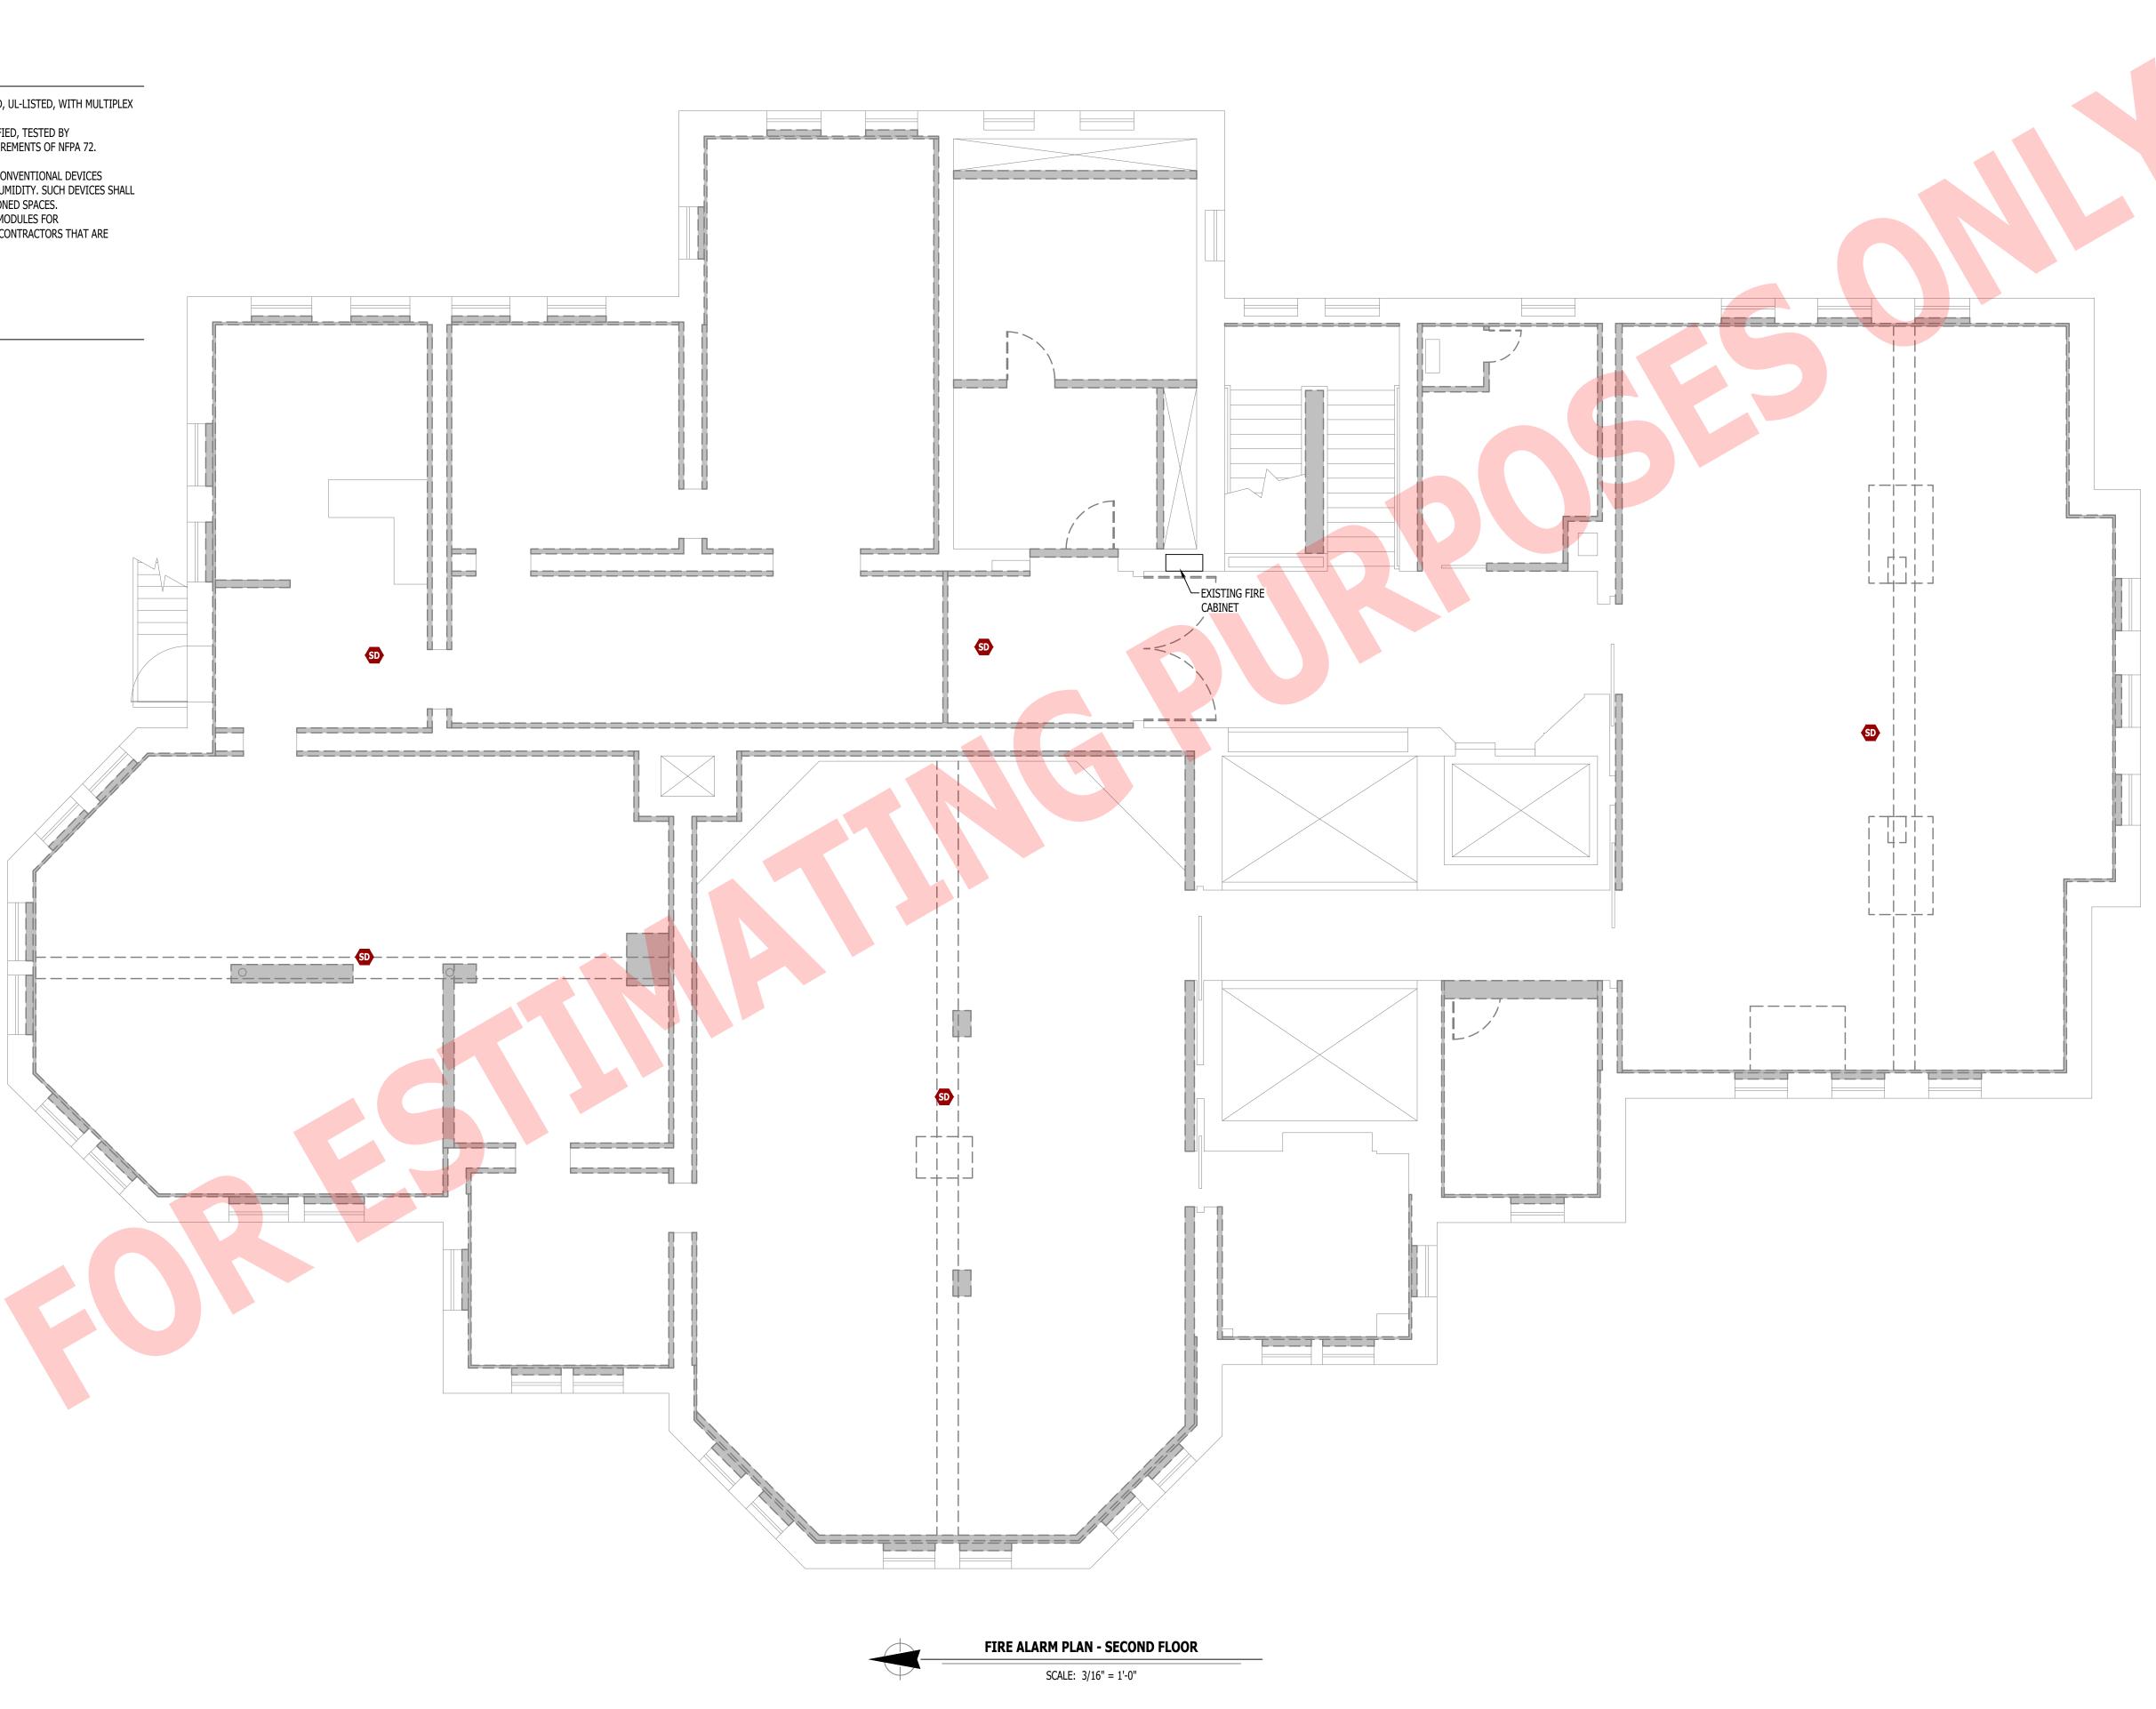
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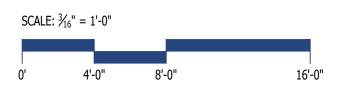
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FIRE ALARM PLAN -SECOND FLOOR

