CP222681 GS FOOTBALL PRACTICE FIELD LIGHTING

UNIVERSITY OF MISSOURI - COLUMBIA FOR THE CURATORS OF THE UNIVERSITY OF MISSOURI

ISSUED INFORMATION

BID DOCUMENTS 10/06/2022

DRAWING INDEX

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V1.01 BOUNDARY & TOROGRAP

V1.01 BOUNDARY & TOPOGRAPHIC SURVEY V1.02 BOUNDARY & TOPOGRAPHIC SURVEY V1.03 BOUNDARY & TOPOGRAPHIC SURVEY V1.04 BOUNDARY & TOPOGRAPHIC SURVEY V1.05 BOUNDARY & TOPOGRAPHIC SURVEY

C1.01 SITE PLAN
C1.02 SITE PLAN
C2.01 CONSTRUCTION ACCESS

DETAILS


ELECTRICAL LEGEND AND NOTES
ELECTRICAL SITE PLAN
ELECTRICAL ONE-LINE DIAGRAM
PHOTOMETRIC CALCULATIONS

"I hereby certify these drawings and/or specifications have been prepared by me, or under my supervision. I further certify that to the best of my knowledge these drawings and/or specifications are as required by and in compliance with the Building Codes of the

ELECTRICAL ENGINEER OF RECORD

"I hereby certify these drawings and/or specifications have been prepared by me, or under my supervision. I further certify that to the best of my knowledge these drawings and/or specifications are as required by and in compliance with the Building Codes of the University of Missouri"

Benjami a Ross

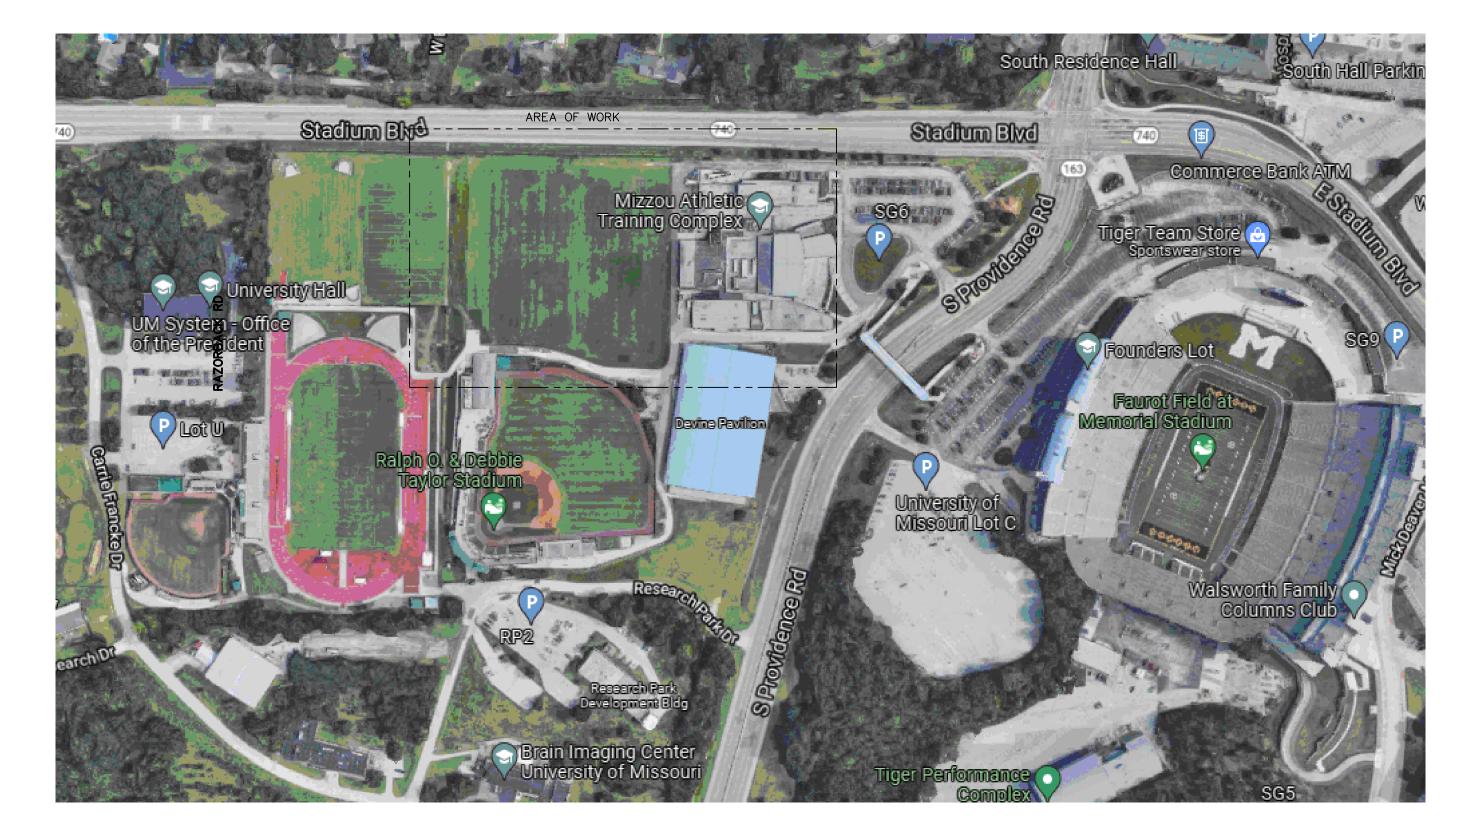

KEY PLAN



HENDERSON ENGINEERS

KANSAS CITY, MO 64108 TEL 816.663.8700 FAX 816.663.8701





Missouri Engineering Corp. # 2004005018

Project
CP222681 GS FOOTBALL
PRACTICE FIELD

UNIVERSITY OF
MISSOURI - COLUMBIA
FOR THE CURATORS OF
THE UNIVERSITY OF
MISSOURI


CODES:

2021 INTERNATIONAL BUILDING CODE 2021 INTERNATIONAL EXISTING BUILDING CODE 2020 NATIONAL ELECTRICAL CODE 2019 ASHRAE 90.1 ENERGY CODE

GENERAL NOTES:

1. THESE NOTES APPLY TO ALL TRADES.

- 2. CONTRACTOR SHALL REPAIR ALL DAMAGE TO EXITING BUILDING, FIXTURES, AND FINISHES CAUSED BY CONTRACTOR DURING THE PERFORMANCE OF THE WORK. REPAIRS SHALL BE PERFORMED BY QUALIFIED TRADESMEN AND SHALL BE COMPLETED IN A MANNER ACCEPTABLE TO THE OWNER/ENGINEER.
- 3. CONTRACTOR SHALL INSPECT THE SITE PRIOR TO THE SUBMISSION OF A BID. CONTRACTOR SHALL INFORM THEMSELVES OF THE CONDITIONS UNDER WHICH THE WORK IS TO BE PERFORMED CONCERNING THE SITE OF THE WORK, THE OBSTACLES WHICH MAY BE ENCOUNTERED, THE DEMOLITION AND TEMPORARY REMOVAL AND REINSTALLATION REQUIRED TO PROVIDE ACCESS TO THE WORK, AND ALL OTHER RELEVANT MATTERS CONCERNING THE WORK TO BE PERFORMED. CONTRACTOR SHALL NOT BE ALLOWED ANY EXTRA COMPENSATION BY REASON OF ANY MATTER WHICH CONTRACTOR SHOULD HAVE INFORMED THEMSELVES PRIOR TO THE SUBMISSION OF A BID.
- 4. THE DRAWINGS REPRESENT THE BEST INFORMATION AVAILABLE TO THE ENGINEER. ALL DIMENSIONS AND SIZES SHALL BE FIELD VERIFIED. DO NOT SCALE FROM DRAWINGS. SMALL DEVIATIONS BETWEEN THE DRAWINGS AND ACTUAL CONDITIONS ENCOUNTERED SHALL BE RECONCILED DURING THE PERFORMANCE OF THE WORK AND SHALL NOT CONSTITUTE REASON FOR ADDITIONAL COMPENSATION TO THE
- 5. CONTRACTOR SHALL NOTIFY CONSTRUCTION MANAGER/ENGINEER AND REQUEST INSTRUCTIONS SHOULD ACTUAL CONDITIONS DEVIATE SUBSTANTIALLY FROM THOSE INDICATED ON THE DRAWINGS.
- 6. ALL FEES AND ANY OTHER COSTS TO UTILITY COMPANIES, MUNICIPALITIES, INSPECTORS, REVIEWING AGENCIES, ETC. ARE TO BE INCLUDED AS PART OF THIS CONTRACT.

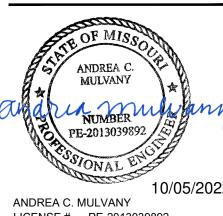

ANDREA C. MULVANY LICENSE # PE-2013039892 PROFESSIONAL SEAL

REVISIONS

JOB NO: CP222681
DATE: 10-06-22

ACM

COVER SHEET

CHECKED BY:

DRAWN BY:

GO

GS FOOTBALL PRACTICE FIELD LIGHTING



COLUMBIA, BOONE COUNTY, MISSOURI SITE PLAN OCTOBER 6, 2022

UTILITY NOTES

ALL UTILITIES ARE UNIVERSITY OF MISSOURI, EXCEPT AS NOTED BELOW. THE LOCATIONS, SIZES, AND MATERIAL TYPES OF UNDERGROUND UTILITIES INDICATED ON THE PLAT, NOT VISIBLE OR APPARENT FROM THE SURFACE, ARE SHOWN IN THEIR APPROXIMATE LOCATIONS FROM A MISSOURI ONE CALL SYSTEM LOCATE, OR UTILITY COMPANY RECORDS AND WERE NOT VERIFIED IN THE FIELD. IRRIGATION LINES WERE NOT LOCATED. UNDERGROUND ELECTRIC LINES TO LIGHTS WERE NOT LOCATED.

UNIVERSITY OF MISSOURI
ENERGY MANAGEMENT OFFICE
417 SOUTH FIFTH STREET
COLUMBIA, MISSOURI 65211
CONTACT: 573-882-3094

ELECTRIC, TELECOMMUNICATIONS, STEAM, WATER, CHILLED WATER, SANITARY SEWER, STORM SEWER

WATER

CITY OF COLUMBIA WATER & LIGHT DEPARTMENT
P.O. BOX 6015

COLUMBIA, MISSOURI 65205

CONTACT: JOE STRODTMAN 573-874-6308

ELECTRIC CITY OF COLUMBIA WATER & LIGHT DEPARTMENT P.O. BOX 6015 COLUMBIA, MISSOURI 65205

CONTACT: DAN CLARK 573-874-7738

NONE WITHIN SURVEYED AREA

AS

AMEREN MISSOURI

2001 MAGUIRE BOULEVARD

COLUMBIA, MISSOURI 65201

CONTACT: TRENT SNODGRASS 573-876-3063

TELECOMMUNICATIONS

CENTURYLINK
625 E. CHERRY STREET

COLUMBIA, MISSOURI 65201

CONTACT: DUANE McGEE 573-886-3503

LINES ARE UNIVERSITY OF MISSOURI AS SHOWN

MEDIACOM
901 N. COLLEGE AVENUE
COLUMBIA. MISSOURI 65201

CONTACT: BOB BONER 573-443-1536

NONE WITHIN SURVEYED AREA

SANITARY SEWER
CITY OF COLUMBIA UTILITIES DEPARTMENT
P.O. BOX 6015
COLUMBIA, MISSOURI 65205

CONTACT: STEVE HUNT 573-874-7250
NONE WITHIN SURVEYED AREA

STORM SEWER
CITY OF COLUMBIA UTILITIES DEPARTMENT
P.O. BOX 6015

COLUMBIA, MISSOURI 65205

DDOT


MoDOT — CENTRAL DISTRICT
P.O. BOX 718
1511 MISSOURI BOULEVARD
JEFFERSON CITY, MISSOURI 65102
CONTACT: JOHN KUHLMAN 573-522-6806

STORM SEWER ALONG STADIUM BOULEVARD

CONTACT: TOM WELLMAN 573-874-7250 NONE WITHIN SURVEYED AREA

STORM WATER POLLUTION PREVENTION PLAN NOTES

- 1. NO LAND CLEARING OR GRADING SHALL BEGIN UNTIL ALL EROSION CONTROL MEASURES HAVE BEEN INSTALLED AND APPROVAL HAS BEEN RECEIVED FROM ALL GOVERNING AUTHORITIES.
- 2. IMMEDIATELY UPON COMPLETION OF FINISH GRADING IN EACH AREA, ALL LANDSCAPING AREAS SHALL BE STABILIZED PER PLANS AND/OR SPECIFICATIONS.
- 3. SHOULD CONSTRUCTION STOP FOR LONGER THAN 14 DAYS, THE SITE SHALL BE TEMPORARILY SEEDED.
- 4. SITE INSPECTION SHOULD OCCUR ON A REGULAR SCHEDULE AND WITHIN 24 HOURS OF A STORM EVENT OF 0.25 INCHES OR GREATER. REGULARLY SCHEDULED INSPECTION SHALL BE A MINIMUM OF ONCE EVERY 7 CALENDAR DAYS. ANY DEFICIENCIES SHALL BE NOTED IN A WEEKLY REPORT OF THE INSPECTION AND CORRECTED WITHIN SEVEN CALENDAR DAYS OF THE REPORT.
- 5. THIS PLAN SHALL NOT BE CONSIDERED ALL INCLUSIVE AS THE CONTRACTOR SHALL TAKE ALL NECESSARY PRECAUTIONS TO PREVENT SOIL SEDIMENT FROM LEAVING THE SITE.
- 6. CONTRACTOR SHALL COMPLY WITH ALL STATE AND LOCAL ORDINANCES THAT APPLY.
- 7. ADDITIONAL EROSION AND SEDIMENT CONTROL MEASURES SHALL BE INSTALLED IF DEEMED NECESSARY BY ON SITE INSPECTION.
- 8. CONTRACTOR SHALL REMOVE ALL TRASH, DEBRIS, TREES & BRUSH AND OTHER MATERIAL CREATED AS A RESULT OF THE CONSTRUCTION WORK AND THE SITE SHALL BE RETURNED TO ITS ORIGINAL CONDITION.
- 9. ALL PERIMETER LANDSCAPED AREAS SHALL BE LEFT SIX INCHES BELOW FINISH GRADE.
- 10. THE SITE CONTRACTOR SHALL INCLUDE MAINTENANCE AND REMOVAL OF ALL BMP'S AS PART OF THEIR CONTRACT AND SHALL BE RESPONSIBLE FOR THE PROJECT UNTIL PROJECT ACCEPTANCE BY OWNER.

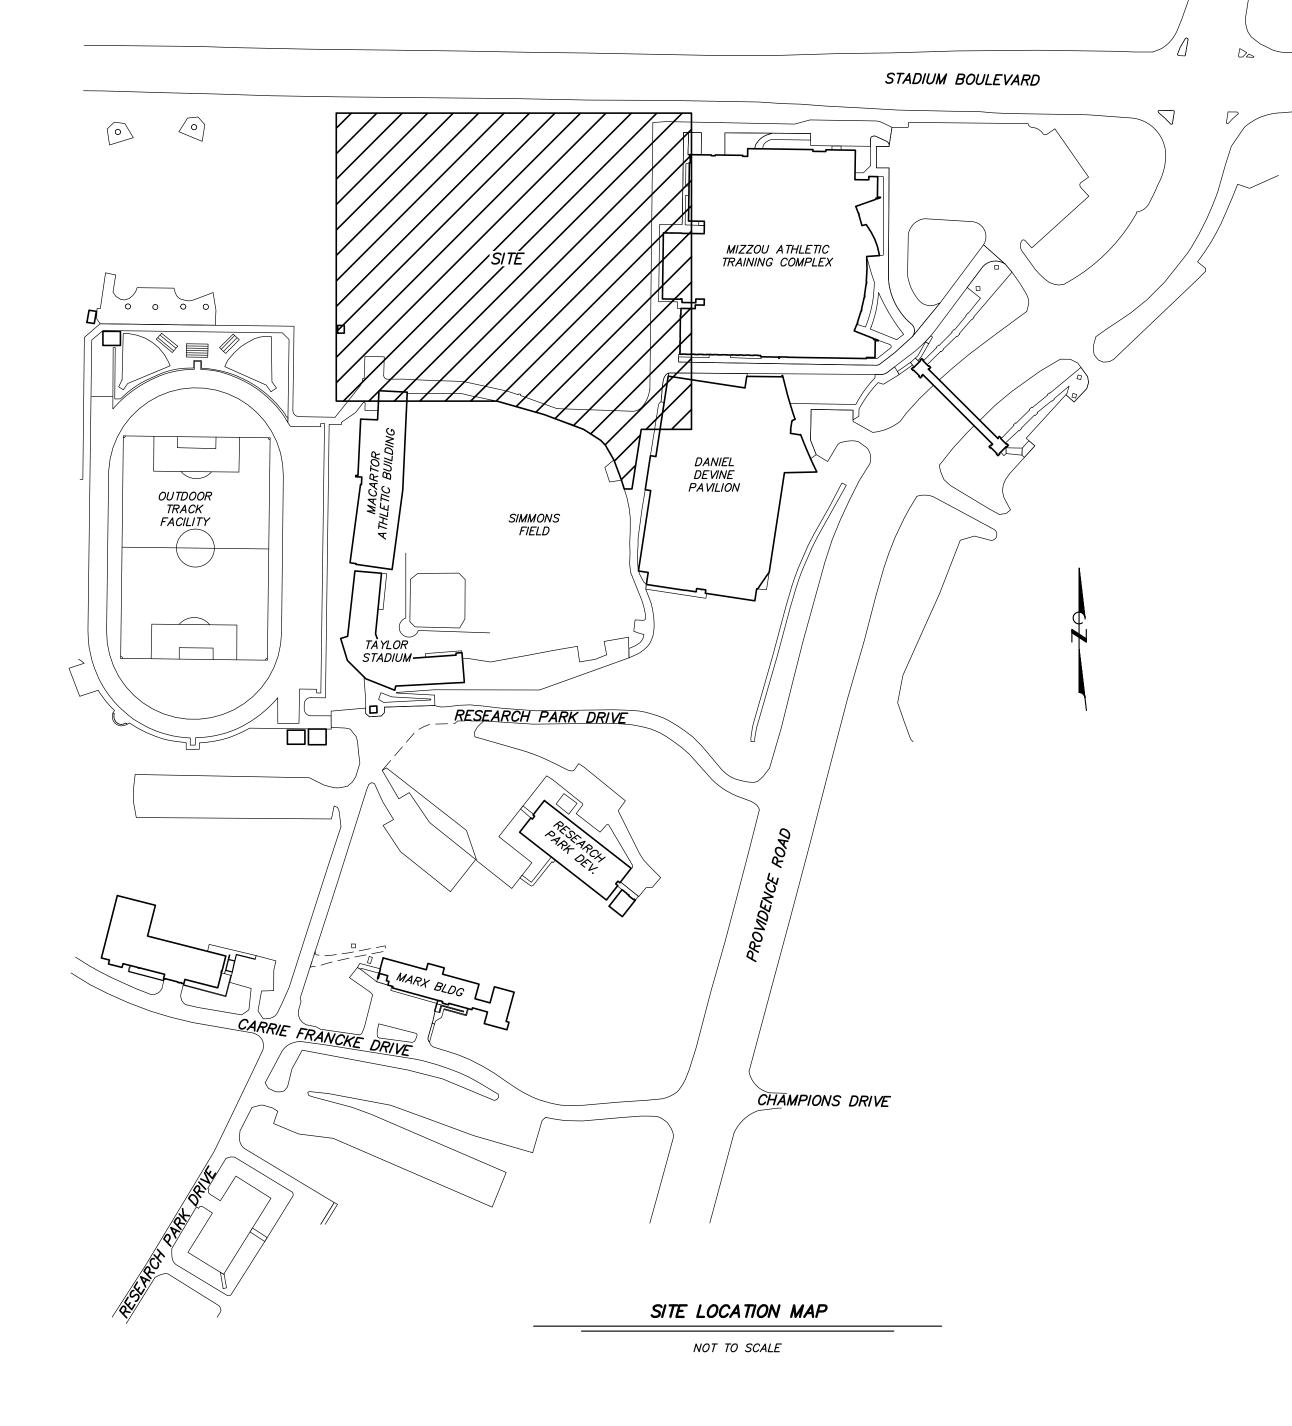

CONSTRUCTION NOTES

- 1. THE CONTRACTOR IS SPECIFICALLY CAUTIONED THAT THE LOCATION AND/OR ELEVATION OF EXISTING UTILITIES AS SHOWN ON THESE PLANS IS BASED ON RECORDS OF THE VARIOUS UTILITY COMPANIES, AND WHERE POSSIBLE, MEASUREMENTS TAKEN IN THE FIELD. THE INFORMATION IS NOT TO BE RELIED ON AS BEING EXACT OR COMPLETE. THE CONTRACTOR MUST CALL THE APPROPRIATE UTILITY COMPANIES AT LEAST 72 HOURS BEFORE ANY EXCAVATION TO REQUEST EXACT FIELD LOCATION OF UTILITIES. IT SHALL BE THE RESPONSIBILITY OF THE CONTRACTOR TO RELOCATE ALL EXISTING UTILITIES WHICH CONFLICT WITH THE PROPOSED IMPROVEMENTS SHOWN ON THE PLANS.
- 2. CONSTRUCTION SHALL COMPLY WITH ALL APPLICABLE GOVERNING CODES AND BE CONSTRUCTED TO SAME.
- 3. ALL TRAFFIC CONTROL SHALL BE PER CURRENT MUTCD REQUIREMENTS AND SHALL BE THE RESPONSIBILITY OF THE CONTRACTOR. A TRAFFIC CONTROL PLAN WILL BE REQUIRED FOR ANY WORK WITHIN THE RIGHT—OF—WAY.
- 4. IF A CONFLICT EXISTS BETWEEN THE CIVIL PLANS AND CIVIL SPECIFICATIONS, THE CIVIL PLANS SHALL GOVERN.
- 5. CONTRACTOR SHALL LIMIT THEIR ACTIVITIES TO ALLOWED ACCESS ROUTES AND SITE LIMITS SHOWN ABOVE UNLESS

6. CONTRACTOR TO INSTALL TEMPORARY CONSTRUCTION FENCE AROUND ALL OPEN EXCAVATIONS.

7. FINISH GRADES AND TOPSOIL PLACEMENT AND SEEDING WILL BE BY OWNER.

UNDERGROUND ELECTRIC LINE HIGH VOLTAGE ELECTRIC LINE UNDERGROUND TELECOMMUNICATIONS LINE SANITARY SEWER LINE SANITARY SEWER FORCE MAIN LINE STORM SEWER LINE STEAM LINE GAS LINE WATER LINE *FENCE* EXISTING CONTOUR TEST BORING CONTROL POINT CAST IRON PIPE CORRUGATED METAL PIPE CORRUGATED PLASTIC PIPE DUCTILE IRON PIPE ELECTRIC METER FIRE HYDRANT FLOW LINE GAS METER HIGH DENSITY POLYETHYLENE PIPE HDPE LIGHT STANDARD POLYVINYL CHLORIDE PIPE REINFORCED CONCRETE PIPE TELECOMMUNICATIONS PEDESTAL TOP OF WALL UNDERGROUND ROOF DRAIN VITRIFIED CLAY PIPE WATER METER WATER VALVE PROPOSED FIELD LIGHT SILT FENCE PLAYING FIELD LIMITS - AREAS OFF LIMITS

LEGEND

BENCH MARK

- BM NGS BRASS PLATE STAMPED "UNIVERSITY OF MISSOURI RESET, 2005" IN A
 CONCRETE HEADWALL FOR A SPOTLIGHT LOCATED 30 FEET SOUTHWEST OF THE
 WEST COLUMN IN THE FRANCIS QUADRANGLE.
 FLEVATION = 743.60
- TBM 1 CHISELED SQUARE AT THE NORTHEAST CORNER OF CONCRETE SWITCHGEAR PAD LOCATED 40 FEET NORTHWEST OF THE NORTHWEST CORNER OF MACARTOR ATHLETIC BUILDING.

 ELEVATION = 717.64
- TBM 2 CHISELED "+" ON THE WEST BASE BOLT OF LIGHT STANDARD LOCATED 190
 FEET SOUTHWEST OF THE NORTHWEST CORNER OF DANIEL J. DEVINE ATHLETIC

PAVILION AND 60 FEET SOUTHEAST OF BASEBALL FIELD SCORE BOARD.

TBM 3 — CHISELED SQUARE AT THE NORTHWEST CORNER OF CONCRETE TRANSFORMER
PAD LOCATED 100 FEET SOUTHWEST OF THE NORTHWEST CORNER OF MIZZOU

ELEVATION = 721.18

ELEVATION = 720.70

SURVEY CONTROL POINTS

<u>POINT #</u>	<u>NORTH</u>	<u>EAST</u>	ELEVATION	<u>DESCRIPTION</u>
CP1	1129870.80	1686622.12	720.29	MAG NAIL
CP2	1129908.28	1686402.48	720.32	MAG NAIL
CP3	1130113.76	1686495.72	719.24	MAG NAIL
CP4	1130226.17	1686499.17	719.24	MAG NAIL
CP8	1129962.67	1686750.64	721.06	DRILL HOLE
CP10	1129951.22	1686248.68	719.09	IRON

SHEET INDEX

	COVER
V1.01-V1.05	BOUNDARY & TOPOGRAPHIC SURVEY
C1.01-C1.02	SITE PLAN
C2.01	CONSTRUCTION ACCESS
C3.01	DETAILS

GS FOOTBALL PRACTICE FIELD LIGHTING

HENDERSON ENGINEERS

1801 MAIN STREET, SUITE 300 KANSAS CITY, MO 64108 TEL 816.663.8700 FAX 816.663.8701

MO. CORPORATE NUMBER: E-556D 12/31/22

WWW.HENDERSONENGINEERS.COM




1113 Fay Street, Columbia, Mo 65201 573 - 449 - 2646 www.ess-inc.com MO Land Surveying Corp. # 2004004672

Missouri Engineering Corp. # 2004005018



Project
CP222681 GS FOOTBALL
PRACTICE FIELD
LIGHTING

UNIVERSITY OF MISSOURI - COLUMBIA FOR THE CURATORS OF THE UNIVERSITY OF MISSOURI

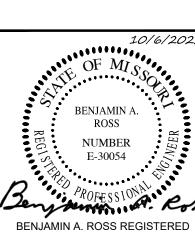

BENJAMIN A. ROSS REGISTERED PROFESSIONAL ENGINEER E-30054 PROFESSIONAL SEAL

REVISIONS

 JOB NO:
 CP220791

 DATE:
 10-06-22

 CHECKED BY:
 BAR

 DRAWN BY:
 CGH

COVER

C0.0

ES&S PROJECT # 15386

FOOTBALL PRACTICE FIELDS LIGHTS

COLUMBIA, BOONE COUNTY, MISSOURI UNIVERSITY OF MISSOURI PROJECT # CP220791 SEPTEMBER 16, 2022



UTILITY NOTES

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UNIVERSITY OF MISSOURI

ENERGY MANAGEMENT OFFICE

417 SOUTH FIFTH STREET

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ELECTRIC, TELECOMMUNICATIONS, STEAM, WATER,

CHILLED WATER, SANITARY SEWER, STORM SEWER

WATER

CITY OF COLUMBIA WATER & LIGHT DEPARTMENT
P.O. BOX 6015

COLUMBIA, MISSOURI 65205

COLUMBIA, MISSOURI 65205 CONTACT: JOE STRODTMAN 573-874-6308 NONE WITHIN SURVEYED AREA

ELECTRIC

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CONTACT: DAN CLARK 573-874-7738

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CENTURYLINK

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MANHOLES & CONDUITS ARE CENTURYLINK,
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MEDIACOM

SANITARY SEWER

901 N. COLLEGE AVENUE

CITY OF COLUMBIA UTILITIES DEPARTMENT P.O. BOX 6015 COLUMBIA, MISSOURI 65205 CONTACT: STEVE HUNT 573-874-7250

NONE WITHIN SURVEYED AREA

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CORM SEWER


CITY OF COLUMBIA UTILITIES DEPARTMENT
P.O. BOX 6015


COLUMBIA, MISSOURI 65205

CONTACT: TOM WELLMAN 573-874-7250

MODO I

MODOT — CENTRAL DISTRICT
P.O. BOX 718
1511 MISSOURI BOULEVARD
JEFFERSON CITY, MISSOURI 65102
CONTACT: JOHN KUHLMAN 573—522—6806
STORM SEWER ALONG STADIUM BOULEVARD

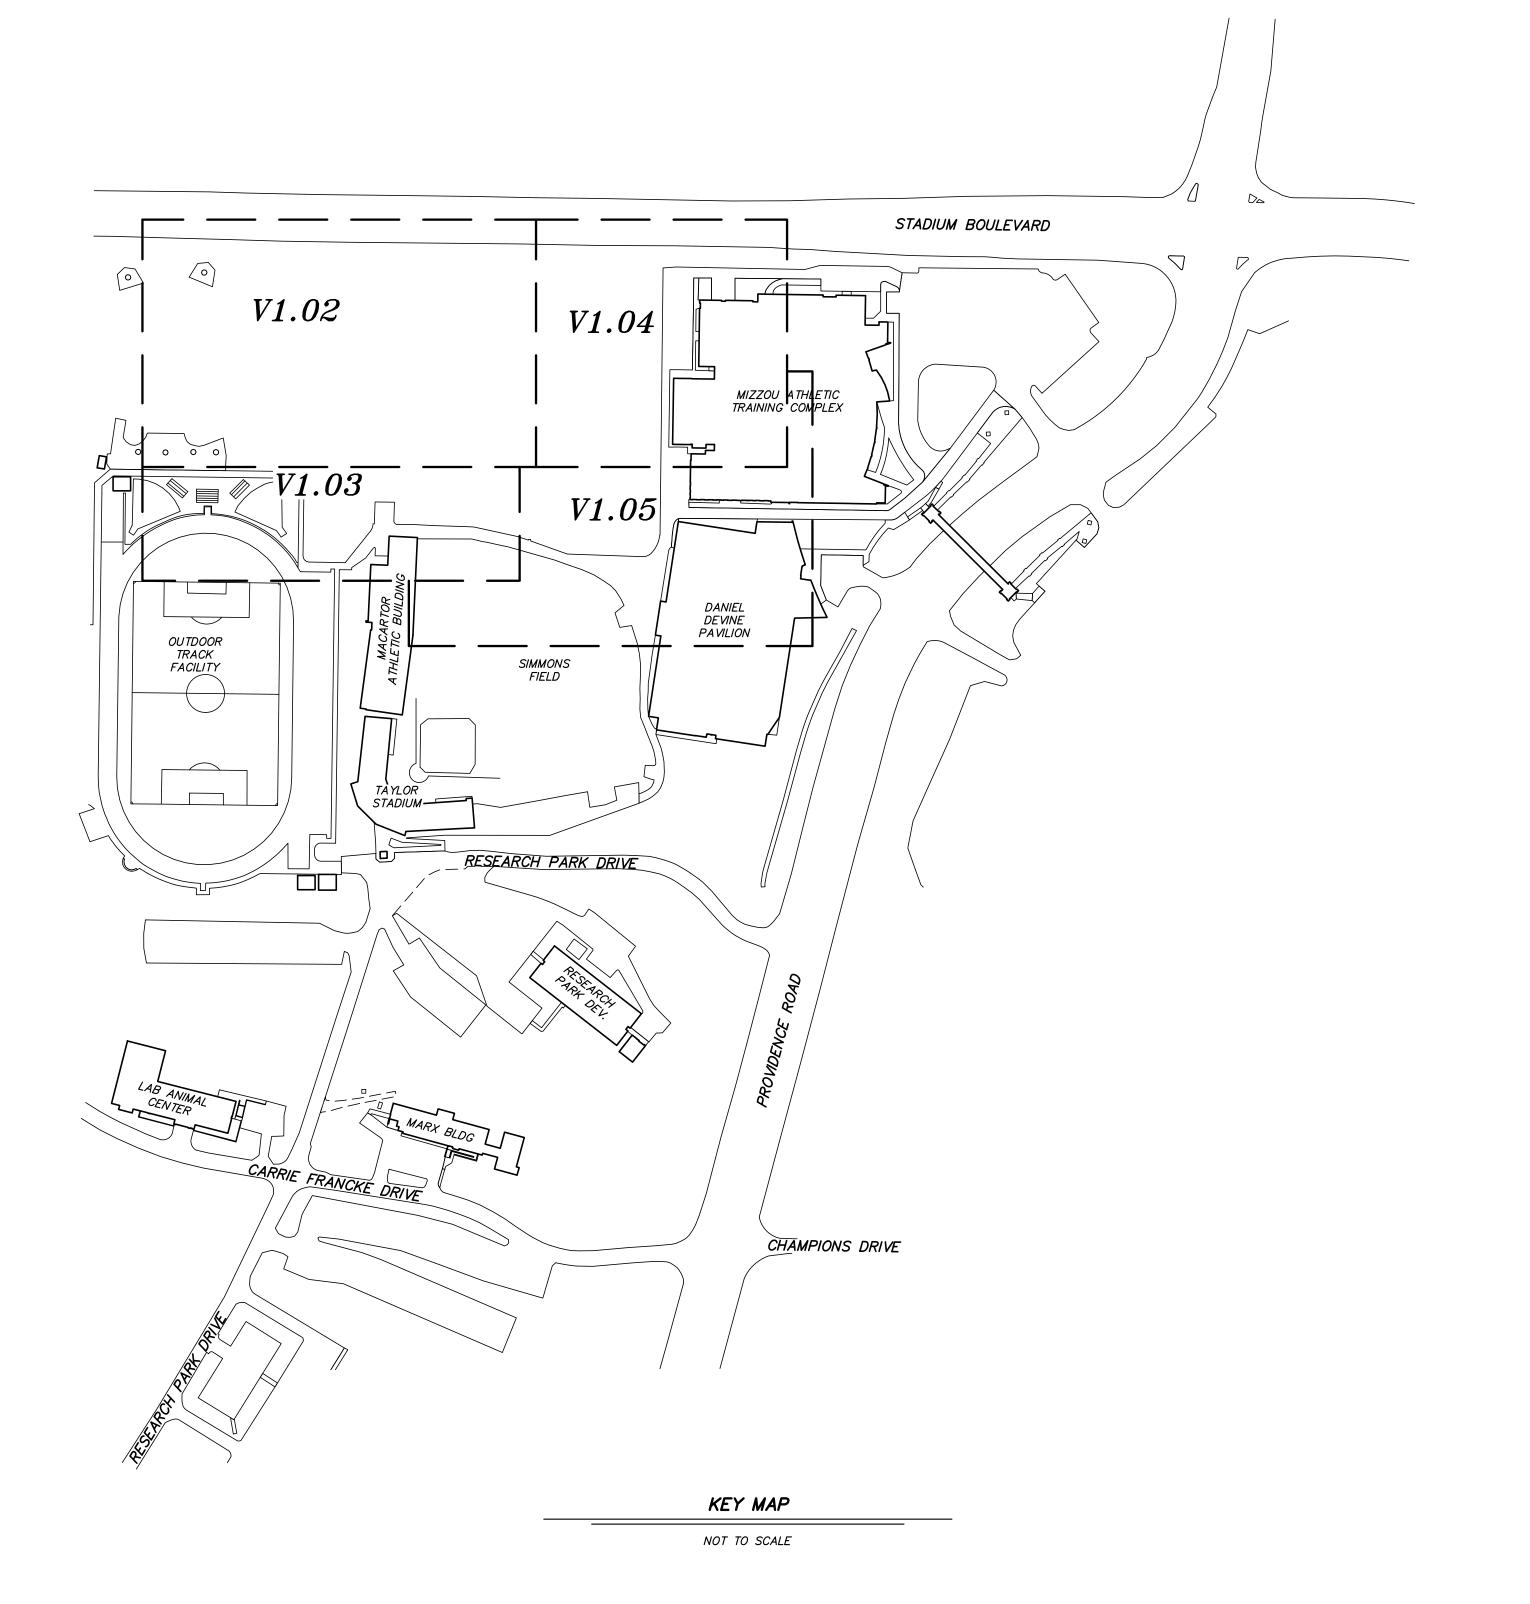

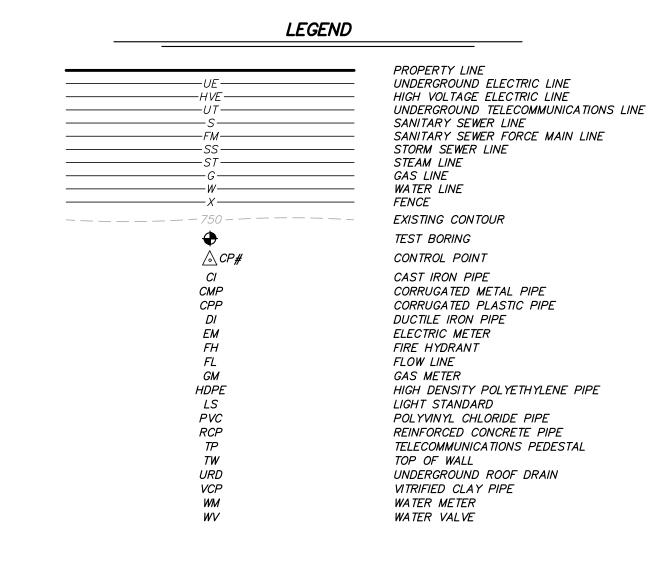

BENCH MARK

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ATHLETIC TRAINING COMPLEX.

ELEVATION = 721.18

FREDERICK E. CARROZ III PROFESSIONAL LAND SURVEYOR PLS - 2008016655

Date

SEPTEMBER 16, 2022

Revised

IF ORIGINAL SIGNATURE OR DIGITAL

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MEDIA SHOULD NOT BE CONSIDERED.

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KATE

NUMBER
PLS-2008016655

* FREDERICK EMIL *

CARROZ III

9/16/2022

1113 Fay Street, Columbia, MO 65201

MO Land Surveying Corp. # 200400467

Surveyed: RE Drawn: CGH

BOUNDARY & TOPOGRAPHIC SURVEY


V1.01

ES&S PROJECT NO. 15358

1 of 5

SURVEY CONTROL POINTS

-				-
POINT #	<u>NORTH</u>	<u>EAST</u>	<u>ELEVATION</u>	<u>DESCRIPTION</u>
CP1	1129870.80	1686622.12	720.29	MAG NAIL
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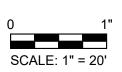


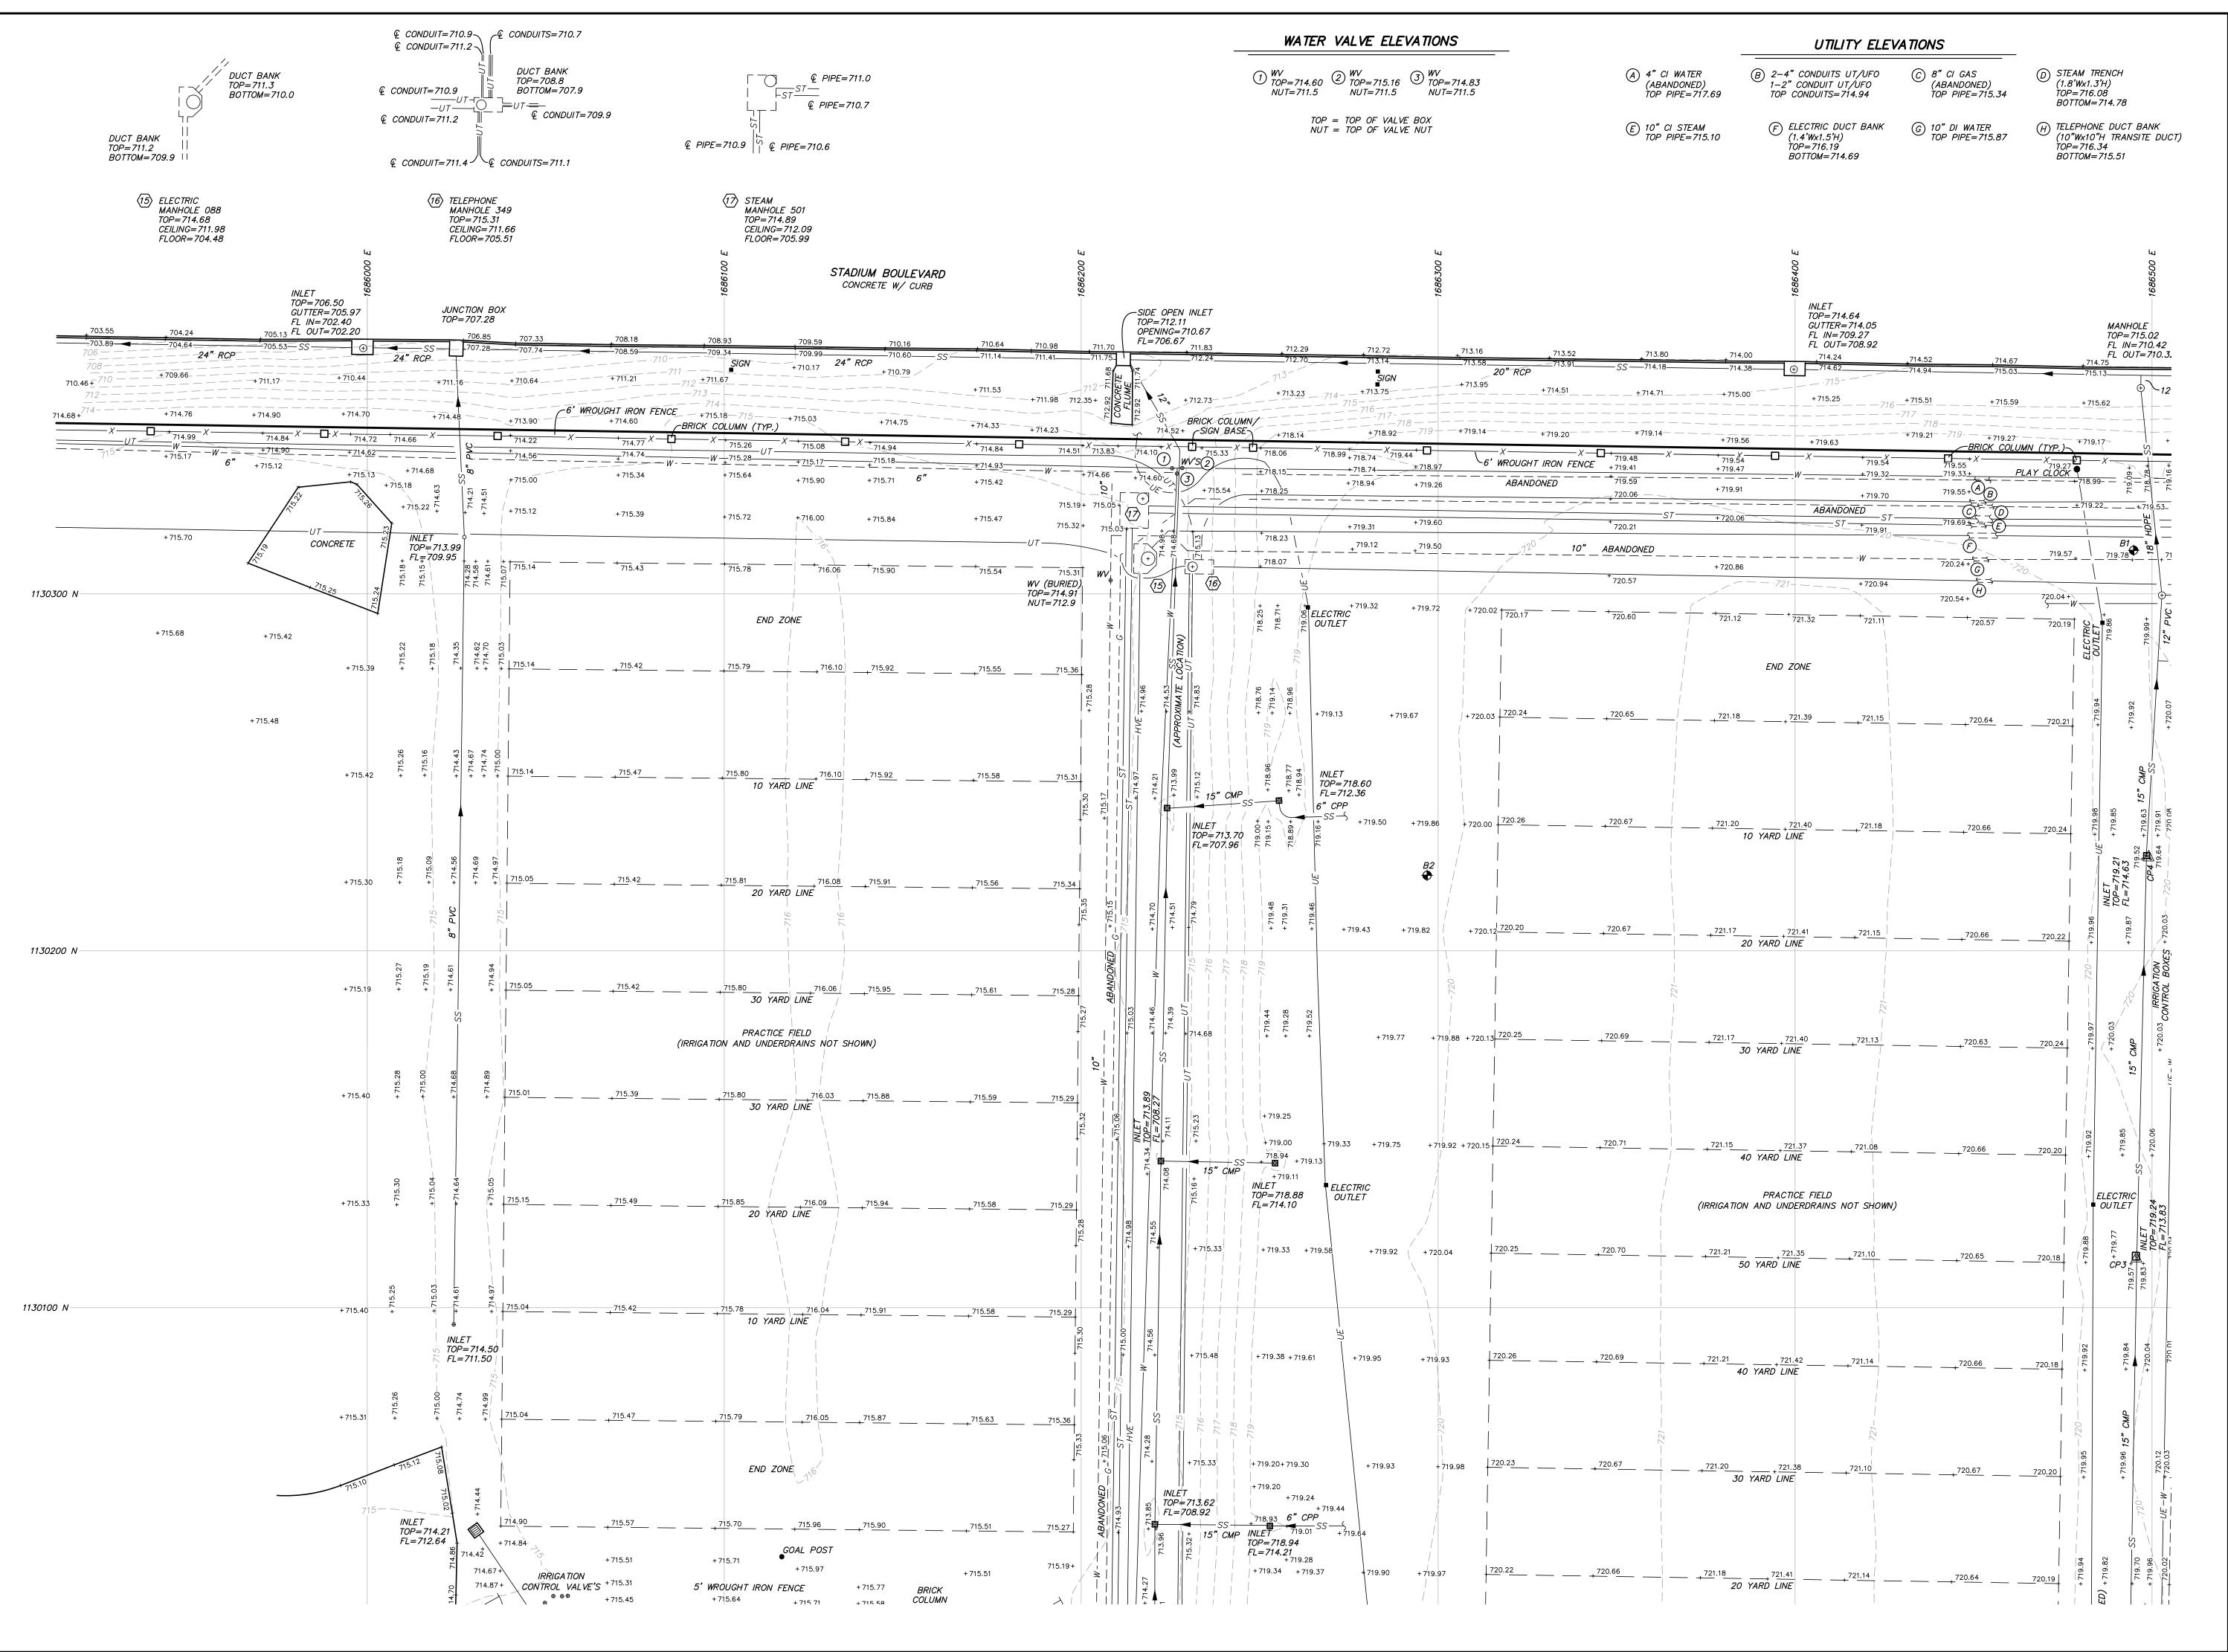

1113 Fay Street, Columbia, MO 65201 573 - 449 - 2646 02 El Dorado Drive, Jefferson City, MO 65 573-636-3303

1775 West Main Street, Sedalia, MO 6530 660-826-8618 www.ess-inc.com MO Land Surveying Corp. # 2004004672





SCALE: 1" = 20'

OTBALL PRACTICE FIELDS LIGHT
COLUMBIA, BOONE COUNTY, MISSOURI

9/16/2022

OF MISS
FREDERICK EMIL
CARROZ III
NUMBER
PLS-2008016655

FREDERICK E. CARROZ III PROFESSIONAL LAND SURVEYOR PLS - 2008016655

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SEPTEMBER 16, 2022

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Surveyed: RE Drawn: CGF

BOUNDARY & TOPOGRAPHIC SURVEY

V1.02

2 of 5


ES&S PROJECT NO. 1535



1113 Fay Street, Columbia, MO 65201

1775 West Main Street, Sedalia, MO 6530 www.ess-inc.com MO Land Surveying Corp. # 200400467



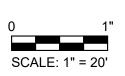

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9/16/2022 FREDERICK EMIL
CARROZ III
NUMBER
PLS-2008016655

FREDERICK E. CARROZ III PROFESSIONAL LAND SURVEYOR PLS - 2008016655

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SEPTEMBER 16, 2022

Revised


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BOUNDARY & TOPOGRAPHIC SURVEY

V1.03

3 of 5


ES&S PROJECT NO. 15358

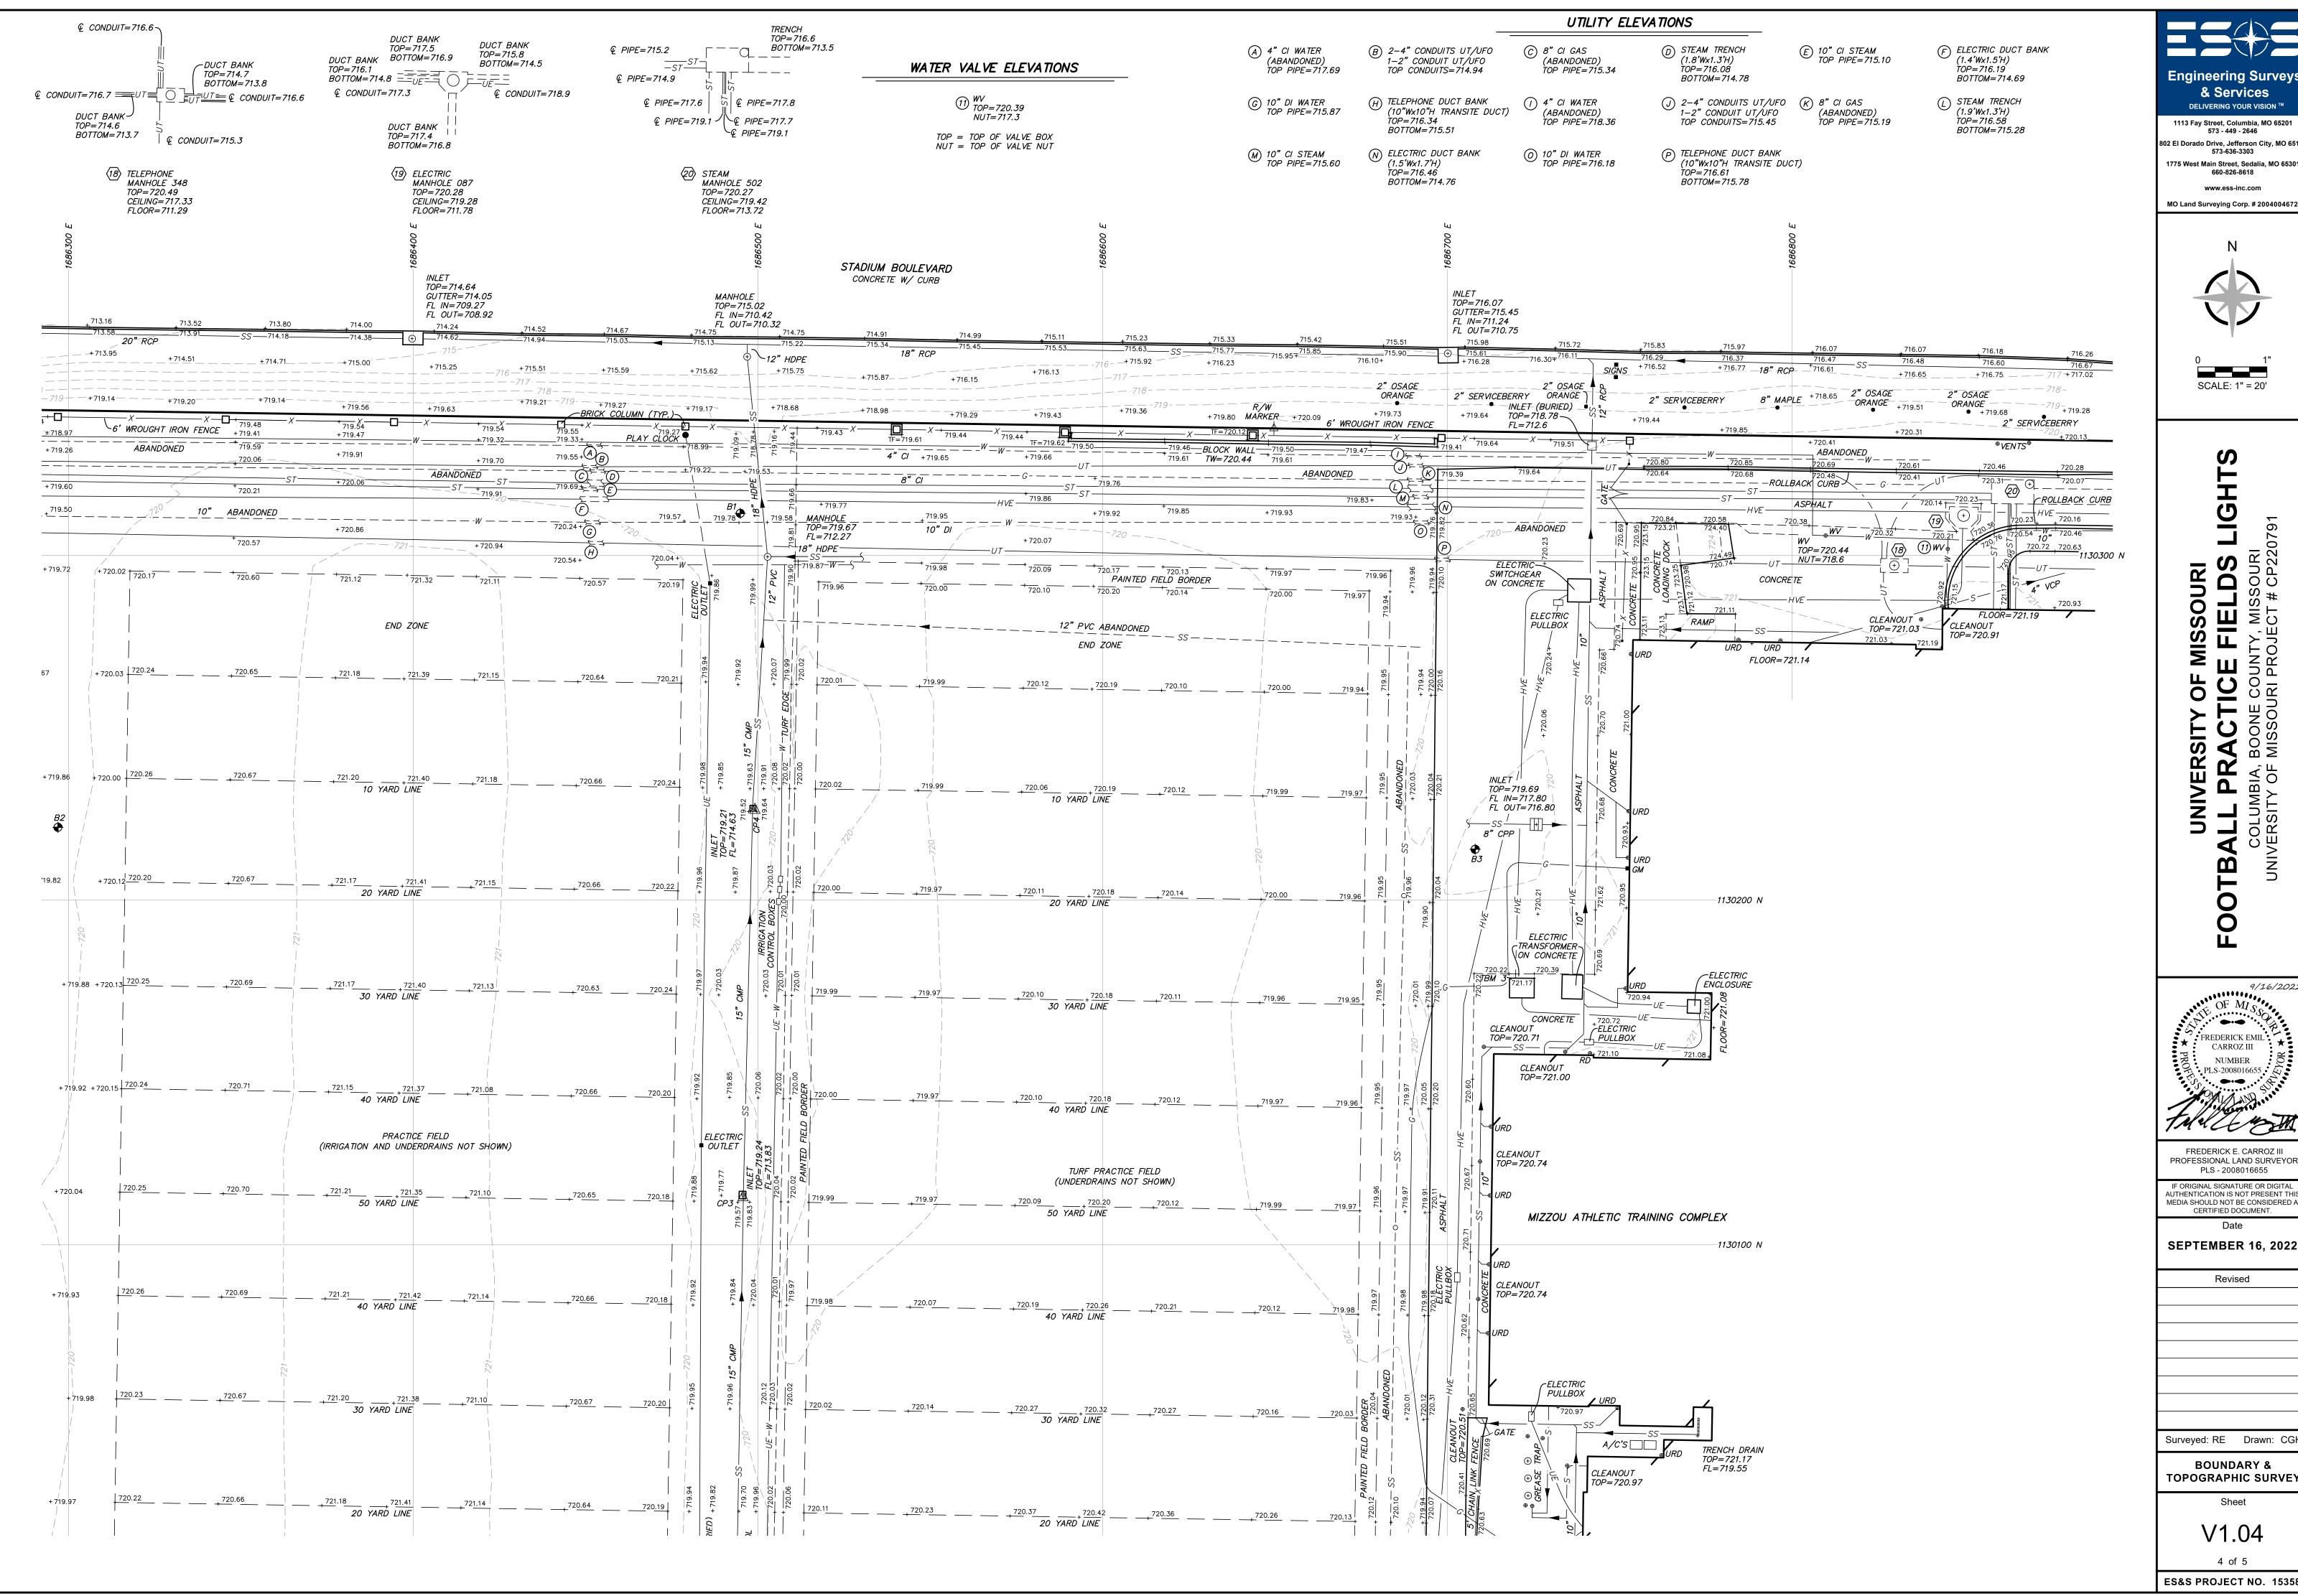

Engineering Surveys

1113 Fay Street, Columbia, MO 65201 02 El Dorado Drive, Jefferson City, MO 65

1775 West Main Street, Sedalia, MO 6530

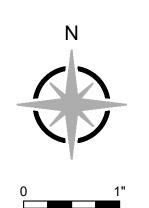


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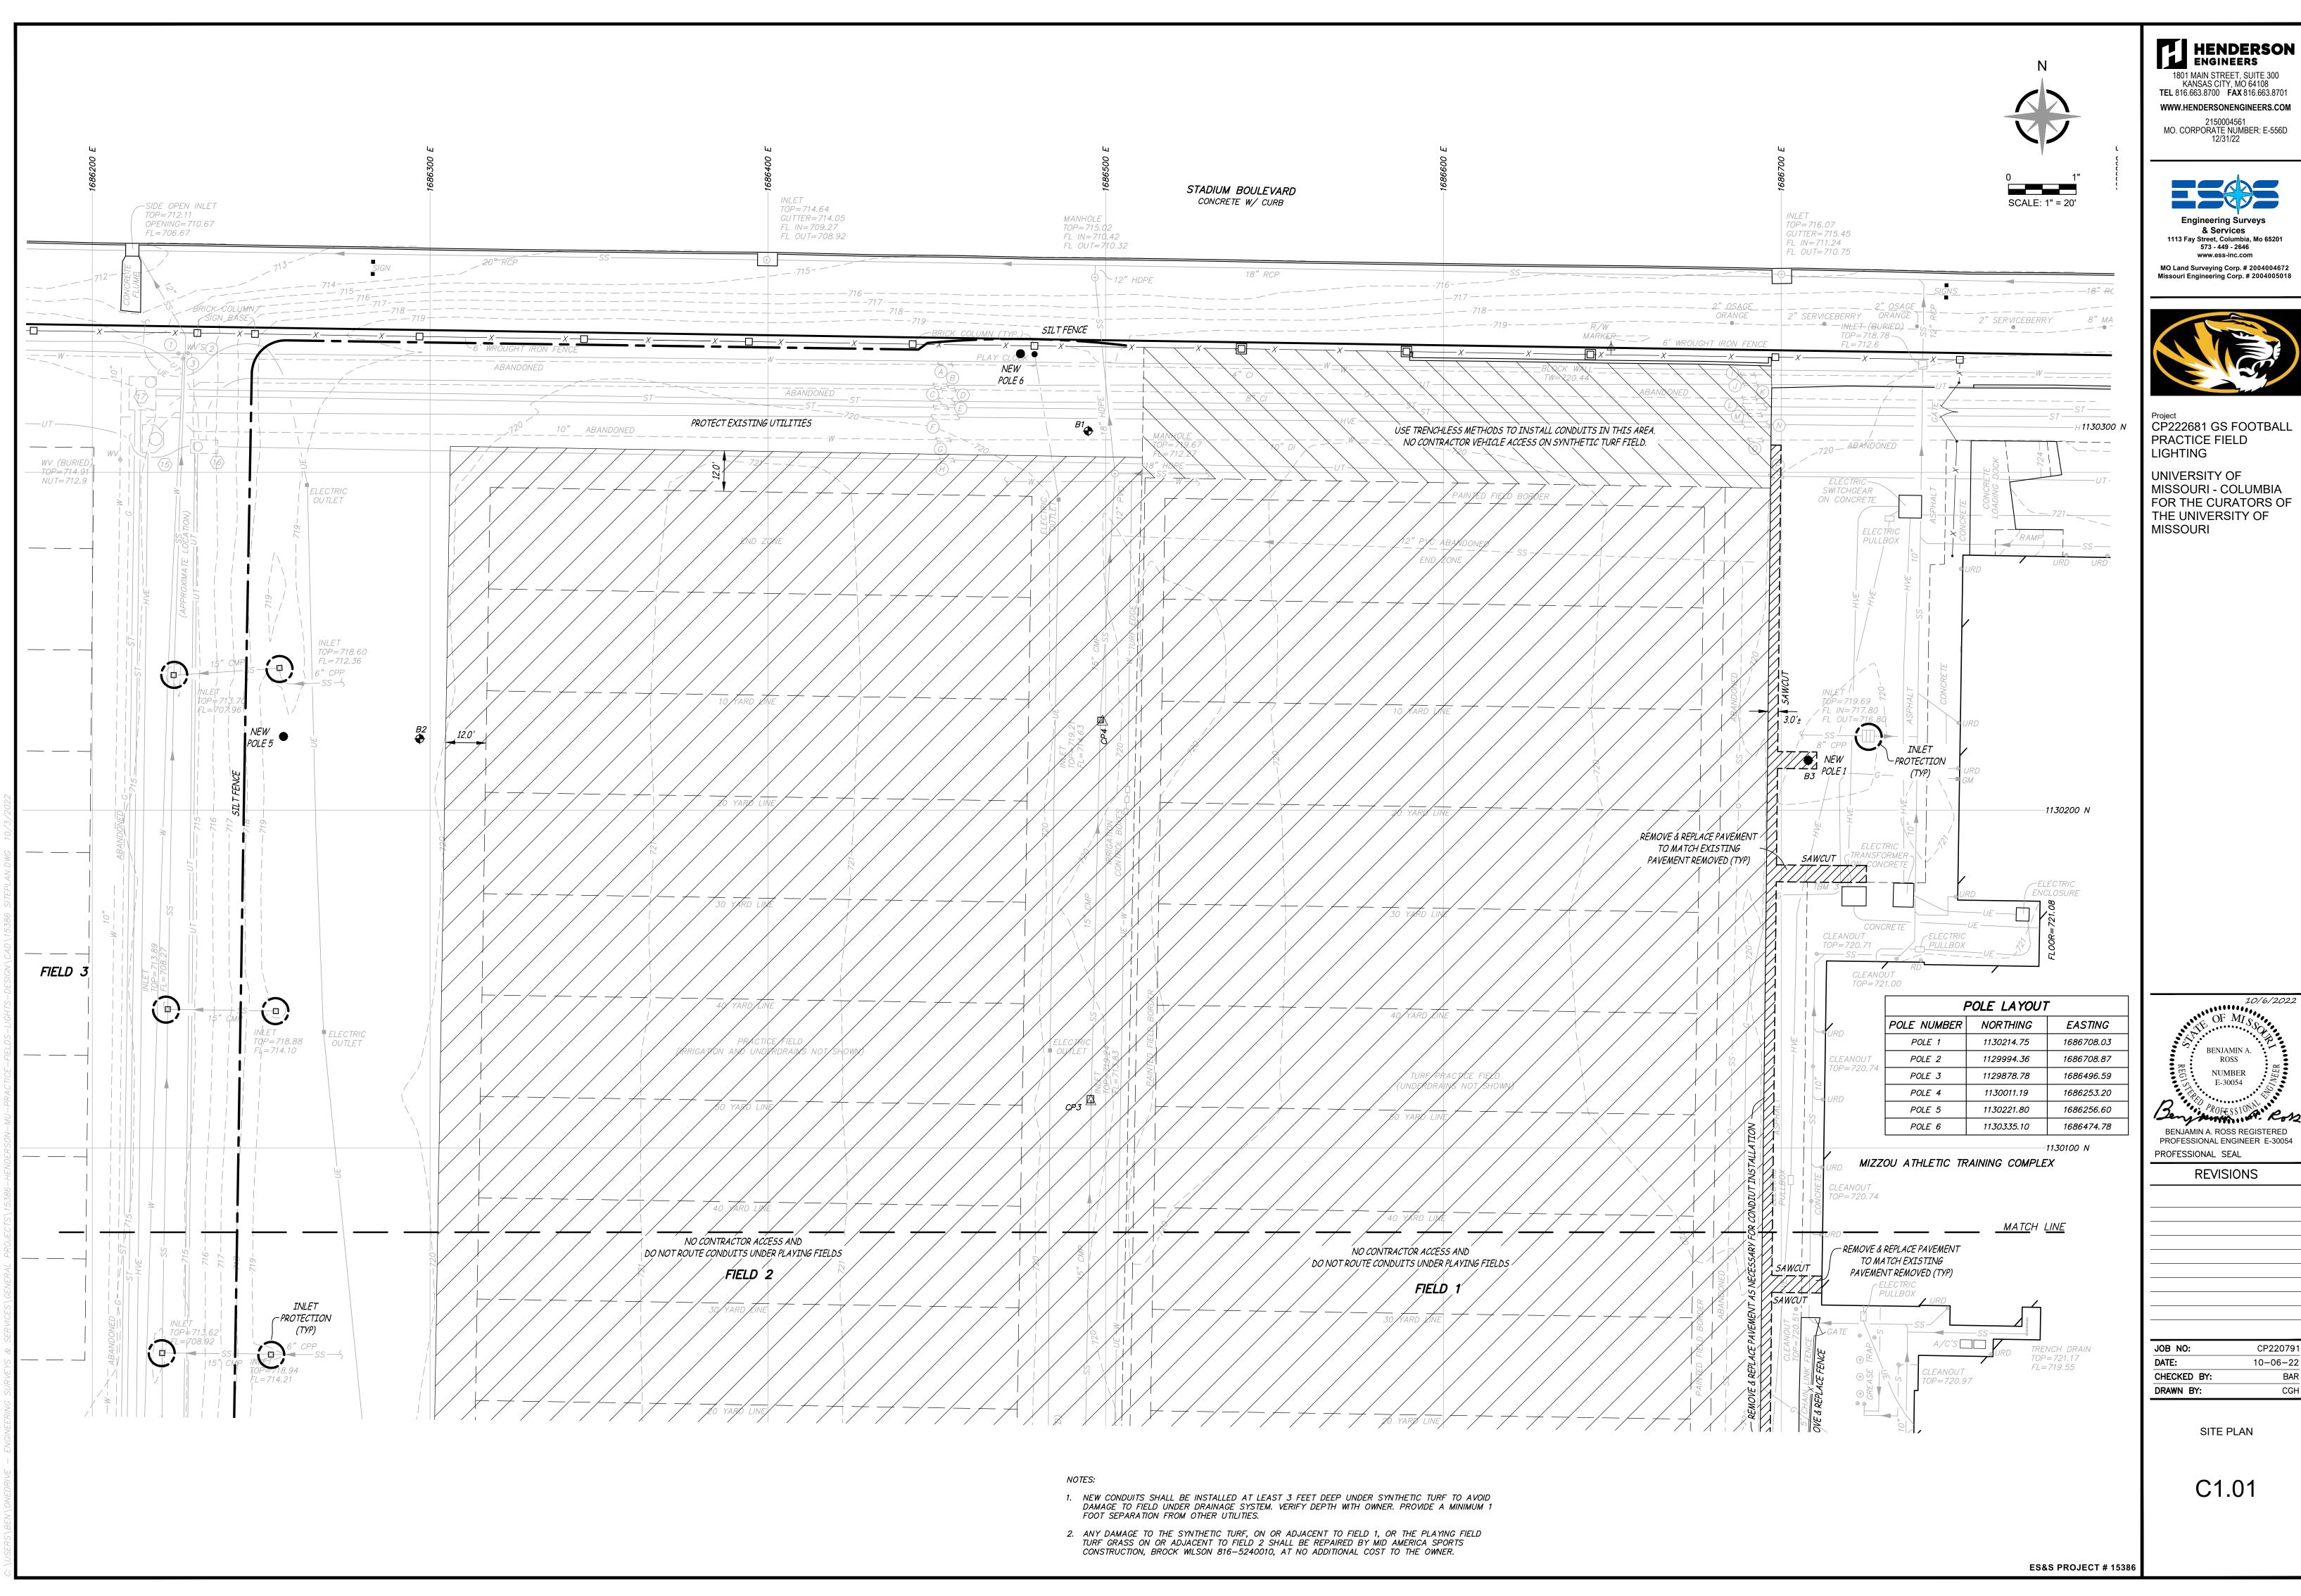
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SEPTEMBER 16, 2022

Surveyed: RE Drawn: CGI

TOPOGRAPHIC SURVEY






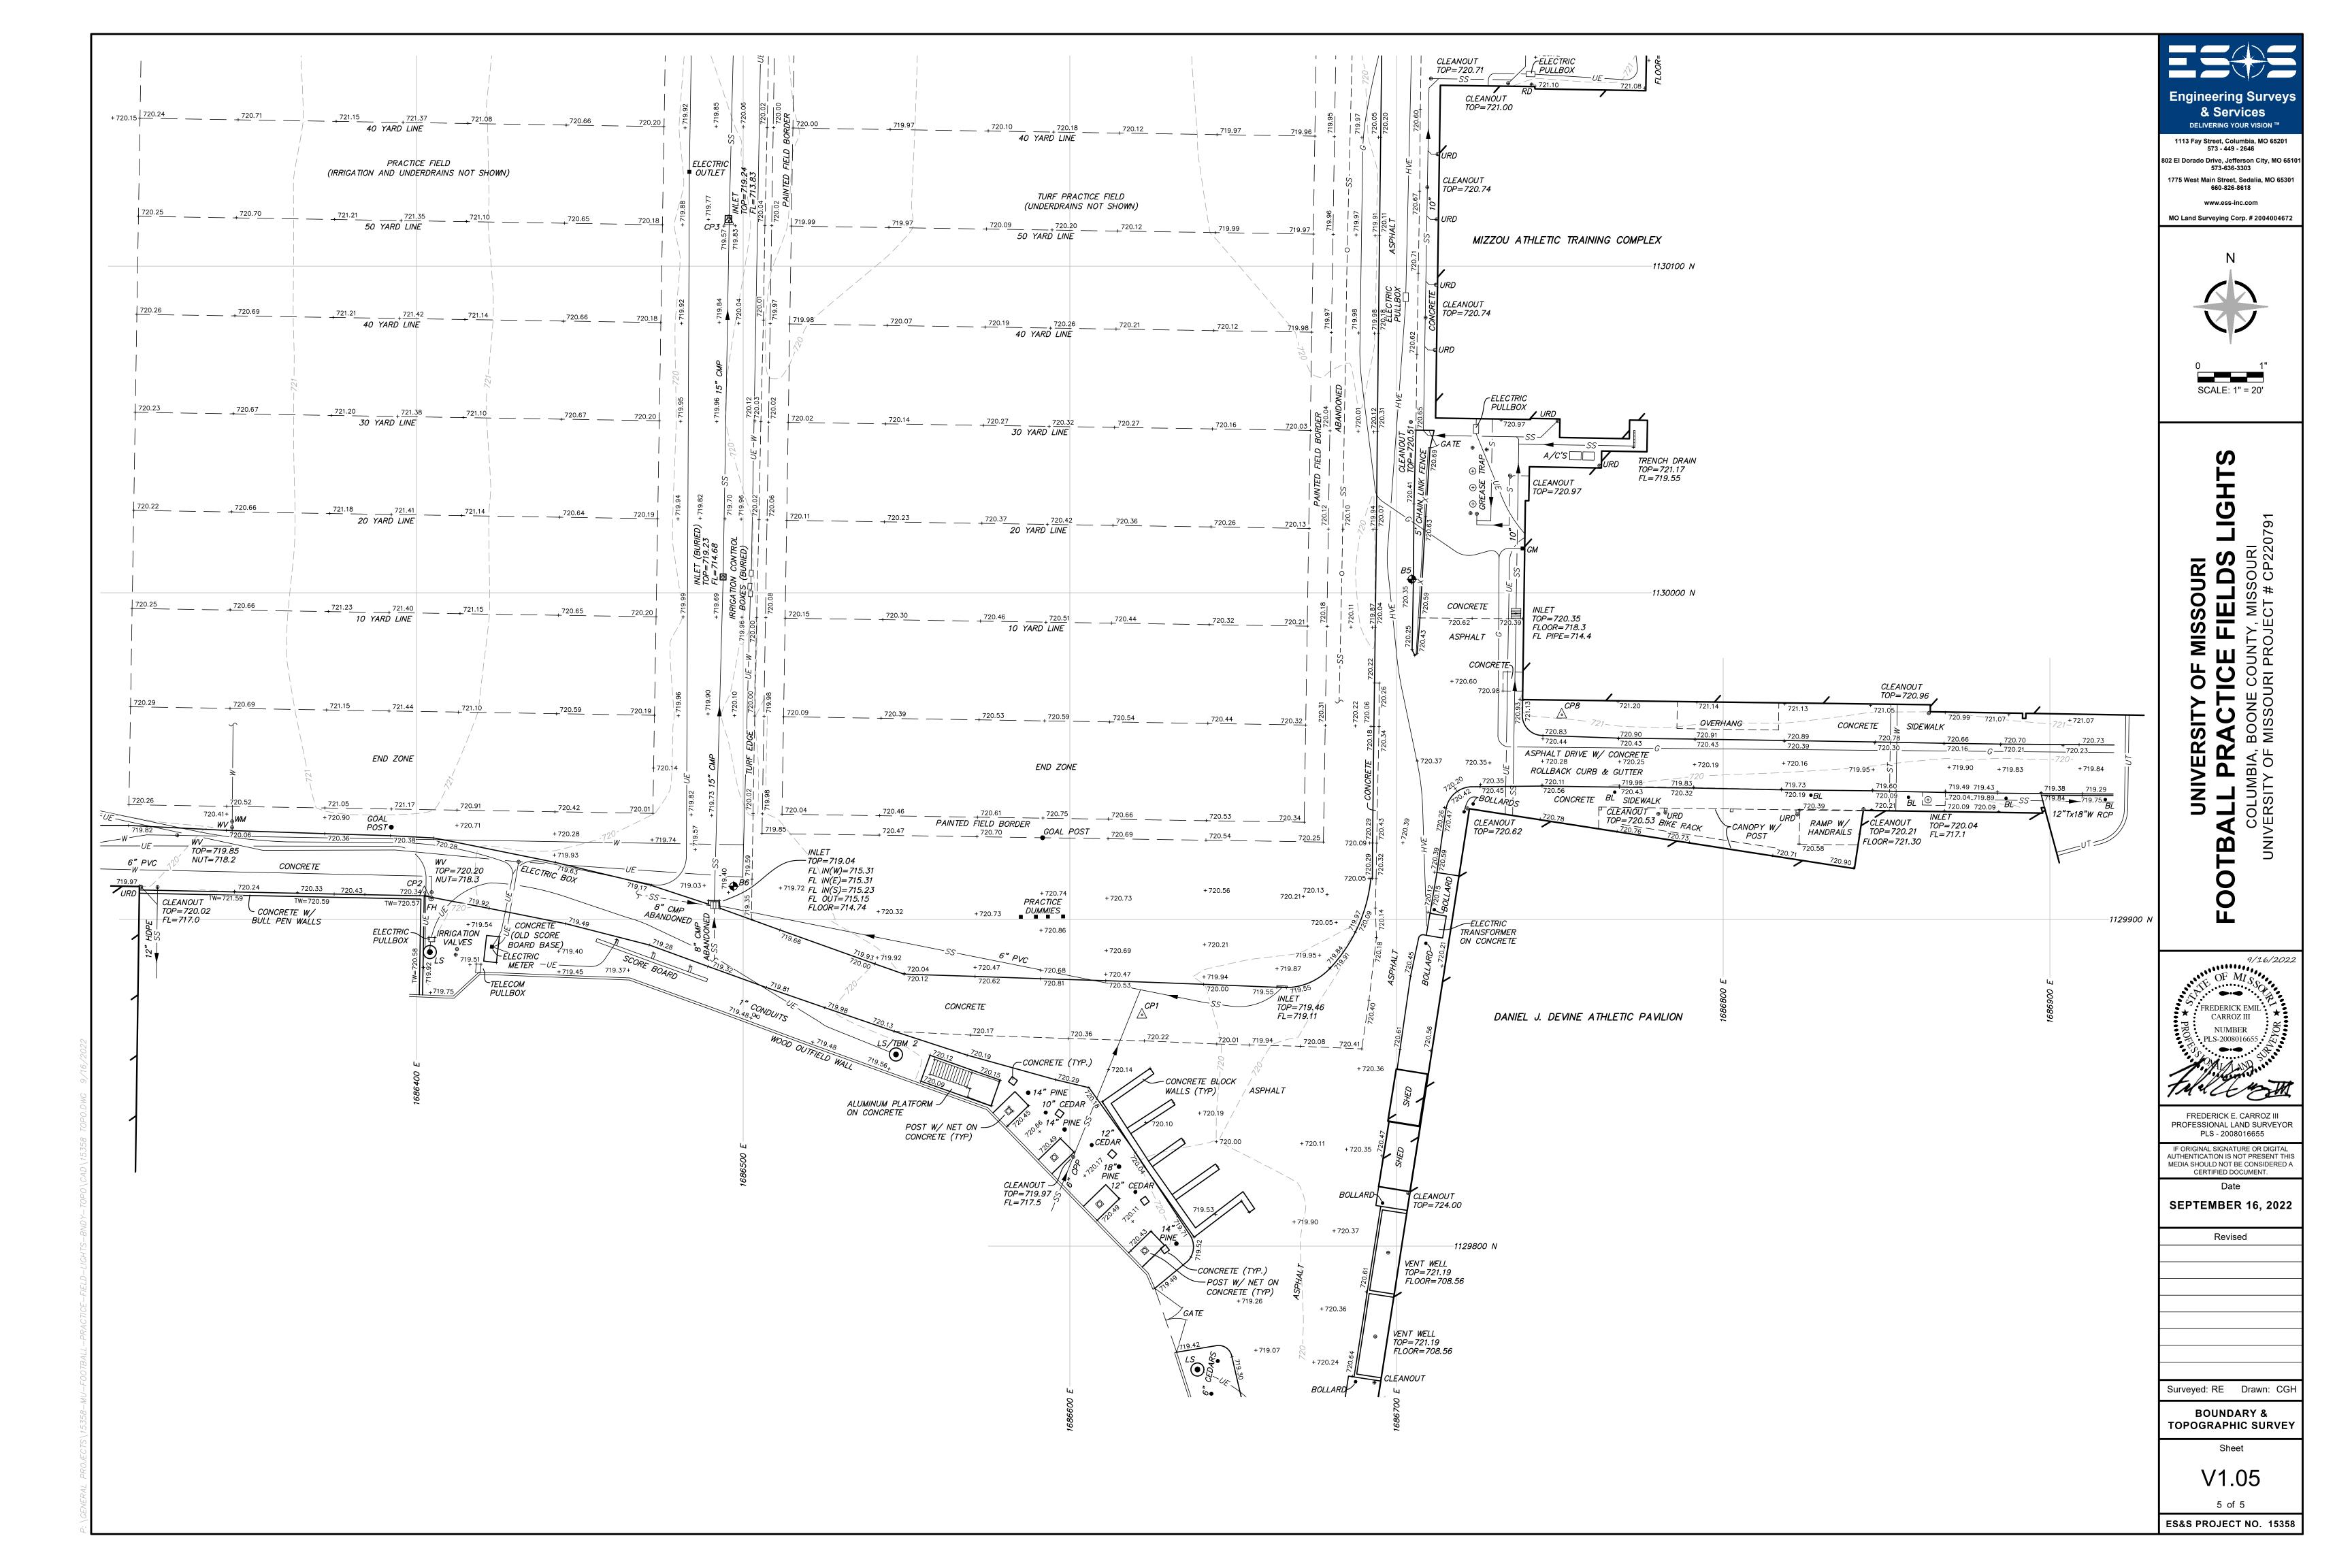


10/6/2022

CP220791 10-06-22

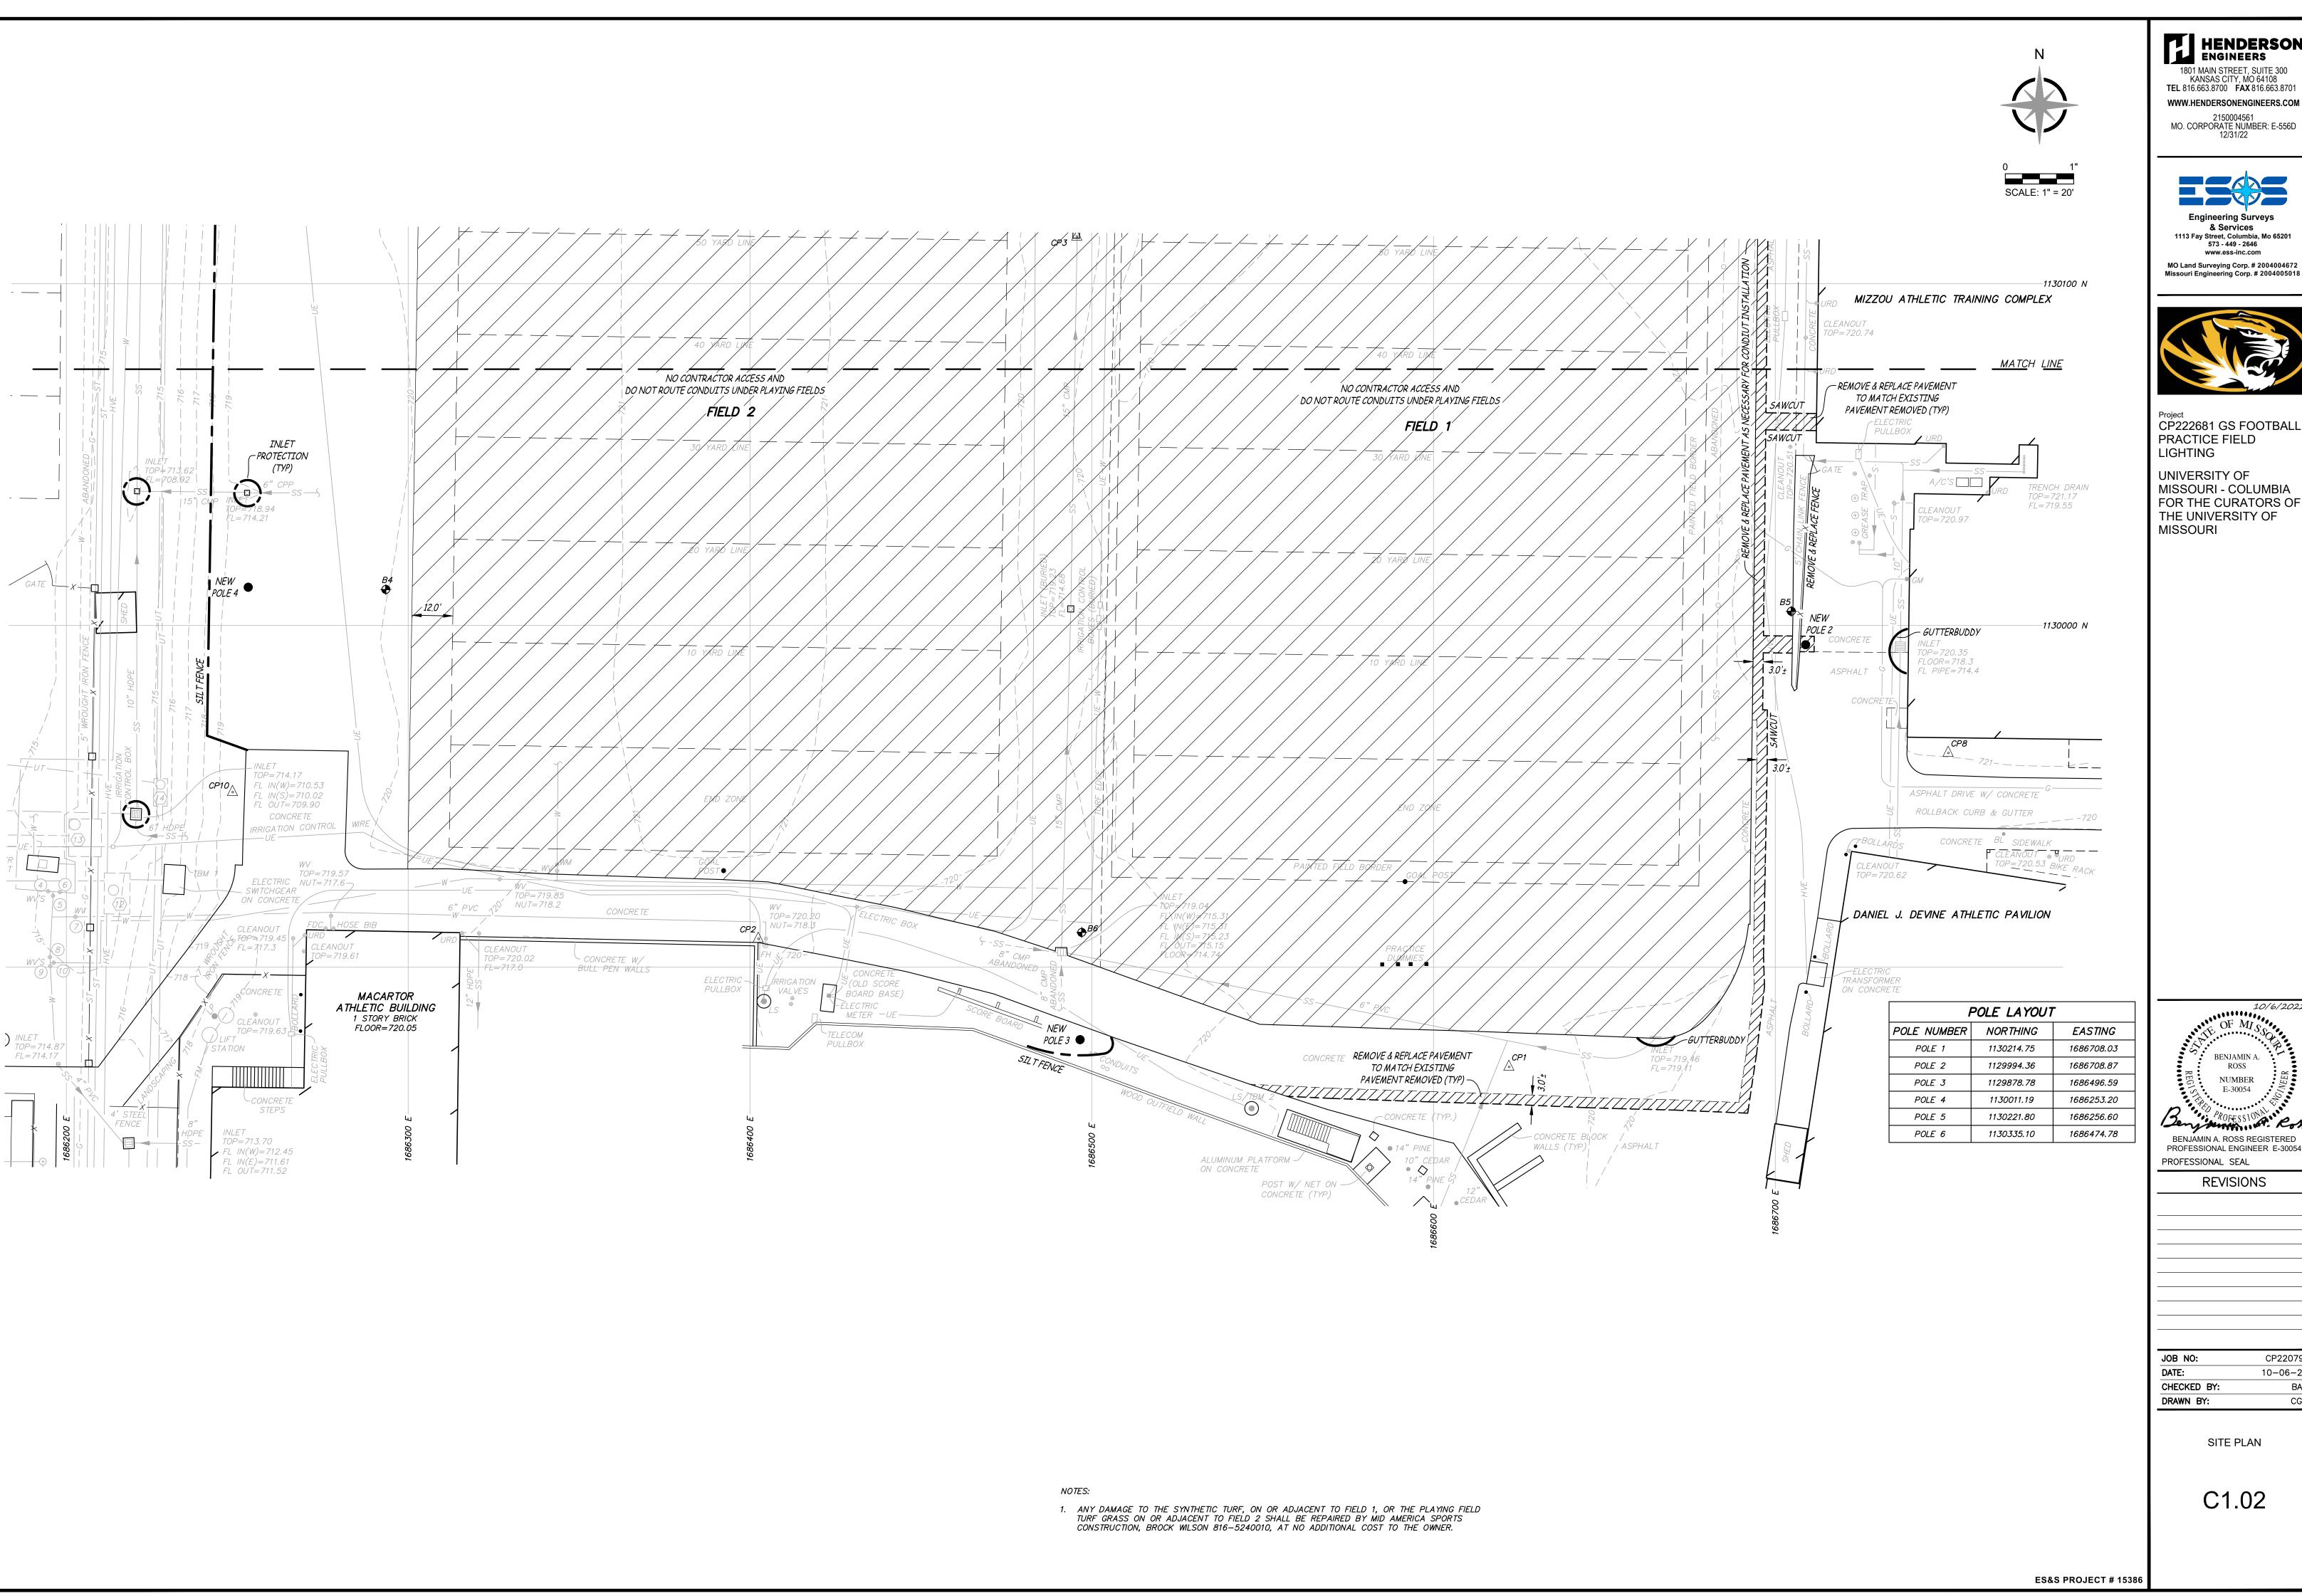

HENDERSON ENGINEERS

1801 MAIN STREET, SUITE 300 KANSAS CITY, MO 64108 TEL 816.663.8700 FAX 816.663.8701 WWW.HENDERSONENGINEERS.COM 2150004561 MO. CORPORATE NUMBER: E-556D 12/31/22

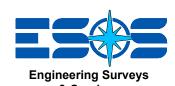


& Services 1113 Fay Street, Columbia, Mo 65201 573 - 449 - 2646



CP222681 GS FOOTBALL PRACTICE FIELD LIGHTING

UNIVERSITY OF MISSOURI - COLUMBIA FOR THE CURATORS OF THE UNIVERSITY OF MISSOURI

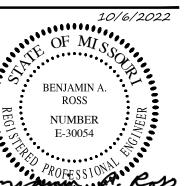

BENJAMIN A. ROSS REGISTERED PROFESSIONAL ENGINEER E-30054 PROFESSIONAL SEAL

REVISIONS


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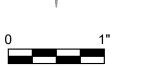
BAR CGH


SITE PLAN

C1.02





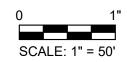

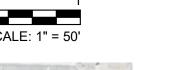



HENDERSON ENGINEERS

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REVISIONS


JOB NO: CP220791 10-06-22 CHECKED BY:

CONSTRUCTION ACCESS

DRAWN BY:

ES&S PROJECT # 15386


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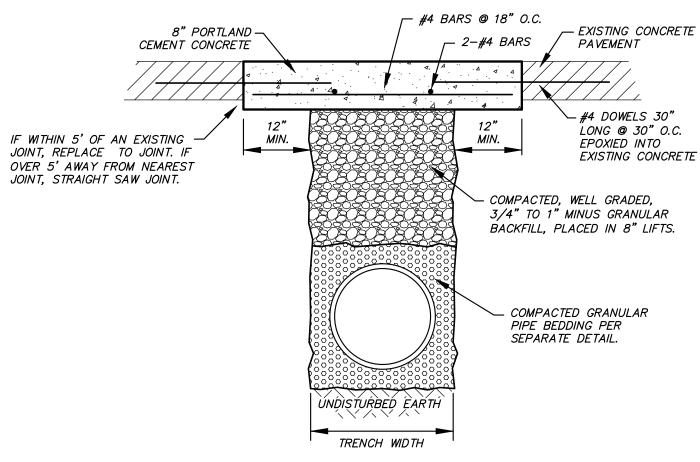
NOTES:

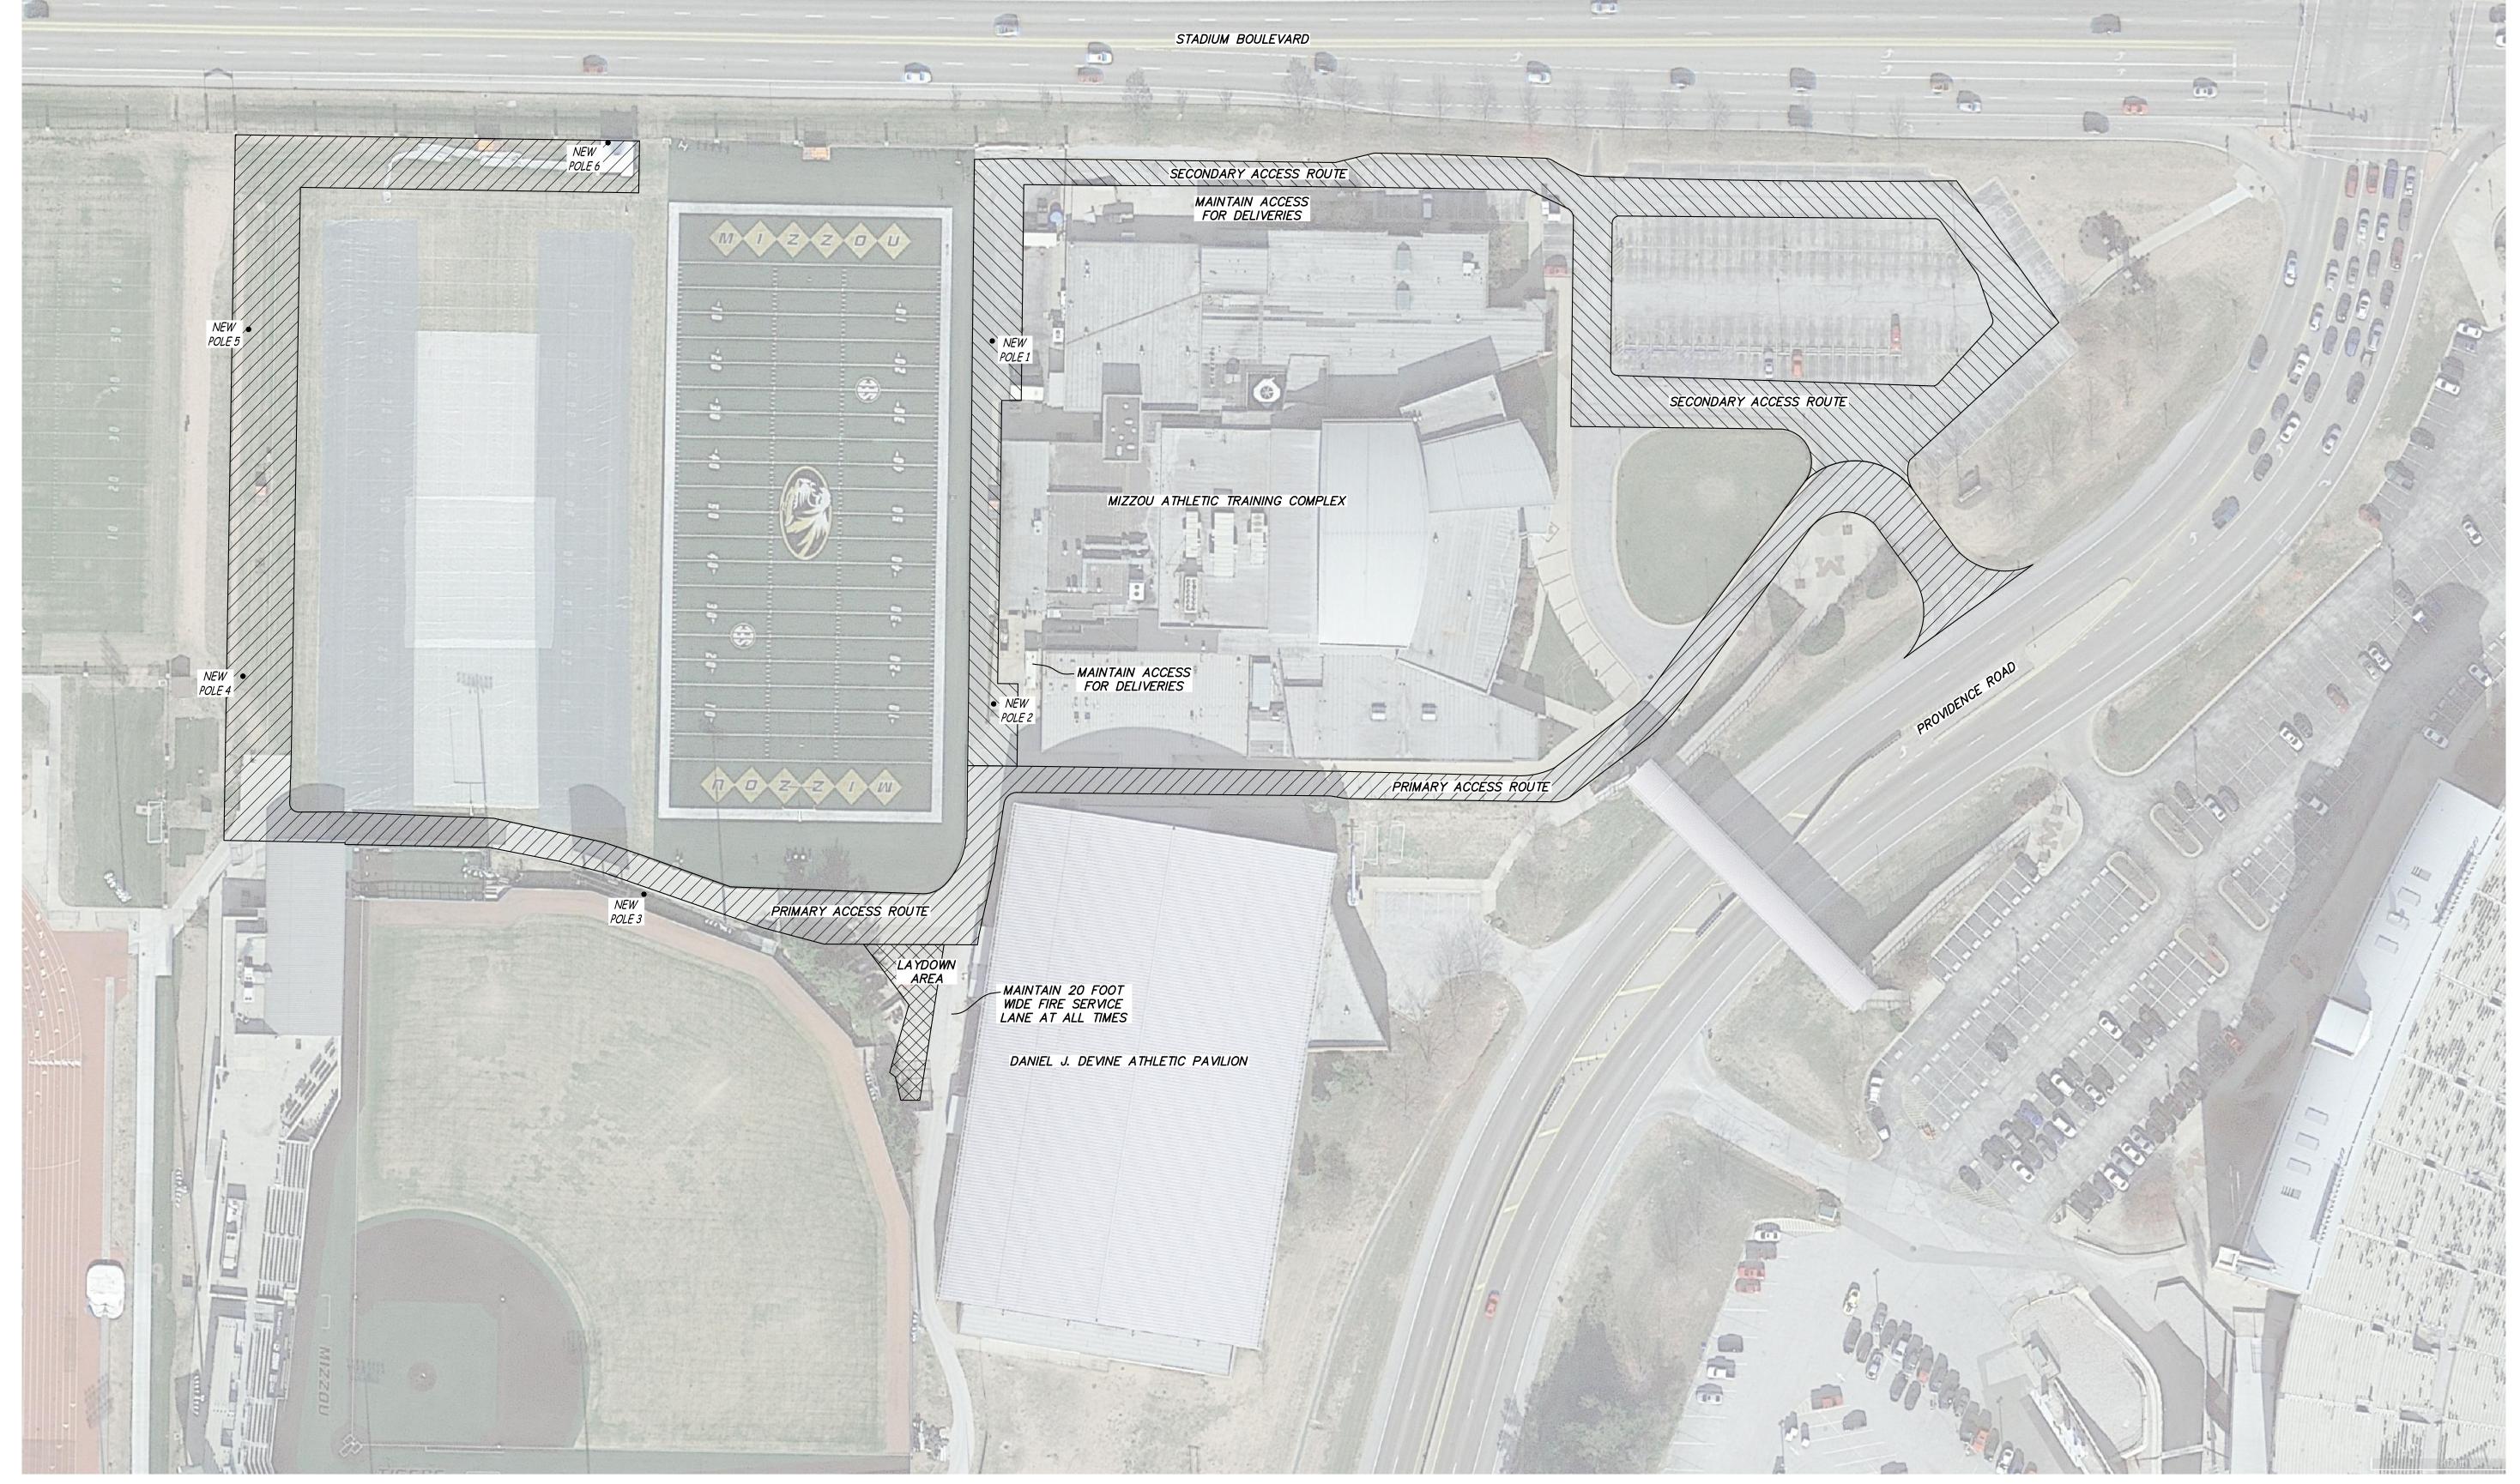CONTRACTOR SHALL COORDINATE WITH OWNER PRIOR TO USING SECONDARY ACCESS ROUTE.

2. SECONDARY ACCESS ROUTE SHALL REMAIN CLEAR FOR OWNER DELIVERIES AT ALL TIMES.



EXISTING ASPHALT PAVEMENT

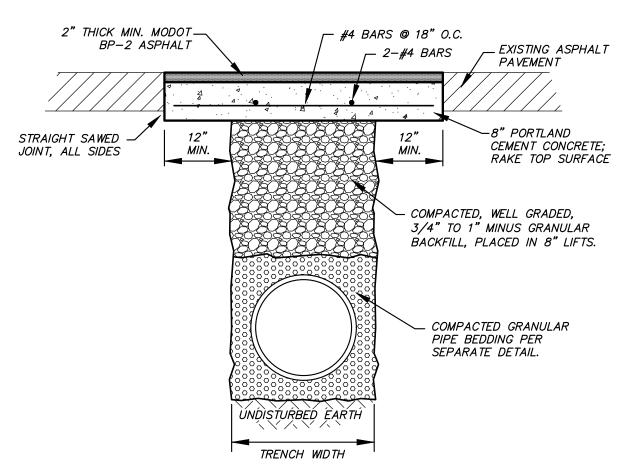

EXISTING CONCRETE PAVEMENT

1. CONCRETE SHALL BE 4,000 PSI WITH 6% AIR.

4. CLEAN GRANULAR MATERIAL IS NOT SUITABLE TRENCH BACKFILL

2. REINFORCEMENT SHALL BE GRADE 60. 3. A MINIMUM OF 5' OF CONCRETE CURB AND GUTTER SHALL BE REPLACED. WHERE THE REPAIR WILL BE WITHIN 5' OF A JOINT, REPLACE CONCRETE CURB AND GUTTER TO THE JOINT. NO SECTION OF CONCRETE CURB AND GUTTER SHALL BE LESS THAN 5' LONG.

TRENCH PATCHING WITHIN PAVED AREAS


NOT TO SCALE

Gutterbuddy™ Specification (OR APPROVED EQUAL) For Curb Gutter Storm Drains

1.0 Description

1.1 This work shall consist of furnishing, placing, maintaining and removing the GutterbuddyTM sediment control device as directed by the engineer and as shown on the contract drawings. The GutterbuddyTM sediment control system distributed by:

ACF Environmental, Inc. 2831 Cardwell Road Richmond, Virginia 23234 Phone: 800-448-3636 • Fax: 804-743-7779 www.acfenvironmental.com

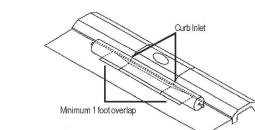

2.0 Materials

2.1 GUTTERBUDDY™

The Gutterbuddy™ shall be synthetic filter manufactured from recycled synthetic fibers.

2.1.1 The GutterbuddyTM will be manufactured to be 9" in diameter and are available in 4', 6', 8', 10', 12', 14' and 16' lengths and a minimum of twenty-four (24) inches longer than the curb inlet opening. This will allow for sufficient length to cover the inlet with twelve (12) inches beyond the inlet on both ends.

3.0 Construction Sequence

3.1 General

3.1.1 Install the GutterbuddyTM in front of the curb inlet opening. Each end of the GutterbuddyTM should overlap the curb inlet approximately 12".

3.1.2 The Gutterbuddy™ should be cleaned if a visual inspection shows silt and debris build up around the GutterbuddyTM.


3.1.3 To remove the GutterbuddyTM, lift out of the

- **3.1.4** The Gutterbuddy™ is reusable. Once the construc tion project is complete and it is no longer needed for sediment control, remove, clean and store out of the sunlight until needed on the next project.
- **3.1.5** Ponding is likely if sediment is not removed regularly. Inspection of GutterbuddyTM should be on a regular basis and immediately after major rain events.

4.0 Basis of Payment

4.1 The payment for any GutterbuddyTM used during the construction is to be included in the bid of the overall erosion and sediment control plan and priced by the linear foot.



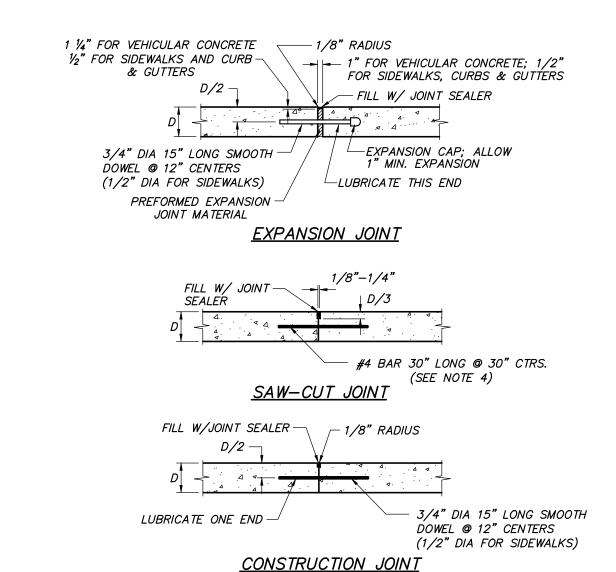


1. PRIOR TO CONSTRUCTION, CONTRACTOR SHALL SUBMIT A PAVEMENT JOINT PLAN OF ALL CONCRETE PAVEMENT FOR APPROVAL.

- 2. CONCRETE PAVEMENT SHALL HAVE SAW-CUT OR CONSTRUCTION JOINTS EVERY 10 FEET FOR 4 INCH THICK PAVEMENT, 12 FEET FOR 5 INCH THICK PAVEMENT, AND 15 FEET FOR 6 INCH THICK PAVEMENT OR GREATER. PANELS SHALL BE CUT SUCH THAT PANELS ARE NEARLY SQUARE AND DO NOT EXCEED 1.4 LENGTH TO WIDTH RATIO. EXPANSION JOINTS SHALL BE PROVIDED AT ALL FIXED STRUCTURES, SUCH AS: LIGHT STANDARD FOUNDATIONS, SEWER STRUCTURES, BUILDINGS, WALLS, BOTTOM OF STAIRS, ROOF DRAINS, ETC., AND EVERY 150 FEET MAXIMUM. DOWEL BARS SHALL BE PROVIDED AT TRANSVERSE JOINTS IN ALL HEAVY DUTY PAVEMENT DRIVE AISLES. 3. THIS DETAIL APPLIES TO ALL CONCRETE PAVEMENT FOR PARKING LOTS, DRIVE/ACCESS AISLES,
- CURBS & GUTTERS. AND SIDEWALKS. 4. INCLUDE BAR WITH TRANSVERSE SAW-CUT JOINTS FOR HEAVY DUTY PAVEMENT. OMIT BAR WITH
- SAW-CUT JOINTS FOR STANDARD DUTY PAVEMENT AND SIDEWALKS. 5. PROVIDE CONSTRUCTION JOINT AT END OF DAYS WORK OR IF CONCRETE PLACEMENT IS SUSPENDED FOR MORE THAN 30 MINUTES.
- 6. SAW-CUT JOINTS SHALL BE CUT WITHIN 12 HOURS OF INITIAL SET OF CONCRETE. RAVELED
- JOINTS WILL NOT BE ACCEPTED. 7. ELASTOMERIC POLYURETHANE JOINT SEALANT IS REQUIRED FOR ALL JOINTS AND SHALL BE LIGHT
- 8. OMIT DOWEL BARS FOR EXPANSION JOINTS AT BUILDINGS, LIGHT STANDARDS, AND ROOF DRAINS.

CONCRETE PAVEMENT JOINTS

NOT TO SCALE

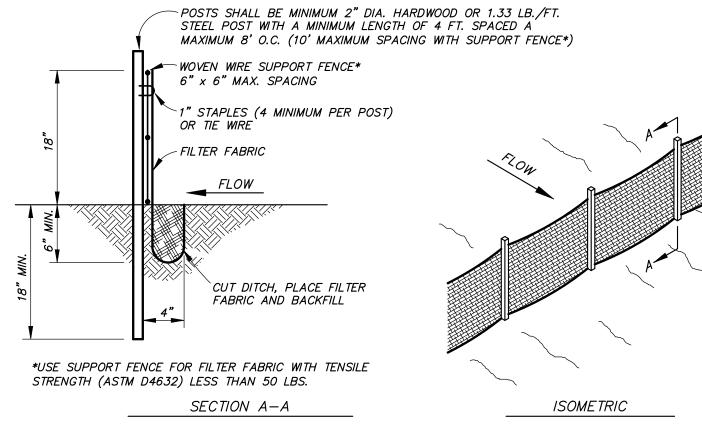

NOTES:

1. CONTRACTOR SHALL INSTALL SILT FENCE AT TOE OF SLOPES OF ALL AREAS AFFECTED BY CONSTRUCTION


PRIOR TO ANY DISTURBANCE ON THE SITE. 2. SILT FENCE SHALL REMAIN UNTIL VEGETATION HAS BEEN ESTABLISHED ON DISTURBED AREAS.

3. BUILT UP SEDIMENT SHALL BE REMOVED FROM SILT FENCE WHEN IT HAS REACHED ONE—THIRD THE HEIGHT OF

4. SILT FENCES SHALL BE INSPECTED FOR DEPTH OF SEDIMENT, TEARS, ETC., TO VERIFY THE FABRIC IS SECURELY ATTACHED TO THE POSTS, THE POSTS ARE SECURELY IN THE GROUND, AND THE FABRIC IS

SECURELY IMBEDDED IN THE GROUND TO PREVENT RUNOFF FROM GOING UNDER ANY PART OF THE FENCE. 5. CONTRACTOR SHALL REMOVE ALL SILT FENCES WHEN ALL DISTURBED AREAS ARE COVERED WITH A MINIMUM 80% VEGETATION. SEED AND MULCH ALL AREAS DISTURBED DURING REMOVAL.

SILT FENCE DETAIL NOT TO SCALE

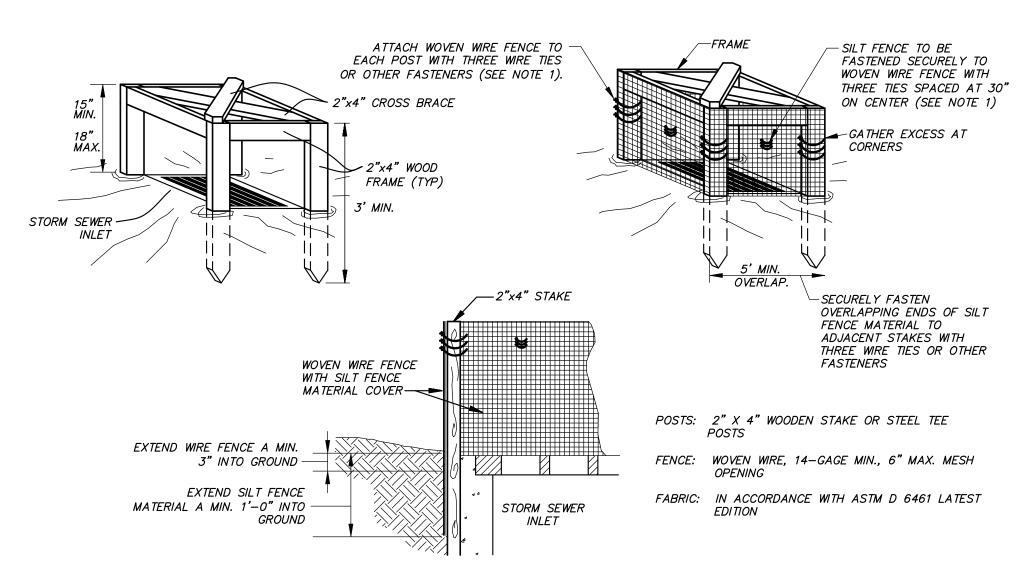


- 1. ATTACH THE WOVEN WIRE FENCE TO EACH POST AND THE GEOTEXTILE TO THE WOVEN WIRE FENCE (SPACED EVERY 30") WITH THREE WIRE TIES OR OTHER FASTENERS, ALL SPACED WITHIN THE TOP 8" OF THE FABRIC. ATTACH EACH TIE DIAGONALLY 45 DEGREES THROUGH THE FABRIC, WITH EACH PUNCTURE AT LEAST 1" VERTICALLY APART.
- 2. WHEN TWO SECTIONS OF SILT FENCE MATERIAL ADJOIN EACH OTHER, THEY SHALL BE OVERLAPPED ACROSS TWO POSTS. 3. MAINTENANCE SHALL BE PERFORMED AS NOTED IN THE SWPPP. DEPTH OF ACCUMULATED SEDIMENTS MAY NOT EXCEED ONE—THIRD THE HEIGHT OF THE FABRIC. MAINTENANCE CLEANING MUST BE CONDUCTED REGULARLY TO PREVENT ACCUMULATED SEDIMENTS FROM REACHING ONE—THIRD THE HEIGHT OF THE SILT FENCE MATERIAL.
- 4. ALL SILT FENCE SHALL INCLUDE WIRE SUPPORT.



HENDERSON **ENGINEERS** 1801 MAIN STREET, SUITE 300 KANSAS CITY, MO 64108

TEL 816.663.8700 FAX 816.663.8701 WWW.HENDERSONENGINEERS.COM MO. CORPORATE NUMBER: E-556D

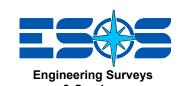

& Services 1113 Fay Street, Columbia, Mo 65201

MO Land Surveying Corp. # 2004004672 Missouri Engineering Corp. # 2004005018



CP222681 GS FOOTBALL PRACTICE FIELD LIGHTING

UNIVERSITY OF MISSOURI - COLUMBIA FOR THE CURATORS OF THE UNIVERSITY OF MISSOURI

10/6/2022 BENJAMIN A ROSS NUMBER E-30054 BENJAMIN A. ROSS REGISTERED


PROFESSIONAL ENGINEER E-30054 PROFESSIONAL SEAL

REVISIONS

JOB NO: CP220791 DATE: 10-06-22 CHECKED BY: BAR DRAWN BY: CGH

DETAILS

ES&S PROJECT # 15386

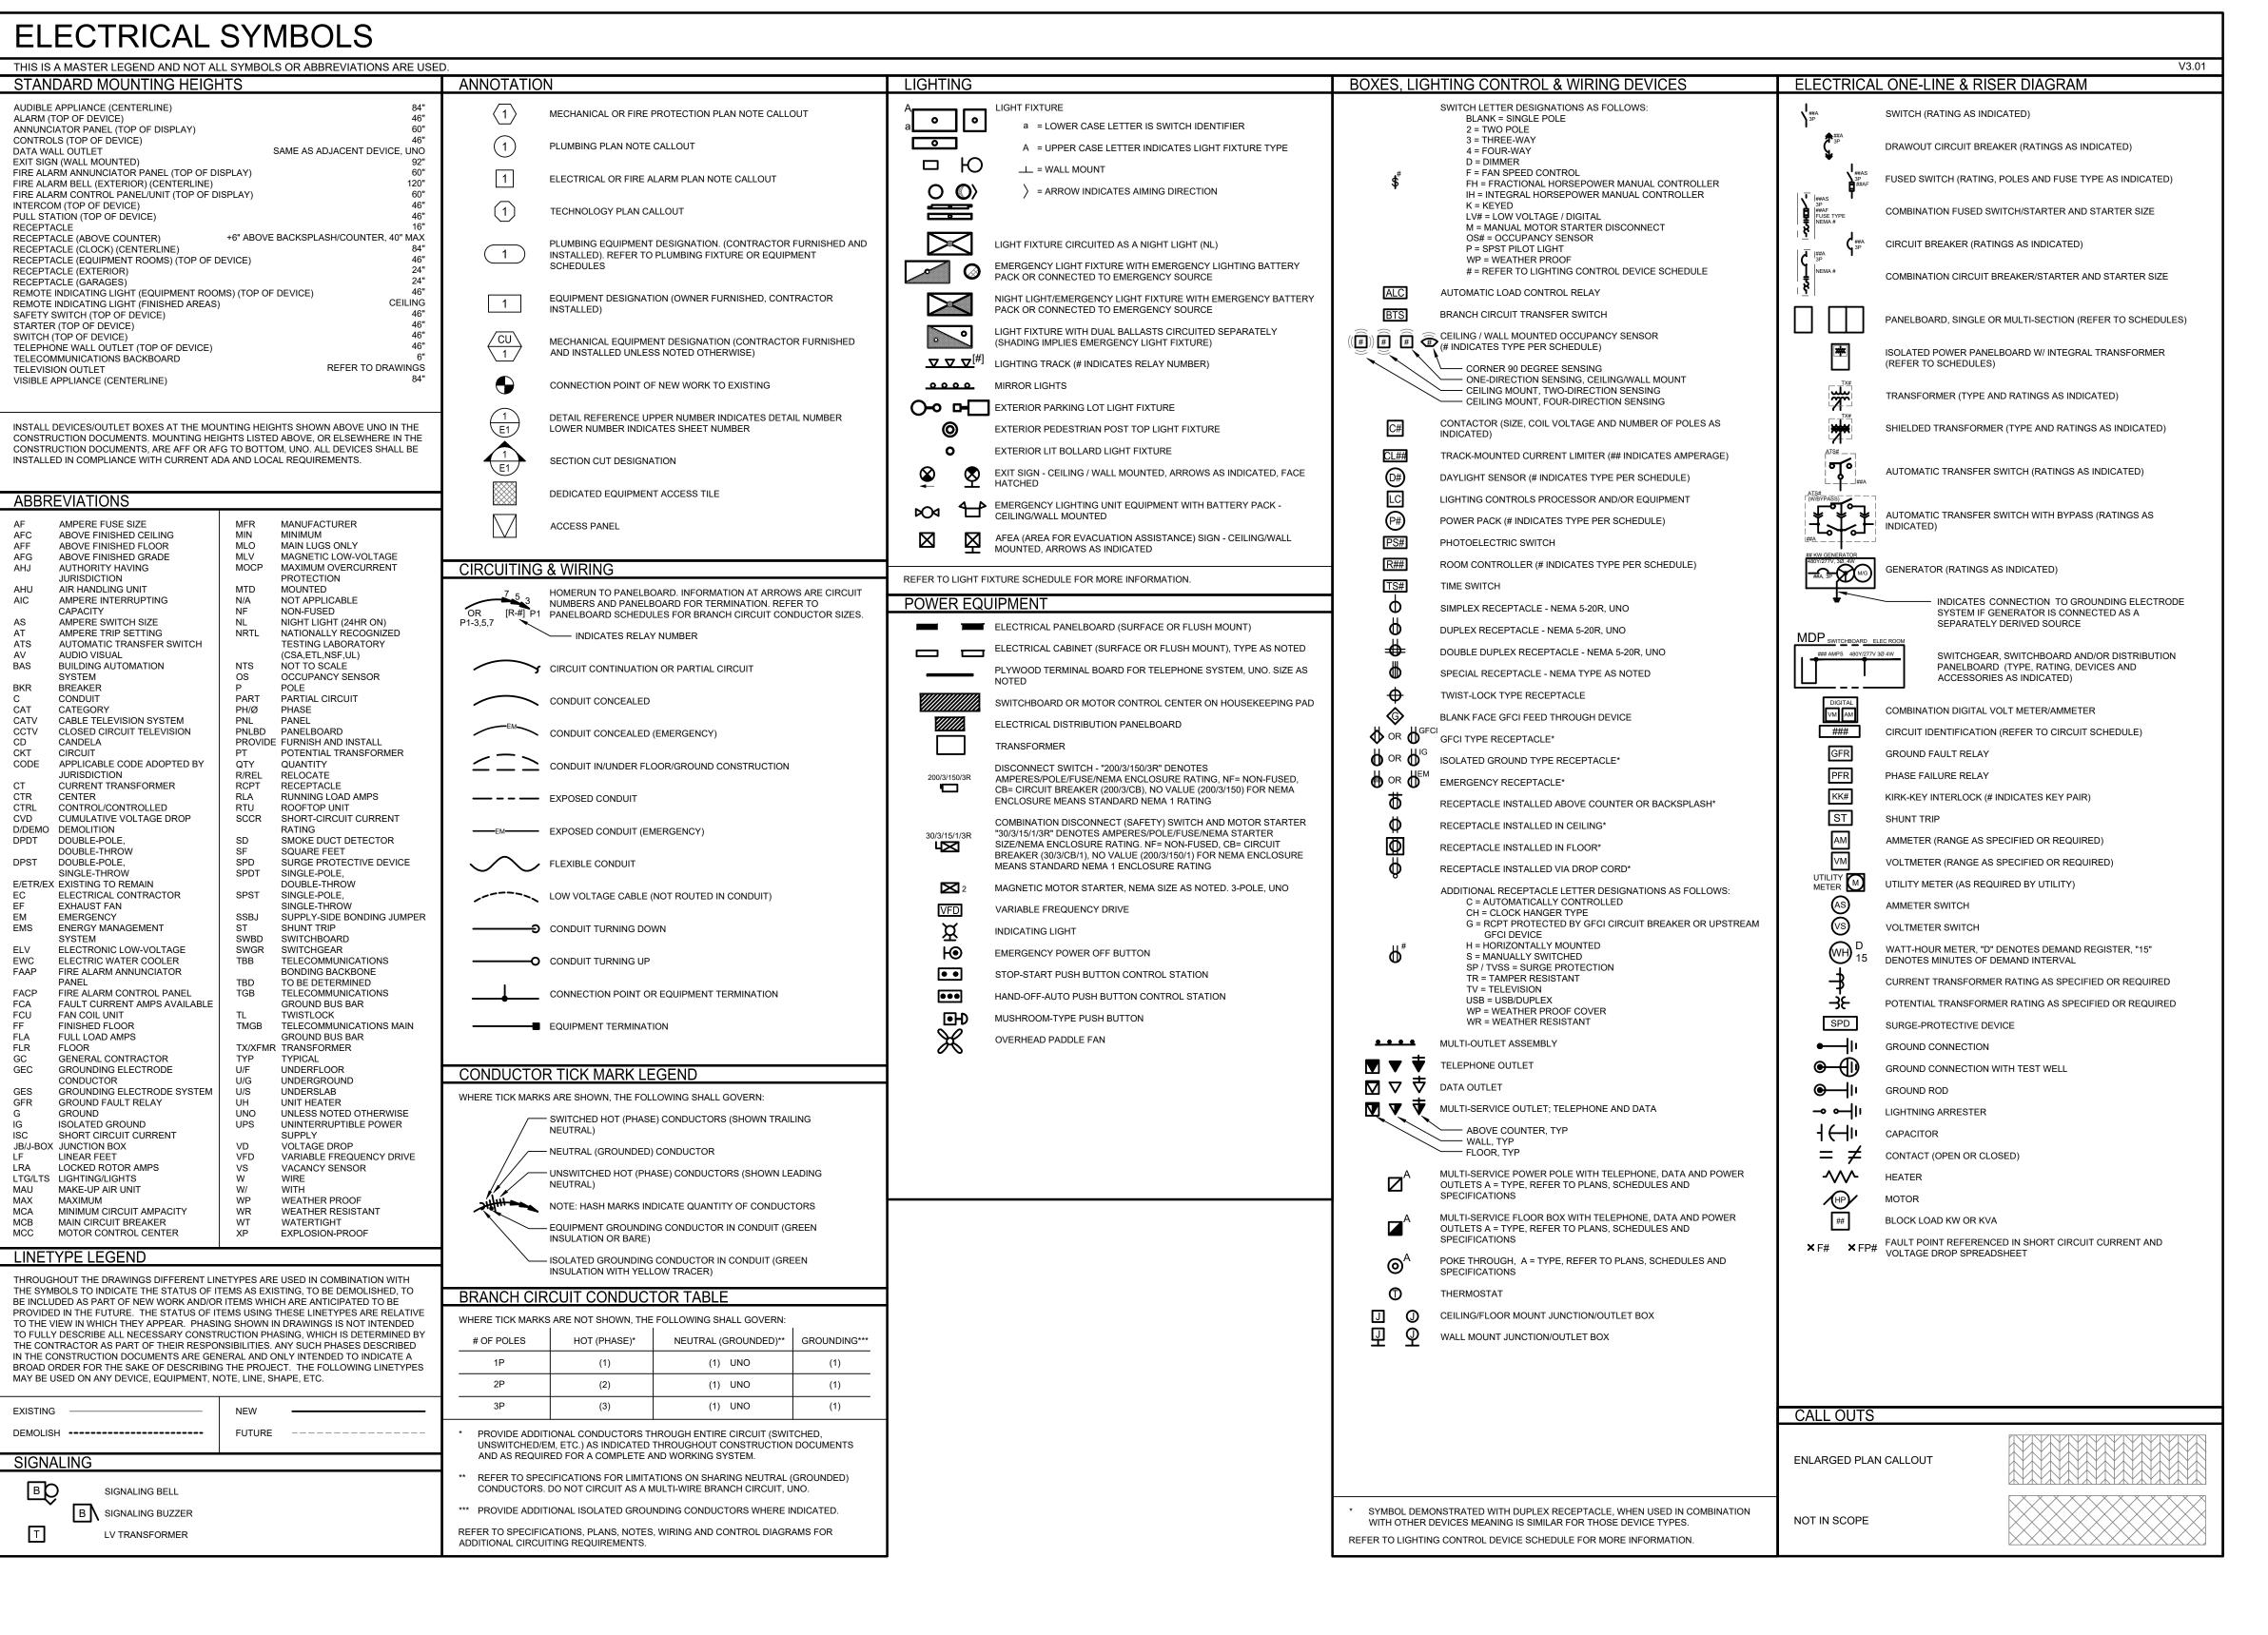

APPLICABLE ELECTRICAL CODES

NOTE: PROJECT IS DESIGNED IN COMPLIANCE WITH THE FOLLOWING CODES. THIS IS NOT AN EXHAUSTIVE LIST. PROJECT SHALL COMPLY WITH ALL APPLICABLE CODES, STANDARDS AND LOCAL REQUIREMENTS. REFER TO THE SPECIFICATIONS FOR ADDITIONAL REQUIREMENTS.

ELECTRICAL CODE: 2020 NATIONAL ELECTRICAL CODE, (NFPA 70)

BUILDING CODE: 2021 INTERNATIONAL BUILDING CODE

ENERGY CODE: 2019 ASHRAE 90.1, WITH LOCAL AMENDMENTS

SITE ELECTRICAL GENERAL NOTES:

REFER TO CIVIL DRAWINGS AND SPECIFICATIONS FOR ADDITIONAL INFORMATION. COORDINATE THE EXACT LOCATION OF ALL SITE LIGHTING POLES, SIGNAGE, UNDERGROUND UTILITIES, CONDUITS,

- CIRCUITRY, TRANSFORMERS AND OTHER EQUIPMENT WITH CIVIL DRAWINGS, LANDSCAPING DRAWINGS AND OWNER PRIOR TO INSTALLATION.

 2. COORDINATE ALL SITE ELECTRICAL REQUIREMENTS WITH EQUIPMENT MANUFACTURER INFORMATION
- AND OTHER TRADES AND ADJUST ELECTRICAL PROVISIONS AS REQUIRED TO MEET REQUIREMENTS.

 3. SITE ELECTRICAL CONDUITS SHALL BE 1" MINIMUM, UNLESS NOTED OTHERWISE. WHERE PRACTICABLE ALL SITE ELECTRICAL CONDUITS SHALL BE INSTALLED A MINIMUM OF 33" (OR FROST DEPTH) BELOW

GRADE, UNLESS NOTED OTHERWISE. COORDINATE EXACT CONDUIT ROUTING WITH EXISTING

- OBSTRUCTIONS AND OTHER TRADES AND ADJUST AS NECESSARY.


 4. CAP AND MARK ALL UNDERGROUND CONDUITS PROVIDED FOR FUTURE USE AND INCLUDE PULL STRINGS. PROVIDE DIMENSIONED LOCATIONS OF TERMINATION POINTS ON AS-BUILT DRAWINGS AND
- 5. MINIMUM WIRE SIZE FOR SITE ELECTRICAL CIRCUITS SHALL BE #10 AWG CU, UNLESS NOTED OTHERWISE. ALL SITE ELECTRICAL BRANCH CIRCUIT WIRING SHALL BE SIZED SUCH THAT THE MAXIMUM BRANCH CIRCUIT VOLTAGE DROP IS LESS THAN 3 PERCENT. FEEDER CIRCUITS TO SPORTS LIGHTING POLES SHALL BE SIZED SUCH THAT THE MAXIMUM VOLTAGE DROP IS LESS THAN 5 PERCENT.
- 6. PROVIDE SPLICE AND PULL BOXES FOR SITE LIGHTING AND SITE ELECTRICAL POWER TO LIMIT MAXIMUM CONDUIT RUN TO 300'. DO NOT EXCEED 3 BENDS FOR ANY SINGLE RUN. PLACE BOXES IN A PLANTER AREA CLEAR OF VEGETATION WHEREVER PRACTICABLE AND CO-LOCATE WITH LOW VOLTAGE BOXES; (COORDINATE EXACT LOCATION WITH CIVIL, LANDSCAPE CONTRACTOR AND OWNER). BOXES SHALL BE SUITABLE FOR LOCATION AND PROPERLY SIZED FOR QUANTITY AND SIZE OF CONDUITS IN AND OUT AND SHALL BE MARKED "ELECTRICAL". NOT ALL OF THESE BOXES ARE SHOWN ON SITE ELECTRICAL DRAWINGS; CONTRACTOR SHALL PROVIDE LOCATION ON AS-BUILT DRAWINGS AND SUBMIT TO OWNER. SPLICE BOX SHALL BE APPROPRIATE FOR LOCATION AND SHALL BE INSTALLED PER MANUFACTURER'S RECOMMENDATIONS. SPLICE BOX SHALL HAVE A MINIMUM NOMINAL SIZE OF 12"X12"X12", SHALL BE AN OPEN BOTTOM NRTL LISTED UNDERGROUND ENCLOSURE, AND SHALL AT A MINIMUM BE TIER 15 TRAFFIC RATED.
- 7. PROVIDE PULL BOXES FOR SITE DATA, TELECOM, SECURITY CABLING TO LIMIT MAXIMUM CONDUIT RUNS TO 175'. DO NOT EXCEED 3 BENDS FOR ANY SINGLE RUN. PLACE BOXES IN A PLANTER AREA CLEAR OF VEGETATION WHEREVER PRACTICABLE. BOXES SHALL BE SUITABLE FOR LOCATION AND PROPERLY SIZED FOR QUANTITY AND SIZE OF CONDUITS IN AND OUT AND SHALL BE MARKED "LOW VOLTAGE". GENERAL ROUTING OF MAIN LOW VOLTAGE CONDUIT RUNS HAVE BEEN DOCUMENTED ON SITE ELECTRICAL DRAWINGS, BUT FINAL ROUTING AND EXACT QUANTITY, SIZE, AND LOCATION OF PULL BOXES IS SUBJECT TO CHANGE BASED ON COORDINATION WITH OTHER DISCIPLINES AND TRADES. CONTRACTOR SHALL PROVIDE LOCATION ON AS-BUILT DRAWINGS AND SUBMIT TO OWNER. PULL BOX SHALL BE APPROPRIATE FOR LOCATION AND SHALL BE INSTALLED PER MANUFACTURER'S RECOMMENDATIONS. PULL BOX SHALL HAVE A MINIMUM NOMINAL SIZE OF 12"X12"X12", SHALL BE AN OPEN BOTTOM NRTL LISTED UNDERGROUND ENCLOSURE, AND SHALL AT A MINIMUM BE TIER 15 TRAFFIC RATED.
- 8. REFER TO SPECIFICATION 265668 EXTERIOR ATHLETIC FIELD LIGHTING FOR SPECIFIC REQUIREMENTS FOR FIELD LIGHTING.
- 9. CONDUITS SHALL NOT BE ROUTED UNDER ANY ATHLETIC FIELD PLAYING SURFACES AS INDICATED ON
- 10. ATHLETIC FIELD LIGHTS SHALL NOT BE USED FOR GENERAL ILLUMINATION DURING THE CONSTRUCTION PROCESS WITHOUT THE WRITTEN PERMISSION OF THE OWNER.

HENDERSON ENGINEERS

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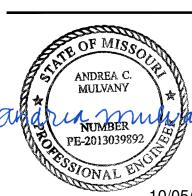
MO Land Surveying Corp. # 2004004672

Missouri Engineering Corp. # 2004005018

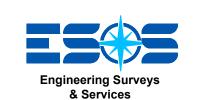

Project CP222681 GS FOOTBALL PRACTICE FIELD LIGHTING

UNIVERSITY OF MISSOURI - COLUMBIA FOR THE CURATORS OF THE UNIVERSITY OF MISSOURI



ANDREA C. MULVANY
LICENSE # PE-2013039892
PROFESSIONAL SEAL

REVISIONS

 JOB NO:
 CP222681


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ELECTRICAL
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DRAWN BY:

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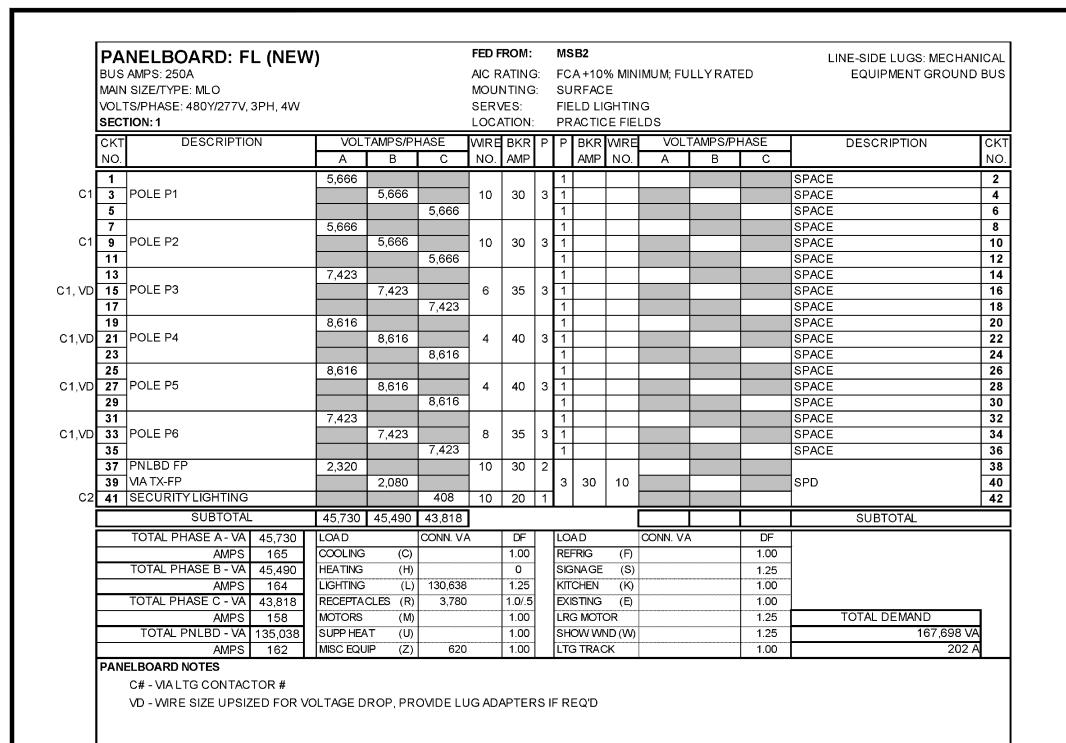
JOB NO: CP222681
DATE: 10-06-22

ACM

ELECTRICAL SITE PLAN

CHECKED BY:

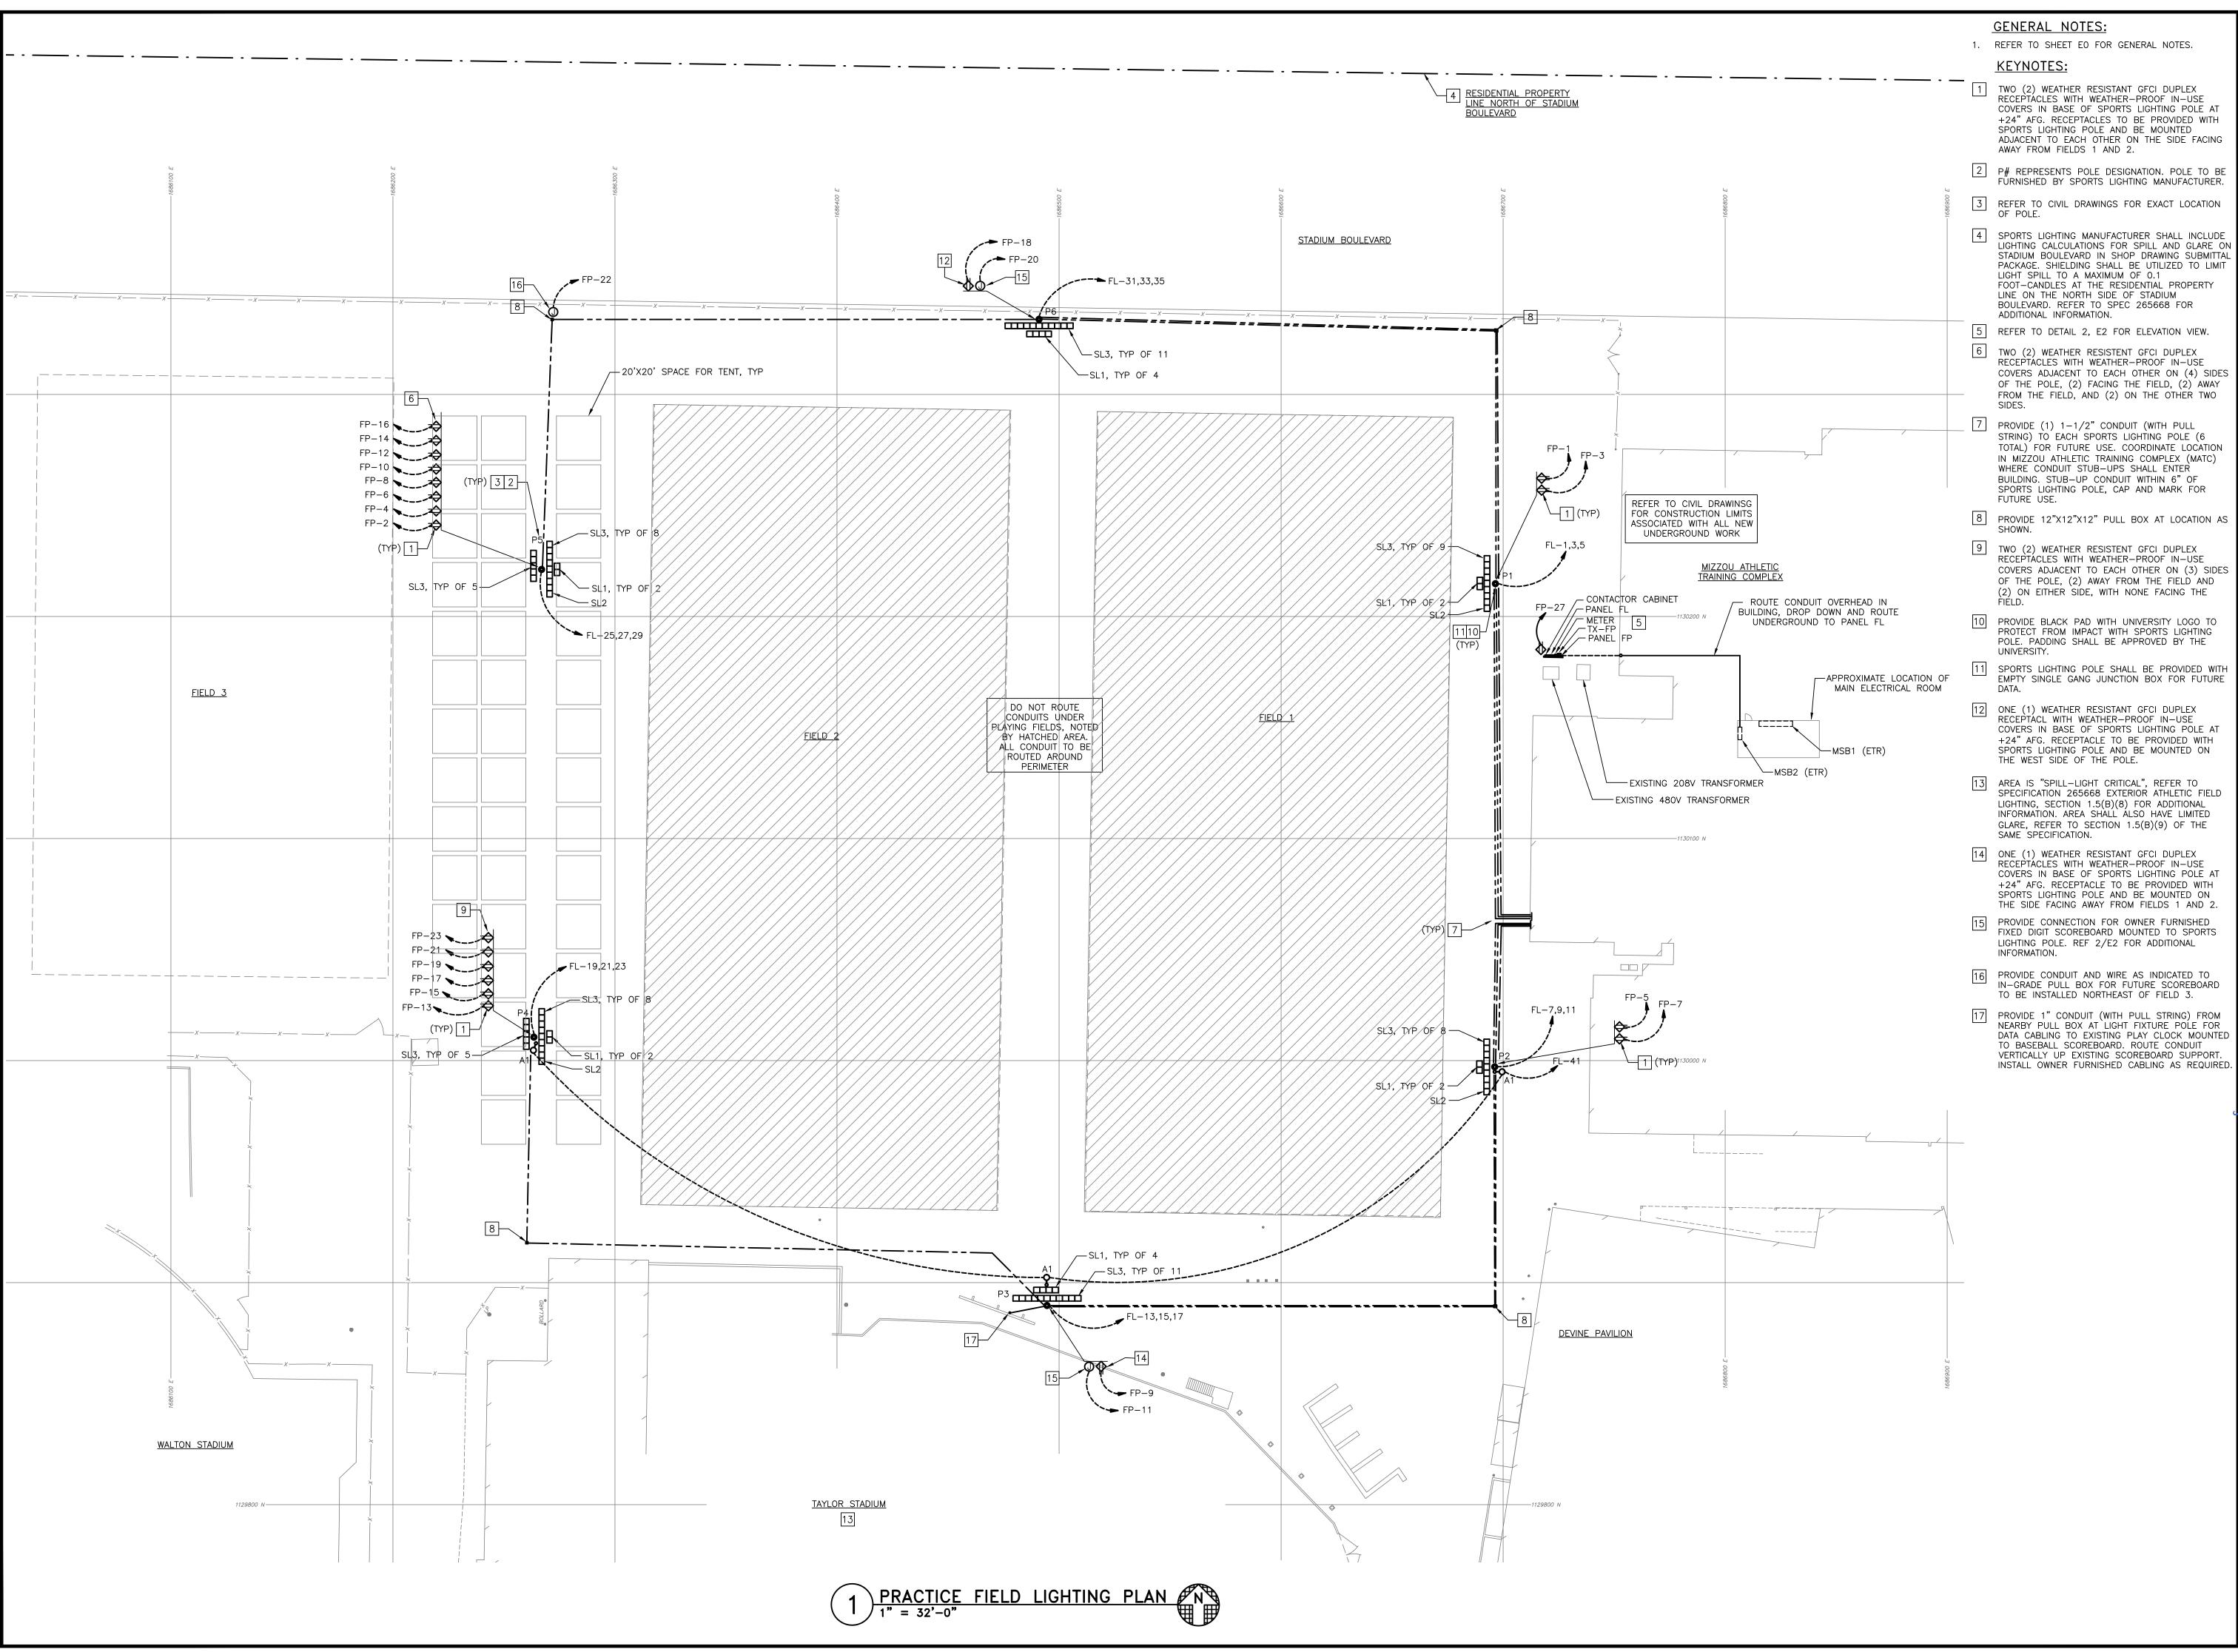E1



BUS MAIN VOLT	NELBOARD: FP (NEV AMPS: 100A SIZE/TYPE: 80A MCB S/PHASE: 120/240V, 1PH, 3W TON: 1	V)			AIC R MOU SER\	RATING NTING VES: ATION:	∂ : i:	FC SU FIE	RFAC		IMUM; FUI LDS	LLY RATE	D	LINE-SIDE LUGS: MECH, EQUIPMENT GROUN	
СКТ	DESCRIPTION		VOLTAM		4		Р	Р			VOLTAM			DESCRIPTION	СК
NO.			Α	В	NO.	AMP			AMP	NO.	Α	В			NO
1	POLE P1 RECEPT A		180		10	20	1	1	20	6	180		POLE P5	RECEPTA	2
3	POLE P1 RECEPT B			180	10	20	1	1	20	6		180	POLE P5	RECEPTB	4
_	POLE P2 RECEPT A		180		10	20	1	1	20	6	180			RECEPT C	6
-	POLE P2 RECEPT B			180	10	20	1	1	20	6		180		RECEPT D	8
_	POLE P3 RECEPT A		180		8	20	1		20	6	180			RECEPTE	10
	POLE P3 SCOREBOARD			140	10	20	1	_	20	6		180		RECEPTF	12
	POLE P4 RECEPT A		180		6	20	1	<u> </u>	20	6	180		POLE P5 RECEPT G		14
	POLE P4 RECEPT B			180	6	20	1	<u> </u>	20	6		180		RECEPTH	16
	POLE P4 RECEPT C		180		6	20	1	L.	20	10	180			RECPTA	18
	POLE P4 RECEPT D			180	6	20	1	⊢ i	20	10		140		SCOREBOARD	20
	POLE P4 RECEPT E		180		6	20	1	_	20	10	140			SCOREBOARD (FUTURE)	22
	POLE P4 RECEPT F			180	6	20	1	⊢-	20				SPARE		24
	SPARE MAINTENANCE			400	40	20	1	_	20				SPARE SPARE		26
	LIGHTING CONTROLS		200	180	12	20	1	⊢-	20				SPARE		28
29					12	20	I	1	20				SPARE		30
	SUBTOTAL		1,280	1,220							1,040	860		SUBTOTAL	
	TOTAL PHASE A - VA 2,320	LOAD		CONN. V	Ά	DF		LO	AD		CONN. V	4	DF		
	AMPS 19	COOLING	(-)			1.00		REF	FRIG	(F)			1.00		
	TOTAL PHASE B - VA 2,080	HEATING	7.7			0			NAGE	(-)			1.25		
	AMPS 17	LIGHTING	(-/			1.25			CHEN	(K)			1.00		
	TOTAL PNLBD - VA 4,400	RECEPTA		3,780) 	1.0/.5			STING	(E)			1.00		_
	AMPS 18	MOTORS	(M)			1.00			G MOTO				1.25	TOTAL DEMAND	
		SUPP HEA	(-)			1.00				ND (W)			1.25	4,400	
	ELBOARD NOTES	MISC EQU	JIP (Z)	620		1.00		LTC	3 TRAC	JK.			1.00	18	8 A

BUILDING OCCUPANCY TYPE:	В	SERVICE DESCRIPTION:			
BUILDING SQUARE FOOTAGE:	101,000	480Y/277V, 3PH			
LOAD DESCRIPTION		Connected	Demand	Demand	
		KVA	FACTOR	KVA	
EXISTING PEAK DEMAND LOAD	@ 0.9 pf *	420.00	125%	525.0	
RECEPTACLES		4.14	100%;50%	4.1	
EXTERIOR LIGHTING	130.64	125%	163.3		
EXISTING LOAD TO BE DELETED)	0.00	100%	0.0	
TOTAL LOAD		554.98	KVA	692.6	
TOTAL AMPACITY		667.53	AMPS	833.1	
SERVICE AMPACITY		1000	AMPS	1000.0	
SPARE CAPACITY			AMPS	16	
*PER METERING REPORT WITH	PEAK DEM	AND OF:	378 KW	Aug-202	

BUILDING ELECTRICAL SERVICE LOAD SUMMARY								
BUILDING OCCUPANCY TYPE:	В	SERVICE DESCRIPTION:						
BUILDING SQUARE FOOTAGE:	101,000	480Y/277V, 3PH						
LOAD DESCRIPTION Con			Demand	Demand				
		KVA	FACTOR	KVA				
EXISTING PEAK DEMAND LOAD @	0.9 pf*	420.00	125%	525.00				
RECEPTACLES		4.14	100%;50%	4.14				
EXTERIOR LIGHTING		130.64	125%	163.30				
EXISTING LOAD TO BE DELETED		0.00	100%	0.00				
TOTAL LOAD		554.98	KVA	692.64				
TOTAL AMPACITY		667.53	AMPS	833.11				
SERVICE AMPACITY		1000	AMPS	1000.00				
SPARE CAPACITY			AMPS	167				

FEEDER SCHEDULE:

40A, (2)#8, (1)#10G, 1/2" C

254 250A, (4)-250kcmil, (1)#4G, 2-1/2" C

ES1004 EXISTING 1000A, (3) 3" C, EACH W/(4)-400kcmil G8 GND, #8 COPPER GROUND, 3/4" C

T83 80A, (3)#4, (1)#8 SSBJ, 1" C

ONELINE DIAGRAM KEYED NOTES:

1 INSTALL INSTRUMENT CLASS UTILITY METER FOR FIELD LIGHTING. METER SHALL BE FURNISHED BY UNIVERSITY OF MISSOURI ENERGY MANAGEMENT. INSTALL PER UNIVERSITY REQUIREMENTS.

2 DEMOLISH EXISTING CIRCUIT BREAKER FOR "DOCK LEVELER" IN MSB2.

CAMPUS PRIMARY

17,423 FCA

110 FEET

0.50% CVD

TRANSFORMER (EXISTING)

1200 AMPS

MSB2 (ETR)

DEMO

480Y/277V, 3P, 4W SEC

UTILITY METER

1000A

750 kVA

3 INSTALL NEW ABB TMAX XT4 RETROFIT KIT FOR SPECTRA PANELBOARDS. INSTALL IN TOP SECTION OF MSB2 ONCE 20A/3P CIRCUIT BREAKER FOR "DOCK LEVELER" HAS BEEN REMOVED.

ELECTRIC UTILITY CONTACT NOTE

UTILITY COMPANY: UNIVERSITY OF MISSOURI UTILITY CONTACT: MU ENERGY MANAGEMENT

PHONE: (573) 882-3094

FAULT CURRENT GENERAL NOTE (ESTIMATE):

THE MAXIMUM AVAILABLE 3-PHASE SYMMETRICAL FAULT CURRENT VALUE AT THE UTILITY TRANSFORMER SECONDARY/POINT OF SERVICE COULD NOT BE DETERMINED AT THE TIME OF THIS SUBMITTAL. THE ESTIMATED WORST CASE VALUE OF 17,449A IS BASED ON AN INFINITE BUS CALCULATION AT THE UTILITY TRANSFORMER. CONTRACTOR SHALL VERIFY ACTUAL AVAILABLE FAULT CURRENT VALUE WITH UTILITY. NOTIFY ENGINEER IF ACTUAL VALUE EXCEEDS ESTIMATED CALCULATED VALUE. ESTIMATED DESIGN VALUE IS BASED ON THE FOLLOWING:

UTILITY TRANSFORMER SECONDARY VOLTAGE: 480Y/277V 3Ø, 4W UTILITY TRANSFORMER SIZE: 750KVA, Z=5.17%

ARC FLASH GENERAL NOTE:

480Y/277V 3Ø 4W

12.545 FCA

1.02% CVD

115 FFFT

PERFORM ARC FLASH ANALYSIS, PREPARE AND SUBMIT WRITTEN REPORT TO OWNER AND INSTALL LABELING IN COMPLIANCE WITH ARTICLE 130 OF NFPA 70e PER AIA A104 16.2.8 AND SPECIFICATION 26 05 73.

MATC MAIN ELEC ROOM

ADDITIONAL CIRCUIT

FOR CLARITY. ALL

EXISTING CIRCUIT

1.05% CVD

[□]15KVA 480Y/277V PRIM 240/120V SEC

2,412 FCA

2.400 FCA

5 FEET

BREAKERS NOT SHOWN

BREAKERS SHALL REMAIN

LIGHT FIXTURES

AS REQUIRED -

PROVIDE HAND/OFF/AUTO CONTROL FOR (2)

BE OUTSIZE THE ARC FLASH BOUNDARY OF

ZONES OF SPORTS LIGHTING AND (1) ZONE OF

SECURITY LIGHTING. LIGHTING CONTROLS SHALL

└ TO POLES AS REQUIRED

+90'-0" AFG, TYP —

SPORTS LIGHTING FIXTURES

PROVIDED BY SPORTS LIGHTING VENDOR

1. THE FEEDER LENGTHS SHOWN ON THE ONE-LINE DIAGRAM ARE FOR CALCULATION PURPOSES ONLY. CONTRACTOR SHALL NOT USE THE CONDUIT TYPES, CONDUCTOR TYPES, SIZES, QUANTITIES OR LENGTHS

ONE-LINE DIAGRAM GENERAL NOTES:

FOR TAKEOFFS OR BIDDING PURPOSES. CONTRACTOR SHALL NOTIFY ENGINEER OF ANY CONFLICTS BETWEEN THIS SCHEDULE AND OTHER PORTIONS OF THE CONSTRUCTION DOCUMENTS. CONTRACTOR SHALL NOTIFY ENGINEER OF AS-BUILT CONDITIONS THAT CONSTITUTE A CHANGE FROM WHAT IS SHOWN BELOW; THIS INCLUDES CONDUCTOR LENGTHS DIFFERING BY MORE THAN 10%.

HENDERSON

ENGINEERS

1801 MAIN STREET, SUITE 300

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WWW.HENDERSONENGINEERS.COM

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Engineering Surveys

& Services

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573 - 449 - 2646

www.ess-inc.com

MO Land Surveying Corp. # 2004004672

Missouri Engineering Corp. # 2004005018

CP222681 GS FOOTBALL

MISSOURI - COLUMBIA

THE UNIVERSITY OF

FOR THE CURATORS OF

ANDREA C

MULVAN

NUMBER

\ PE-2013039892 /

REVISIONS

CP222681

ACM

10-06-22

ANDREA C. MULVANY

PROFESSIONAL SEAL

JOB NO:

CHECKED BY:

DRAWN BY:

DATE:

LICENSE # PE-2013039892

PRACTICE FIELD

UNIVERSITY OF

LIGHTING

MISSOURI

2. FEEDER NUMBER DESIGNATIONS PRECEDED BY "V" INDICATE THAT THE CONDUCTORS ARE UP-SIZED DUE TO VOLT-DROP CONSIDERATIONS. PROVIDE LUG ADAPTERS AS NEEDED IN ORDER TO PROPERLY LAND CONDUCTORS AT TERMINATION(S).

4. FEEDER SIZES ARE BASED ON COPPER (CU) THHN/THWN-2 INSULATION, UNLESS NOTED OTHERWISE. ALL CONDUCTOR SIZES ARE BASED ON 75 DEG C RATED TERMINATIONS, UNLESS NOTED OTHERWISE. CONDUIT SIZES SHOWN ARE APPROPRIATE FOR SCHEDULE 40 PVC, EMT, GRS, IMC AND RMC; ADJUST SIZE AS NEEDED FOR OTHER RACEWAY TYPES. FOR ANY OTHER CONDITIONS MODIFY SIZES PER CODE. REFER TO SPECIFICATIONS FOR ADDITIONAL INFORMATION.

5. BRANCH CIRCUIT SIZES ARE BASED ON COPPER (CU) THHN/THWN-2 INSULATION, UNLESS NOTED OTHERWISE. CONDUIT SIZES SHOWN ARE APPROPRIATE FOR SCHEDULE 40 PVC. EMT. GRS. IMC AND RMC: ADJUST SIZE AS NEEDED FOR OTHER RACEWAY TYPES. ALL CONDUCTOR SIZES ARE BASED ON 60 DEG C RATED TERMINATIONS, UNLESS NOTED OTHERWISE, FOR ANY OTHER CONDITIONS MODIFY SIZES PER CODE REFER TO SPECIFICATIONS FOR ADDITIONAL INFORMATION.

6. INSTALL FEEDERS OVERHEAD AS HIGH AS PRACTICABLE AND ORTHOGONALLY ALONG BUILDING STRUCTURE, UNLESS NOTED OTHERWISE. COORDINATE FINAL ROUTING WITH OTHER TRADES.

7. PROVIDE SCHEDULE 80 PVC FOR ALL UNDERGROUND CONDUIT 1" AND SMALLER. PROVIDE SCHEDULE 40 PVC FOR ALL UNDERGROUND CONDUIT LARGER THAN 1".

8. PROVIDE A PERMANENT LABEL ON FRONT OF EQUIPMENT ENCLOSURE: REFER TO SPECIFICATIONS FOR LABEL REQUIREMENTS. LABEL SHALL READ AS FOLLOWS (INCLUDE RESPECTIVE NAMES IN BLANKS):

SERVICE EQUIPMENT LABEL: LINE 1: NOMINAL VOLTAGE AND FREQUENCY IN HERTZ LINE 2: SERVICE EQUIPMENT BUS RATING IN AMPS

LINE 3: SCCR OF SERVICE EQUIPMENT IN AMPS LINE 4: MAXIMUM AVAILABLE FAULT CURRENT IN AMPS

LINE 5: DATE CALCULATED

EXAMPLE: 208Y/120V, 60HZ

800A SCCR = 65,000A

> MAX AVAILABLE FAULT CURRENT = 58,815A CALCULATED: 01/01/2018

PANELBOARD/SWITCHBOARD LABEL:

LINE 1: PANELBOARD "_____" SUPPLIED BY UPSTREAM LINE 2: PANELBOARD/SWITCHBOARD "_____"

LINE 3: LOCATED IN "____

LINE 4: PANELBOARD "_____" SUPPLIES DOWNSTREAM LINE 5: PANELBOARD(S) "_____

TRANSFORMERS LABEL: LINE 1: TRANSFORMER "_____" SUPPLIED BY UPSTREAM LINE 2: PANELBOARD/SWITCHBOARD "_____"

LINE 3: LOCATED IN "_____ LINE 4: TRANSFORMER "_____" SUPPLIES DOWNSTREAM

BRANCH CIRCUIT CONDUIT

PROVIDED BY CONTRACTOR

AND CONDUCTORS

PARTIAL ONE-LINE DIAGRAM

PROVIDE TYPE A1 FIXTURE ON SELECTED POLES, REFER TO PLANS FOR LOCATIONS REQUIRED. INSTALL AT +25'-0" AFG AND AIM AT PATH SOUTH OF FIELDS. COORDINATE WITH SPORTS LIGHTING VENDOR -FIXED DIGIT SCOREBOARD, +15'-0" AFG, OWNER FURNISHED, OWNER INSTALLED, POLES P3 AND P6 ONLY. -

WIRELESS CONNECTION TO ALLOW FOR APP-BASED CONTROL OF LIGHT FIXTURES 480Y/277V, 3P PANELBOARD FL PROVIDED BY CONTRACTOR REVENUE METER

SPORTS LIGHTING CONTROLS SHALL INCLUDE

FURNISHED BY UNIVERSITY INSTALLED BY CONTRACTOR REFER TO DETAIL 3, THIS SHEET-

 PROVIDE UNISTRUT SUPPORT FOR ELECTRICAL EQUIPMENT - LIGHTING CONTROL CABINET PROVIDED BY SPORTS LIGHTING VENDOR

> PLANS FOR QUANTITY) -IN-GRADE PULL BOX ADJACENT TO POLE FOR DATA CONDUITS, PROVIDED BY CONTRACTOR

-EXISTING PLAY CLOCK

TO BE MOUNTED TO

NEW LIGHTING POLE

+21'-0" AFG, OWNER

INSTALLED, POLE P6

ONLY.

ELECTRICAL

10 KVA TRANSFORMER TX-FP PROVIDED BY CONTRACTOR REMOTE DRIVER CABINET, 240/120V, 1P PANELBOARD FP +10'-0" AFG, PROVIDED BY PROVIDED BY CONTRACTOR -SPORTS LIGHTING VENDOR (WHERE APPLICABLE) WP/WR GFCI RECEPTACLE, -HANDHOLE +36" AFG, CIRCUITED TO FP-27 SPORTS LIGHTING POLES AND PROVIDED BY SPORTS PROVIDED BY CONTRACTOR -FOUNDATIONS LIGHTING VENDOR PROVIDED BY SPORTS LIGHTING VENDOR -BLANK SINGLE GANG JUNCTION BOX FOR FUTURE FEEDER CONDUIT AND DATA +24" AFG, PROVIDED BY CONDUCTORS PROVIDED BY SPORTS LIGHTING VENDOR CONTRACTOR (ONE PER POLE) -CONVENIENCE FROM MSB2 IN MATC MAIN ___ RECEPTACLES AT +24" AFG, ELECTRICAL ROOM PROVIDED BY CONTRACTOR PROVIDED BY SPORTS LIGHTING VENDOR (REF EMPTY DATA CONDUIT (WITH METER TERMINAL BOX PULL STRING) PROVIDED BY PROVIDED BY CONTRACTOR CONTRACTOR -

ELECTRICAL PANELS

2) ELECTRICAL EQUIPMENT ELEVATION

MANUFACTURER / MODEL # MCGRAW-EDISON GLEON-SA4D-750-U-T2 LED

CT BOX 🔨 TO LOAD FROM MSB2 - 1" MIMINUM RGS CONDUIT PVC COATED (OR TAPED) UNDERGROUND FROM TRANSFORMER - METER TERMINAL BOX HOFFMAN A10R86HCR WITH SUB-PANEL AND GROUNDING DEVICE MOUNT NEXT TO METER BASE 1" MIMINUM RGS CONDUIT

BOTTOM OR SIDE ENTRY

(1) COOPER BUSSMAN FUSE BLOCK BMM603-3C WITH CVR-CCM NON-INDICATING COVER, , 30A 600V

(2) COOPER BUSSMAN FUSE BLOCK BMM603-3C WITH

CVR-CCM NON-INDICATING COVER, 30A 600V

INSTALLED IN METER TERMINAL BOX.

CATALOG #UC7445-XL, 13 TERMINAL

WITH TEST SWITCH (OR EQUAL)

INSTALLED IN CT BOX.

FUSE: BUSSMAN KTK-2

3 MILBANK METER BASE

PRF-WIRFD

FUSE: BUSSMAN KTK-15

4. INSTALL METER BASE AS SHOWN IN DETAIL 2, THIS SHEET. 5. METER BASE PREFERRED TO BE LOCATED SUCH THAT WIRING IS LIMITED TO 50 FT OR LESS. ELECTRIC METERING DETAIL

1. CONTRACTOR TO PROVIDE AND INSTALL CT'S,

FUSE BLOCKS AND FUSES, TERMINAL BOX, METER

2. OWNER TO TERMINATE ALL WIRING

3. INSTALL METER TERMINAL BOX NEAR

258 | 15-1/2" WIDE X 4" TALL X 22" DEEP LED AREA LIGHT WITH MOUNTING ARM. UL LISTED FOR WET LOCATIONS AND IP66

RATED. FULL CUTOFF WITH TYPE 2 DISTRIBUTION. MOUNT TO SPORTS LIGHTING POLE AT 30'-0" AFG, COORDINATE

METER BASE. COORDINATE WITH OWNER.

BOX SHALL BE NEMA 3R RATED WITH HINGED

BASE, AND WIRE.

LOCKING COVER.

LIGHT FIXTURE SCHEDULE

WATTS

HUBBELL RAR1 SERIES 30,714 LUMENS WITH SPORTS LIGHTING POLE VENDOR. MATCH COLOR TO SPORTS LIGHTING FIXTURES. 50.000 HRS SPORTS LIGHT FIXTURE SCHEDULE VOLTAGE INPUT | INPUT | DESCRIPTION LIGHT SOURCE TYPE WATTS VA 575 NONE 700 575W SPORTS LIGHT FIXTURE BASIS OF DESIGN: MUSCO PRE-APPROVED EQUALS: EPHESUS, SPORTSBEAMS

LIGHT SOURCE

70 CRI, 5000K

TYPE

NON-DIM

1170 1440 1200W SPORTS LIGHT FIXTURE NONE BASIS OF DESIGN: MUSCO PRE-APPROVED EQUALS: EPHESUS, SPORTSBEAMS 1500W SPORTS LIGHT FIXTURE BASIS OF DESIGN: MUSCO


ALTERNATES

LITHONIA D-SERIES

GARDCO PUREFORM SERIES

PRE-APPROVED EQUALS: EPHESUS, SPORTSBEAMS

A. OUTDOOR FIELD LIGHTING IS A DELEGATED DESIGN, REFER TO SPECIFICATION 265668 FOR ADDITIONAL INFORMATION. LIGHT FIXTURE SELECTIONS AND LOCATIONS ARE BASED ON BASIS OF DESIGN

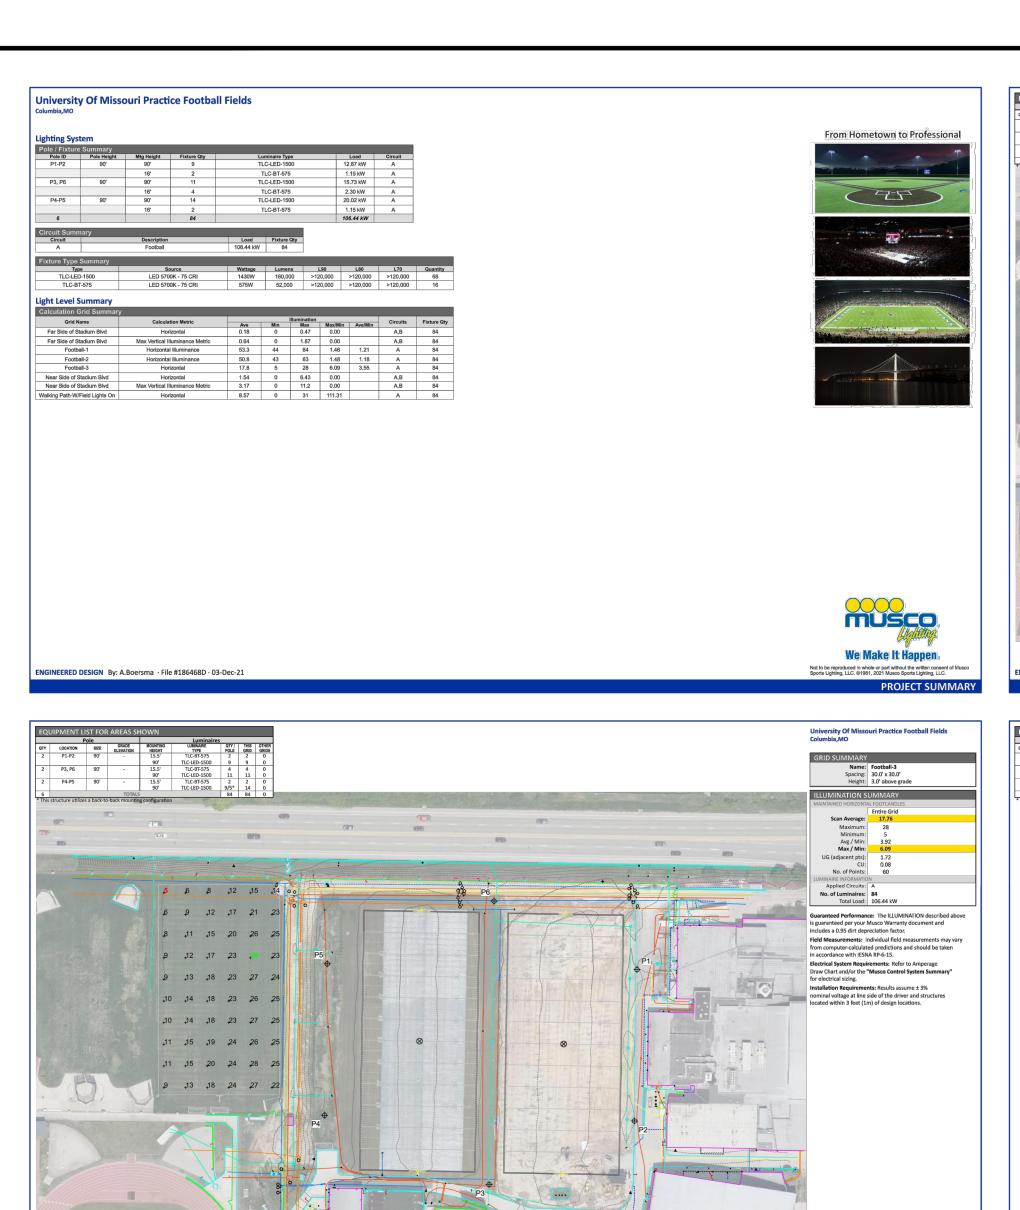

musco,

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Applied Circuits: A, B
No. of Luminaires: 84
Total Load: 106.44 kW


Guaranteed Performance: The ILLUMINATION described above is guaranteed per your Musco Warranty document.


in accordance with IESNA KH-b-15.


Electrical System Requirements: Refer to Amperage
Draw Chart and/or the "Musco Control System Summa
for electrical sizing.

Installation Requirements: Results assume ± 3%
nominal voltage at line side of the driver and structures
located within 3 feet (1m) of design locations.


MUSCO.

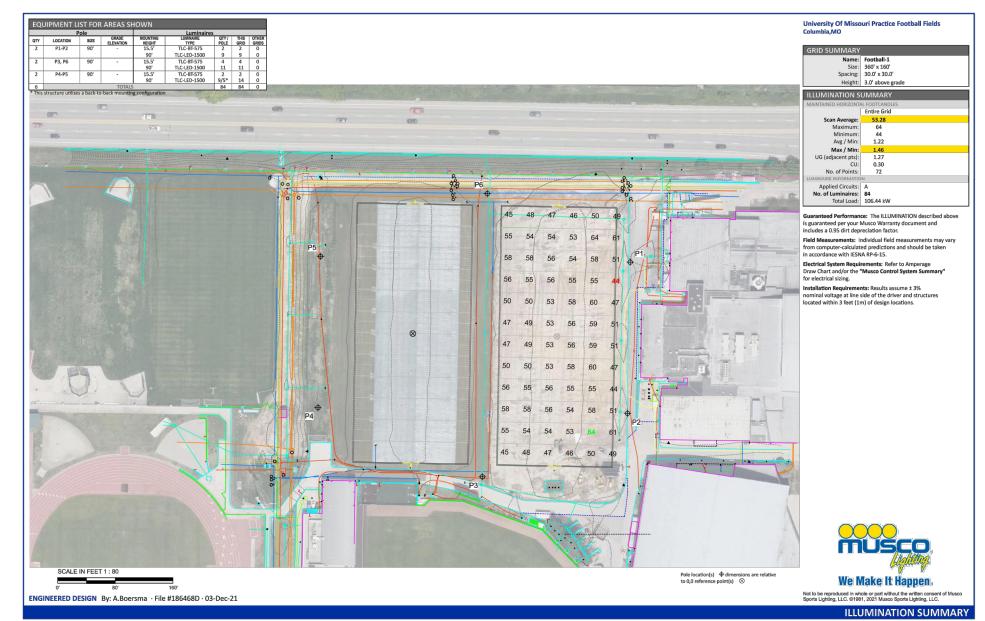

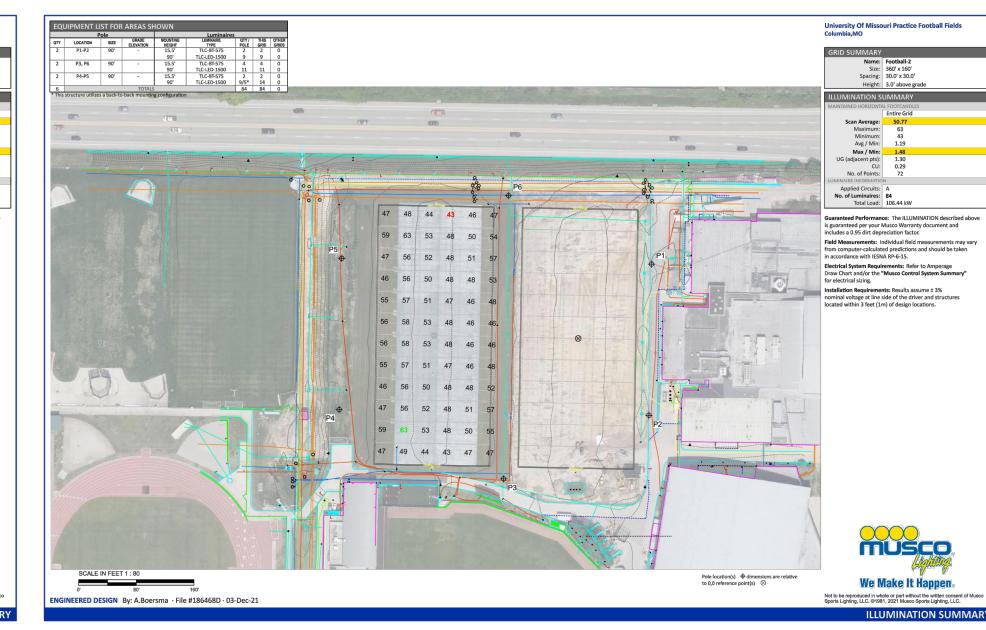

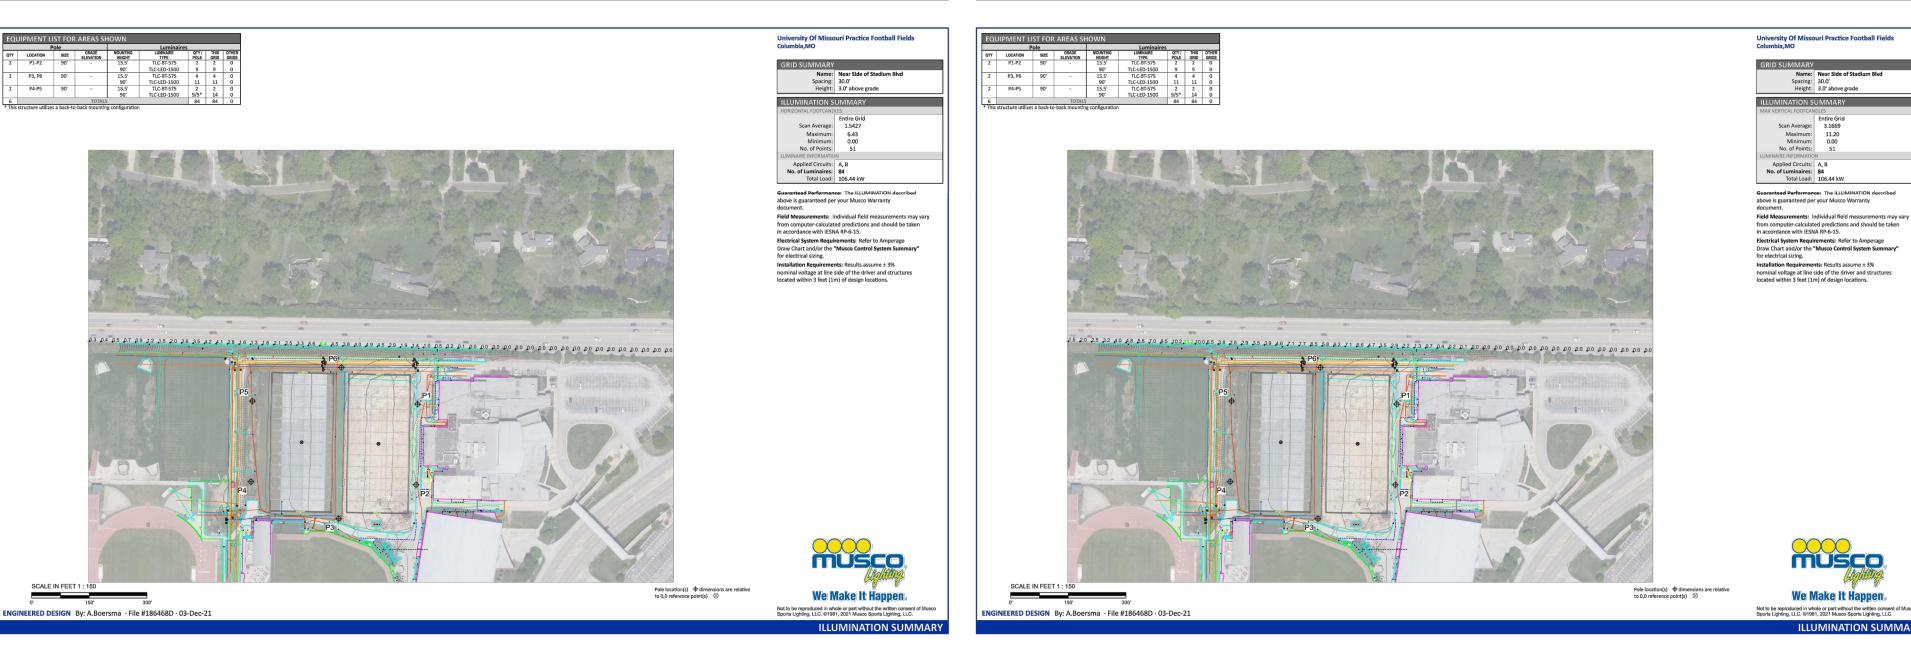



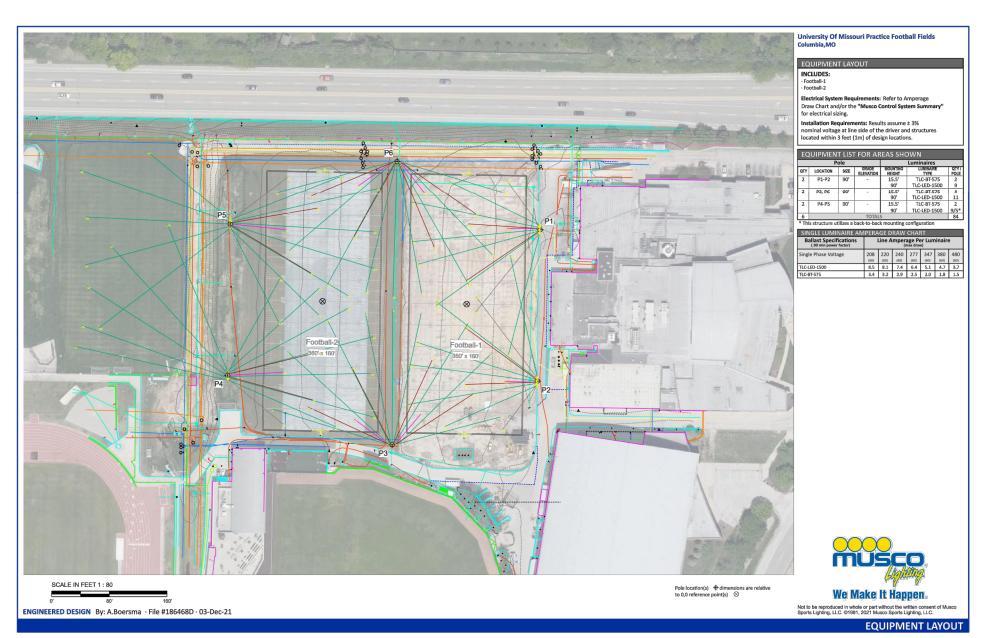



12/31/22



MO Land Surveying Corp. # 2004004672



Project CP222681 GS FOOTBALL PRACTICE FIELD LIGHTING

UNIVERSITY OF MISSOURI - COLUMBIA FOR THE CURATORS OF THE UNIVERSITY OF MISSOURI



10/05 ANDREA C. MULVANY LICENSE # PE-2013039892 PROFESSIONAL SEAL

REVISIONS

 JOB NO:
 CP222681

 DATE:
 10-06-22

 CHECKED BY:
 ACM

 DRAWN BY:
 LKV

PHOTOMETRIC CALCULATIONS

INEERED DESIGN By: A.Boersma · File #186468D · 03-Dec-21

GINEERED DESIGN By: A.Boersma · File #186468D · 03-Dec-21