# HILL HALL BUILDING ENVELOPE REPAIRS COLUMBIA, MO

Project CP220951
UNIVERSITY OF MISSOURI
FOR THE CURATORS OF THE UNIVERSITY OF MISSOURI
COLUMBIA, MISSOURI



PREPARED BY:




Issued for Bid: October 27, 2023

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	"I HEREBY CERTIFY THESE DRAWINGS AND/OR SPECFICATIONS HAVE BEEN PREPARED BY ME, OR UNDER MY SUPERVISION. I FURTHER
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	AND/OR SPECIFICATIONS ARE AS REQUIRED BY AND IN COMPLIANCE
	WITH THE BUILDING CODES OF THE UNIVERSITY OF MISSOURI".
	SIGNATURE
	<del>-7//+</del>
	DW ADCHITECTS INC
	PW ARCHITECTS, INC.

ISSUED: 10/27/2023



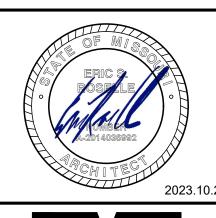




HILL HALL BUILDING ENVELOPE REPAIRS


COLUMBIA, MO
University of Missouri
For: The Curators of the University of Missour


Drawn		Project Number:	
ER		202224	
Check	ed:	CAD File Name (	Number):
ER		G001.DWG	
COA	ER SHEET		
No.	Revisions:		Date
	i		Date

10/24/2023

G001

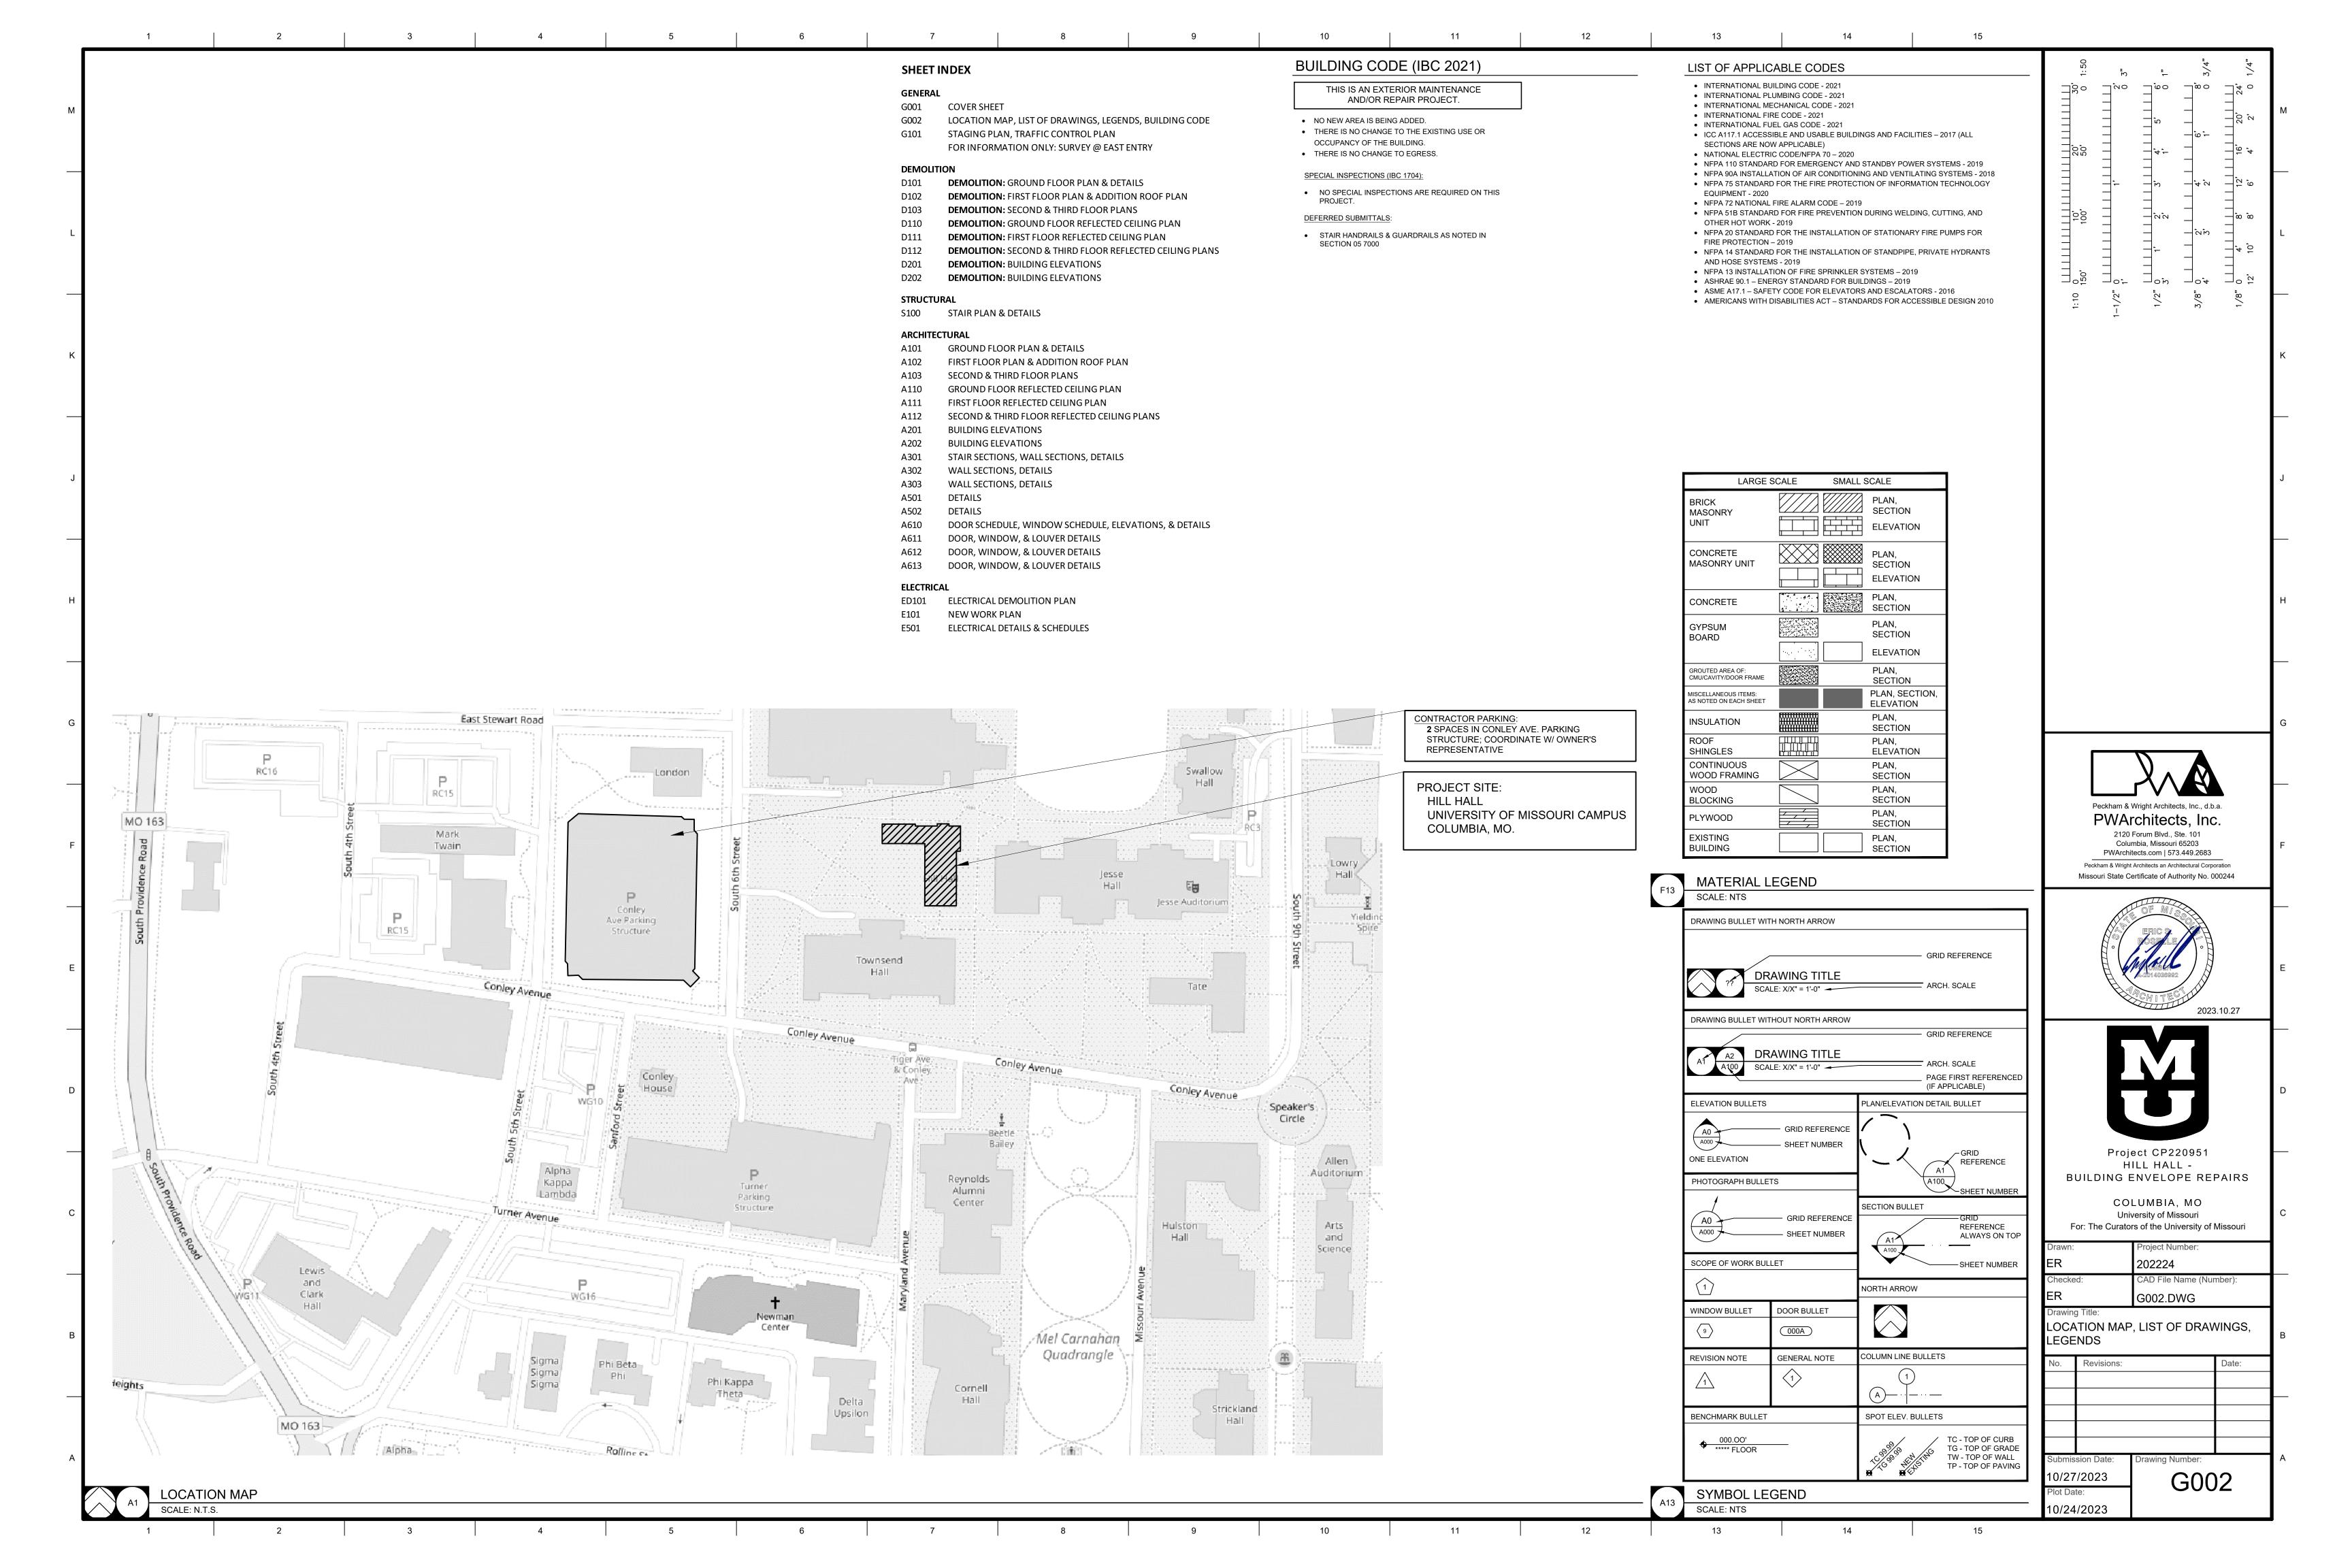

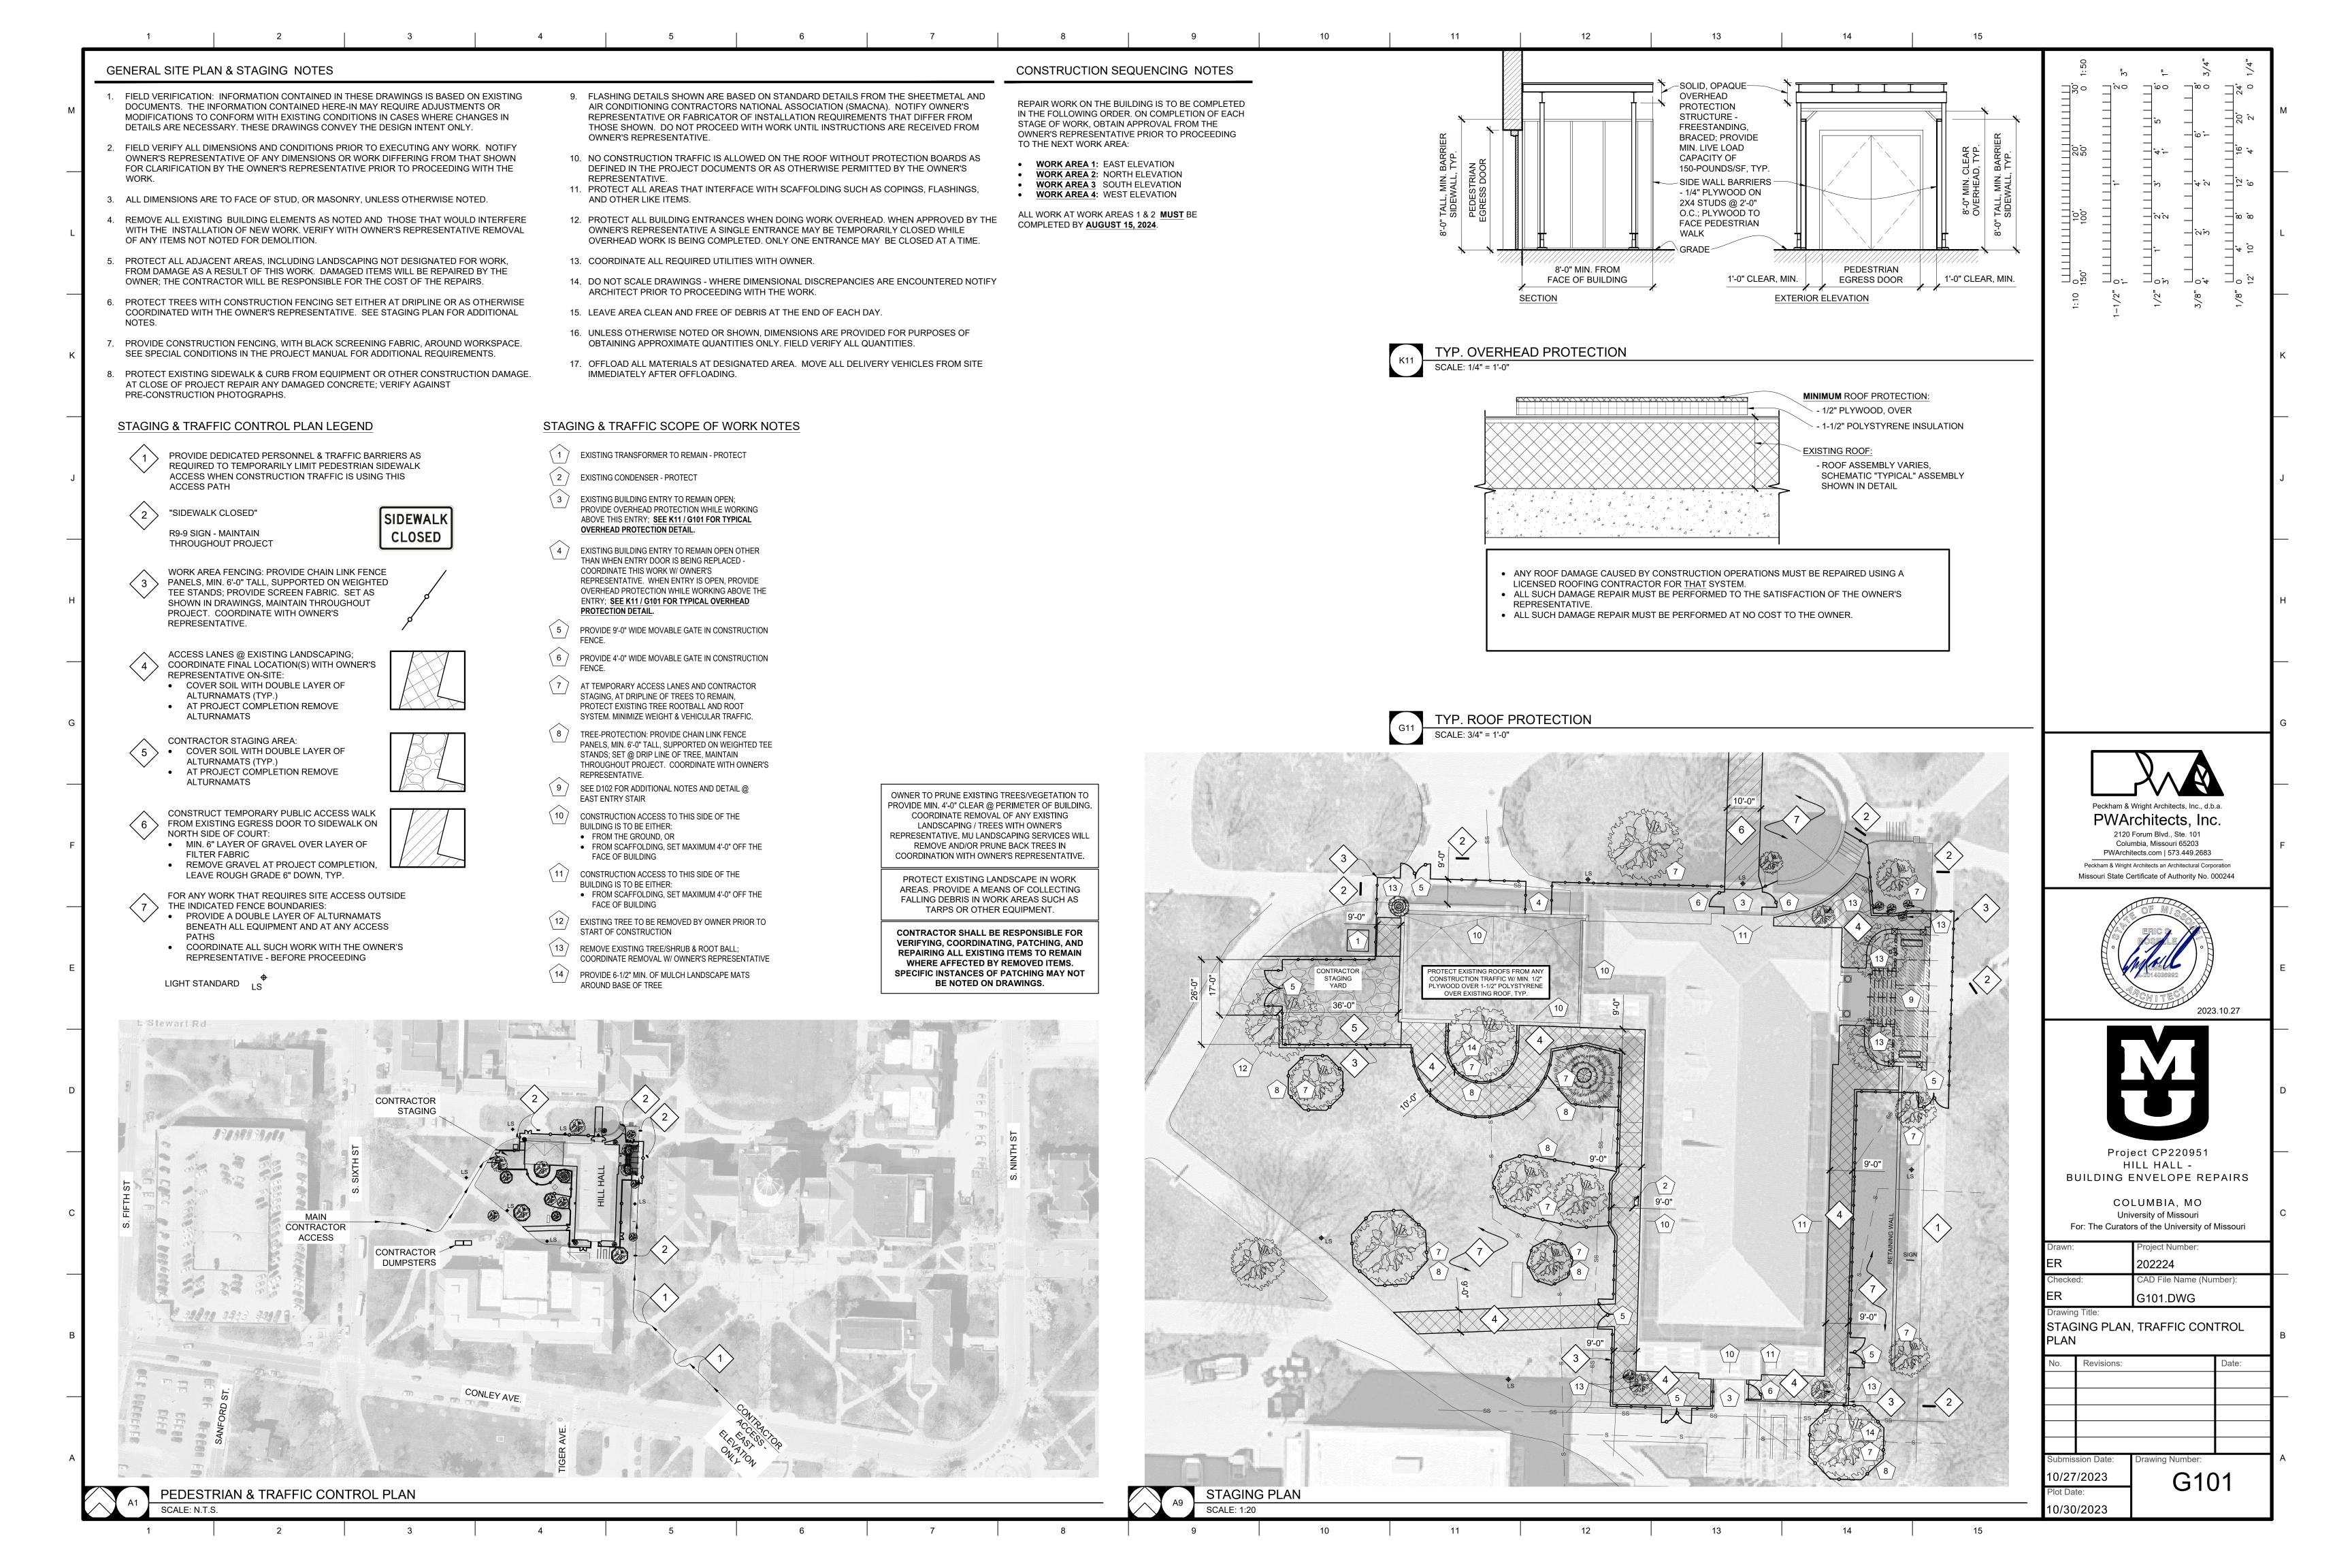

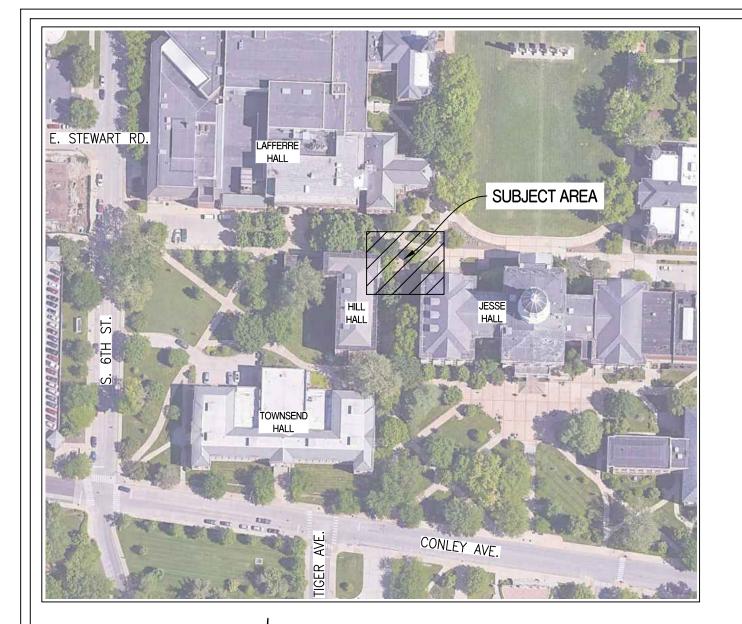

LOCATION MAP NOT TO SCALE

CONTROL POINT NO. 1 N = 1133203.72E = 1688917.32

ELEV. = 740.40

CONTROL POINT NO. 2 N = 1133268.37E = 1688982.72

ELEV. = 741.00

### LEGEND OF SYMBOLS:

E S	EXISTING SET		NICO.
0	SET 1/2" IRON PIPE OR 1/2" REBAR	LEGEND OF LI	NES:
	(UNLESS NOTED OTHERWISE)		EXISTING BOUNDARY LINE
	EXISTING SAN SEWER MANHOLE	X	EXISTING FENCE LINE
©	EXISTING STORM WATER MANHOLE	—— FO ——	EXISTING FIBER OPTIC
©	EXISTING STEAM TUNNEL ACCESS	$ \ T \$	EXISTING TELEPHONE LINE
<del></del>	EXISTING SIGNS	or	EXISTING OVERHEAD TELEPHONE
AC	EXISTING AIR CONDITIONER	UT	EXISTING UNDERGROUND TELEPHONE
Q	EXISTING FIRE HYDRANT	——— OETV ———	EXISTING OVERHEAD ELEC., & TV
$\bowtie$	EXISTING WATER VALVE	— — OETVT — —	EXISTING OVERHEAD ELEC., TV, & TELE.
W	EXISTING WATER METER		EXISTING UNDERGROUND ELECTRIC
$\bowtie$	EXISTING IRRIGATION VALVE	—— OE ——	EXISTING OVERHEAD ELECTRIC
©	EXISTING WATER PIT ACCESS	—— G ——	EXISTING GAS LINE
ςγ ⋈	EXISTING GAS VALVE	w	EXISTING WATER LINE
©	EXISTING GAS METER	——————————————————————————————————————	EXISTING CHILLED WATER LINE
	EXISTING TELEPHONE PEDESTAL	s	EXISTING SANITARY LINE
$\bigcirc$	EXISTING TELE. VAULT ACCESS		EXISTING STEAM TUNNEL
Ø	EXISTING POWER POLE	······818·····	EXISTING MINOR CONTOUR
¤	EXISTING LIGHT POLE	— — — <del>-</del> 820— — —	EXISTING MAJOR CONTOUR
$\rightarrow$	EXISTING GUY WIRE	~~~~	EXISTING TREELINE
ET	EXISTING ELECTRICAL TRANSFORMER	000	FLOW LINE OF DITCH
E	EXISTING ELECTRIC METER	TV	EXISTING TELEVISION CABLE
EM)	EXISTING ELEC. VAULT ACCESS	— — W? — —	EXISTING WATER
EP	EXISTING ELECTRIC PULLBOX	— W? — —	(DRAWN PER MAP PROVIDED)
FO	EXISTING FIBEROPTIC PEDESTAL	IIT?	EXISTING UNDERGROUND TELEPHONE (DRAWN PER MAP PROVIDED)
(RD)	EXISTING ROOF DRAIN		
TV	EXISTING TV PEDESTAL	—— UE? ——	EXISTING UNDERGROUND ELECTRIC (DRAWN PER MAP PROVIDED)
	EXISTING GRAVEL		,
4 4 4 4	EXISTING CONCRETE	—— G? ——	EXISTING GAS LINE

# CP222891 - HILL HALL - REPLACE AUH & FIRE ALARM SYSTEM

MU CAMPUS SECTION 13, TOWNSHIP 48 NORTH, RANGE 13 WEST COLUMBIA, BOONE COUNTY, MISSOURI

EXISTING ASPHALT


ATG

EXISTING BRICK

CORPORATE NUMBER: 2000151304			
DATE:	SCALE:		
7/31/2023	1" = 10'		

230265


ENGINEERING CONSULTANTS 1000 W. Nifong Blvd., Building 1 Columbia, Missouri 65203 (573) 447-0292 www.crockettengineering.com

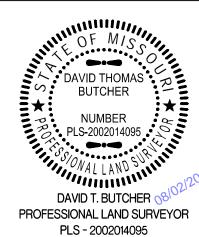

(DRAWN PER MAP PROVIDED)

(DRAWN PER MAP PROVIDED)

EXISTING SANITARY LINE

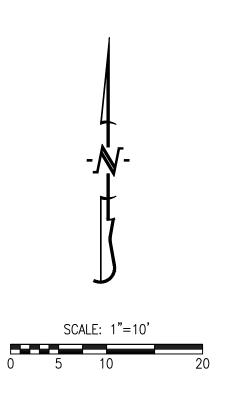

# **UTILITY COMPANIES:**

# LOCATES:

MISSOURI ONE CALL INC. 1022 B NORTHEAST DRIVE JEFFERSON CITY, MO 6510 1-800-344-7483 1-800-344-7483

# TELEPHONE:

UNIVERSITY OF MISSOURI, DIVISION OF I.T. 615 LOCUST ST. COLUMBIA, MO 65211 573-882-5000

# FIBER/CABLE TELEVISION:

CHARTER COMMUNICATIONS 1510 CHARTER BOONE INDUSTRIAL BOULEVARD COLUMBIA, MO 65202 573-875-8875

### WATER/ELECTRIC:


ENERGY MANAGEMENT 417 S. 5TH ST. COLUMBIA, MO 65211 573-882-3094


## STORM/SANITARY SEWER & SECONDARY ELECTRIC:


UNIVERSITY CAMPUS FACILITY OPERATIONS 180 GENERAL SERVICES BUILDING COLUMBIA, MO 65211 573-882-8211


### NATURAL GAS:


AMEREN MISSOURI 2001 MAGUIRE BLVD. COLUMBIA, MO 65201 573-876-3030

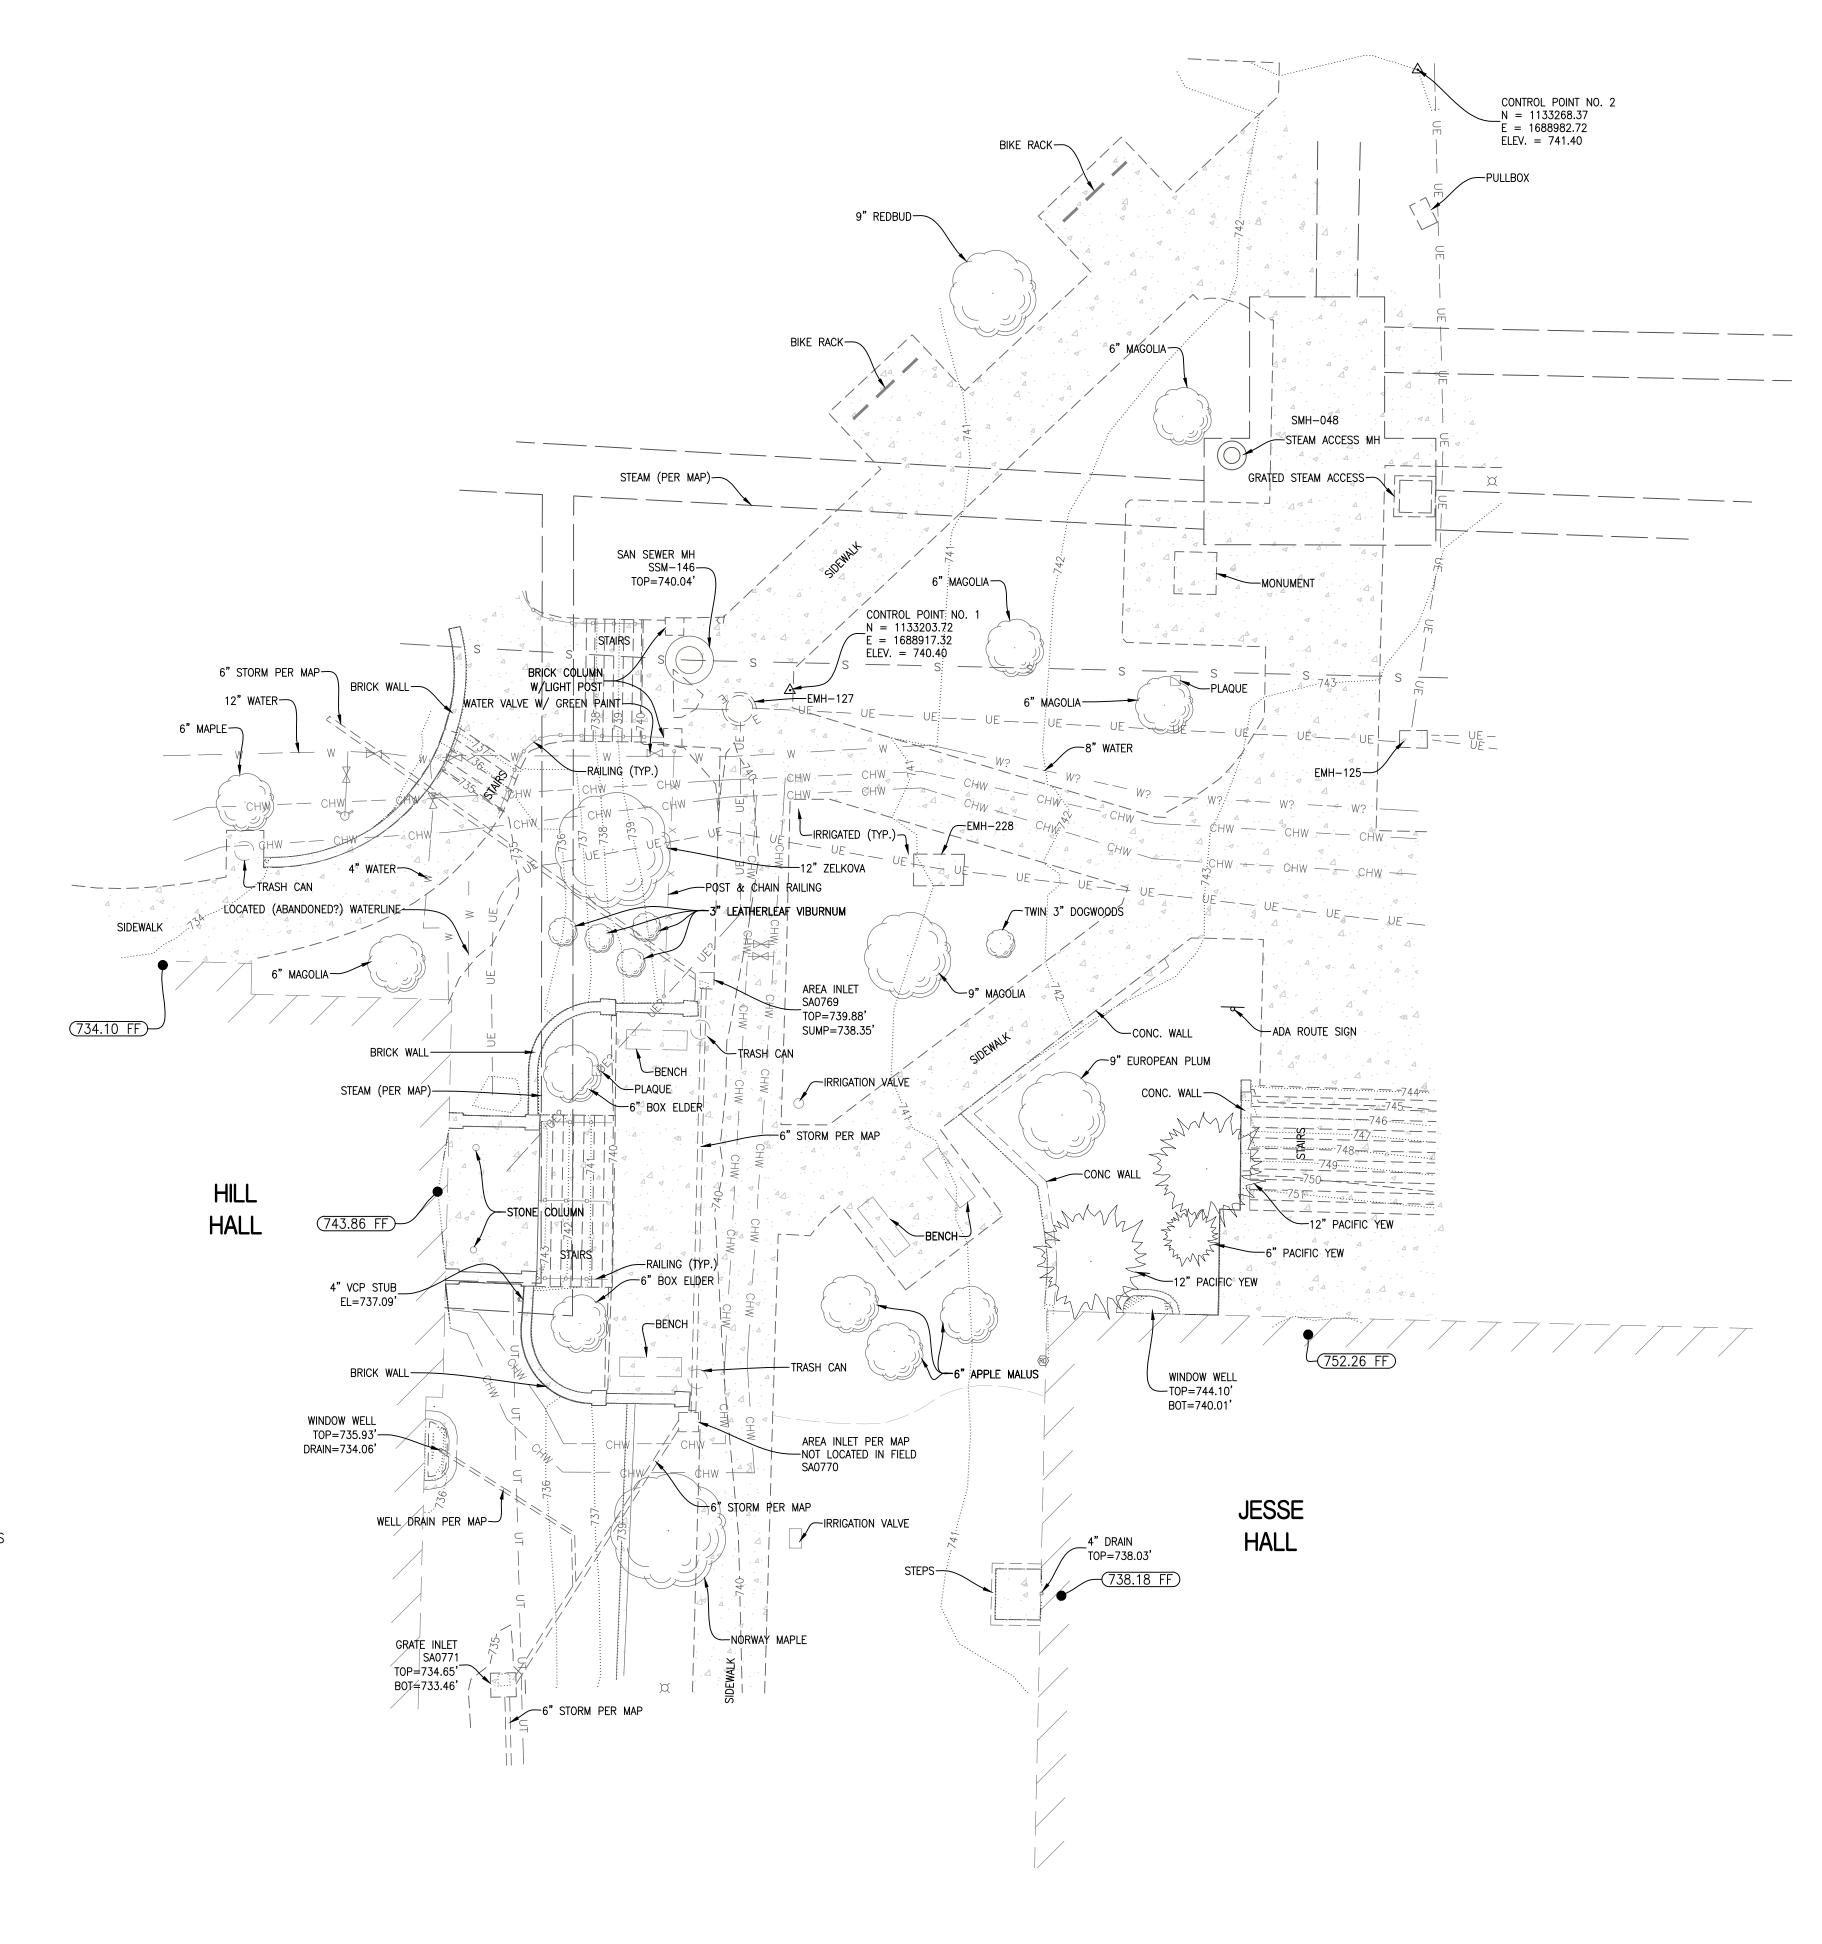


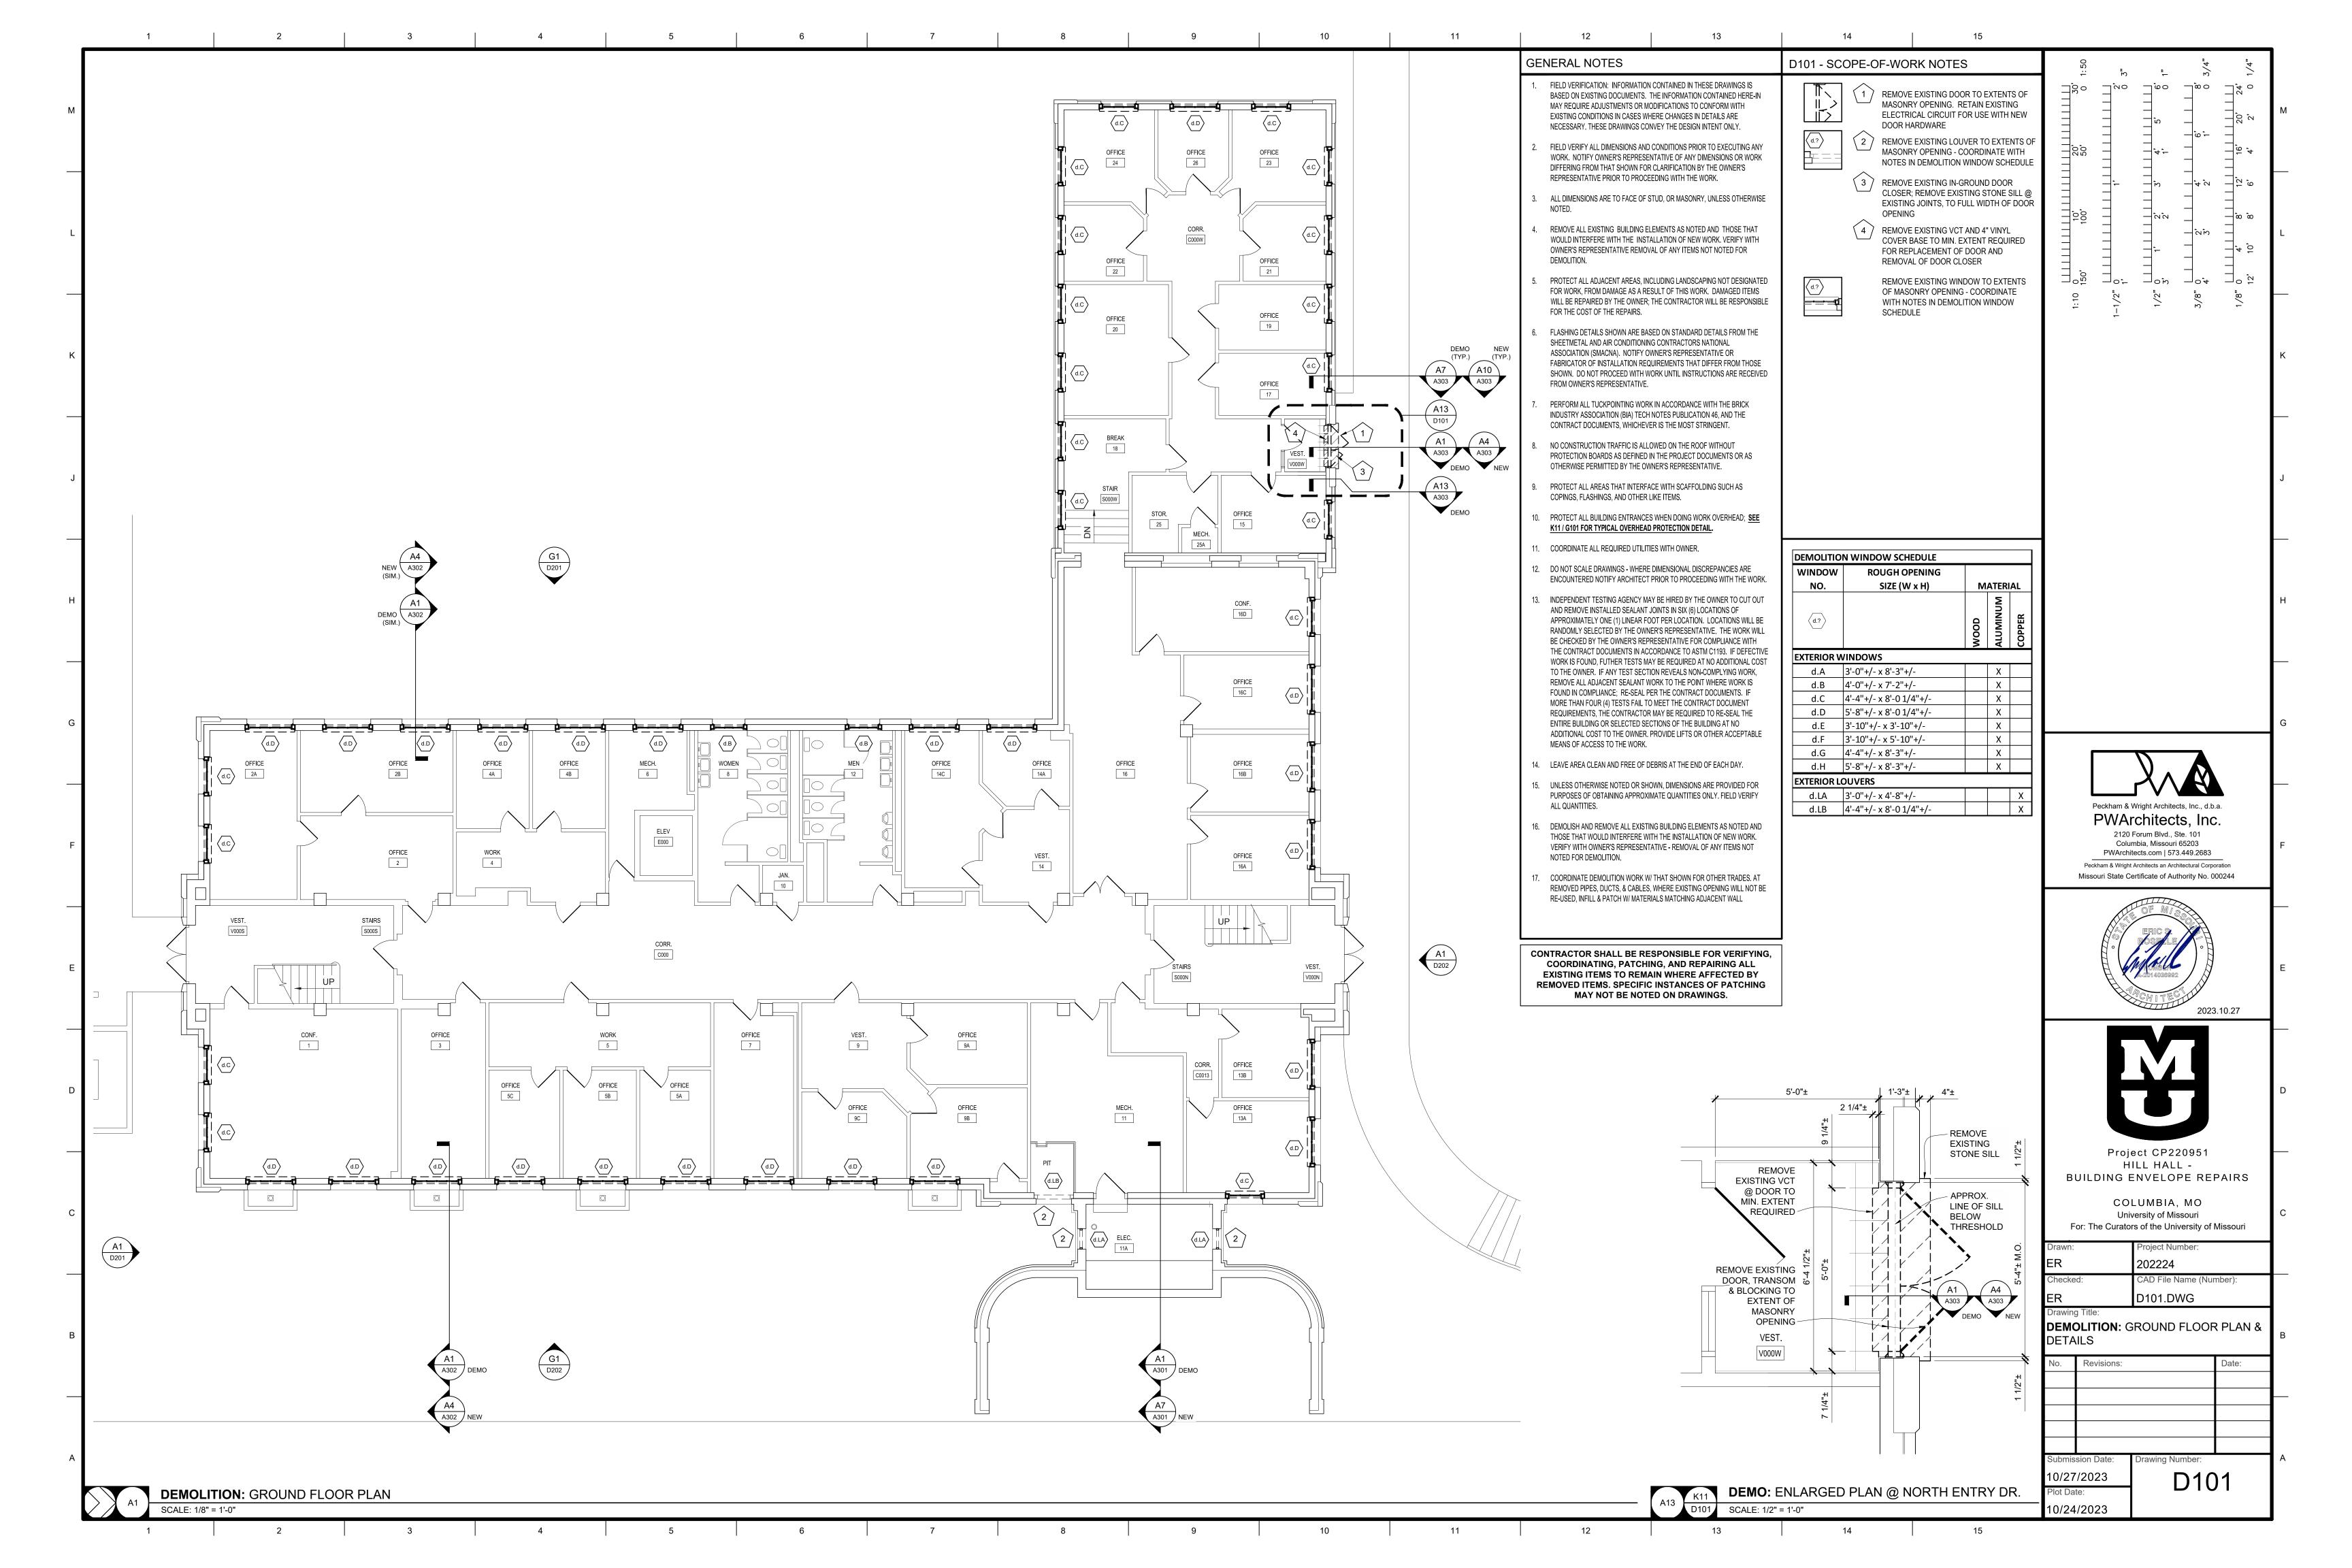


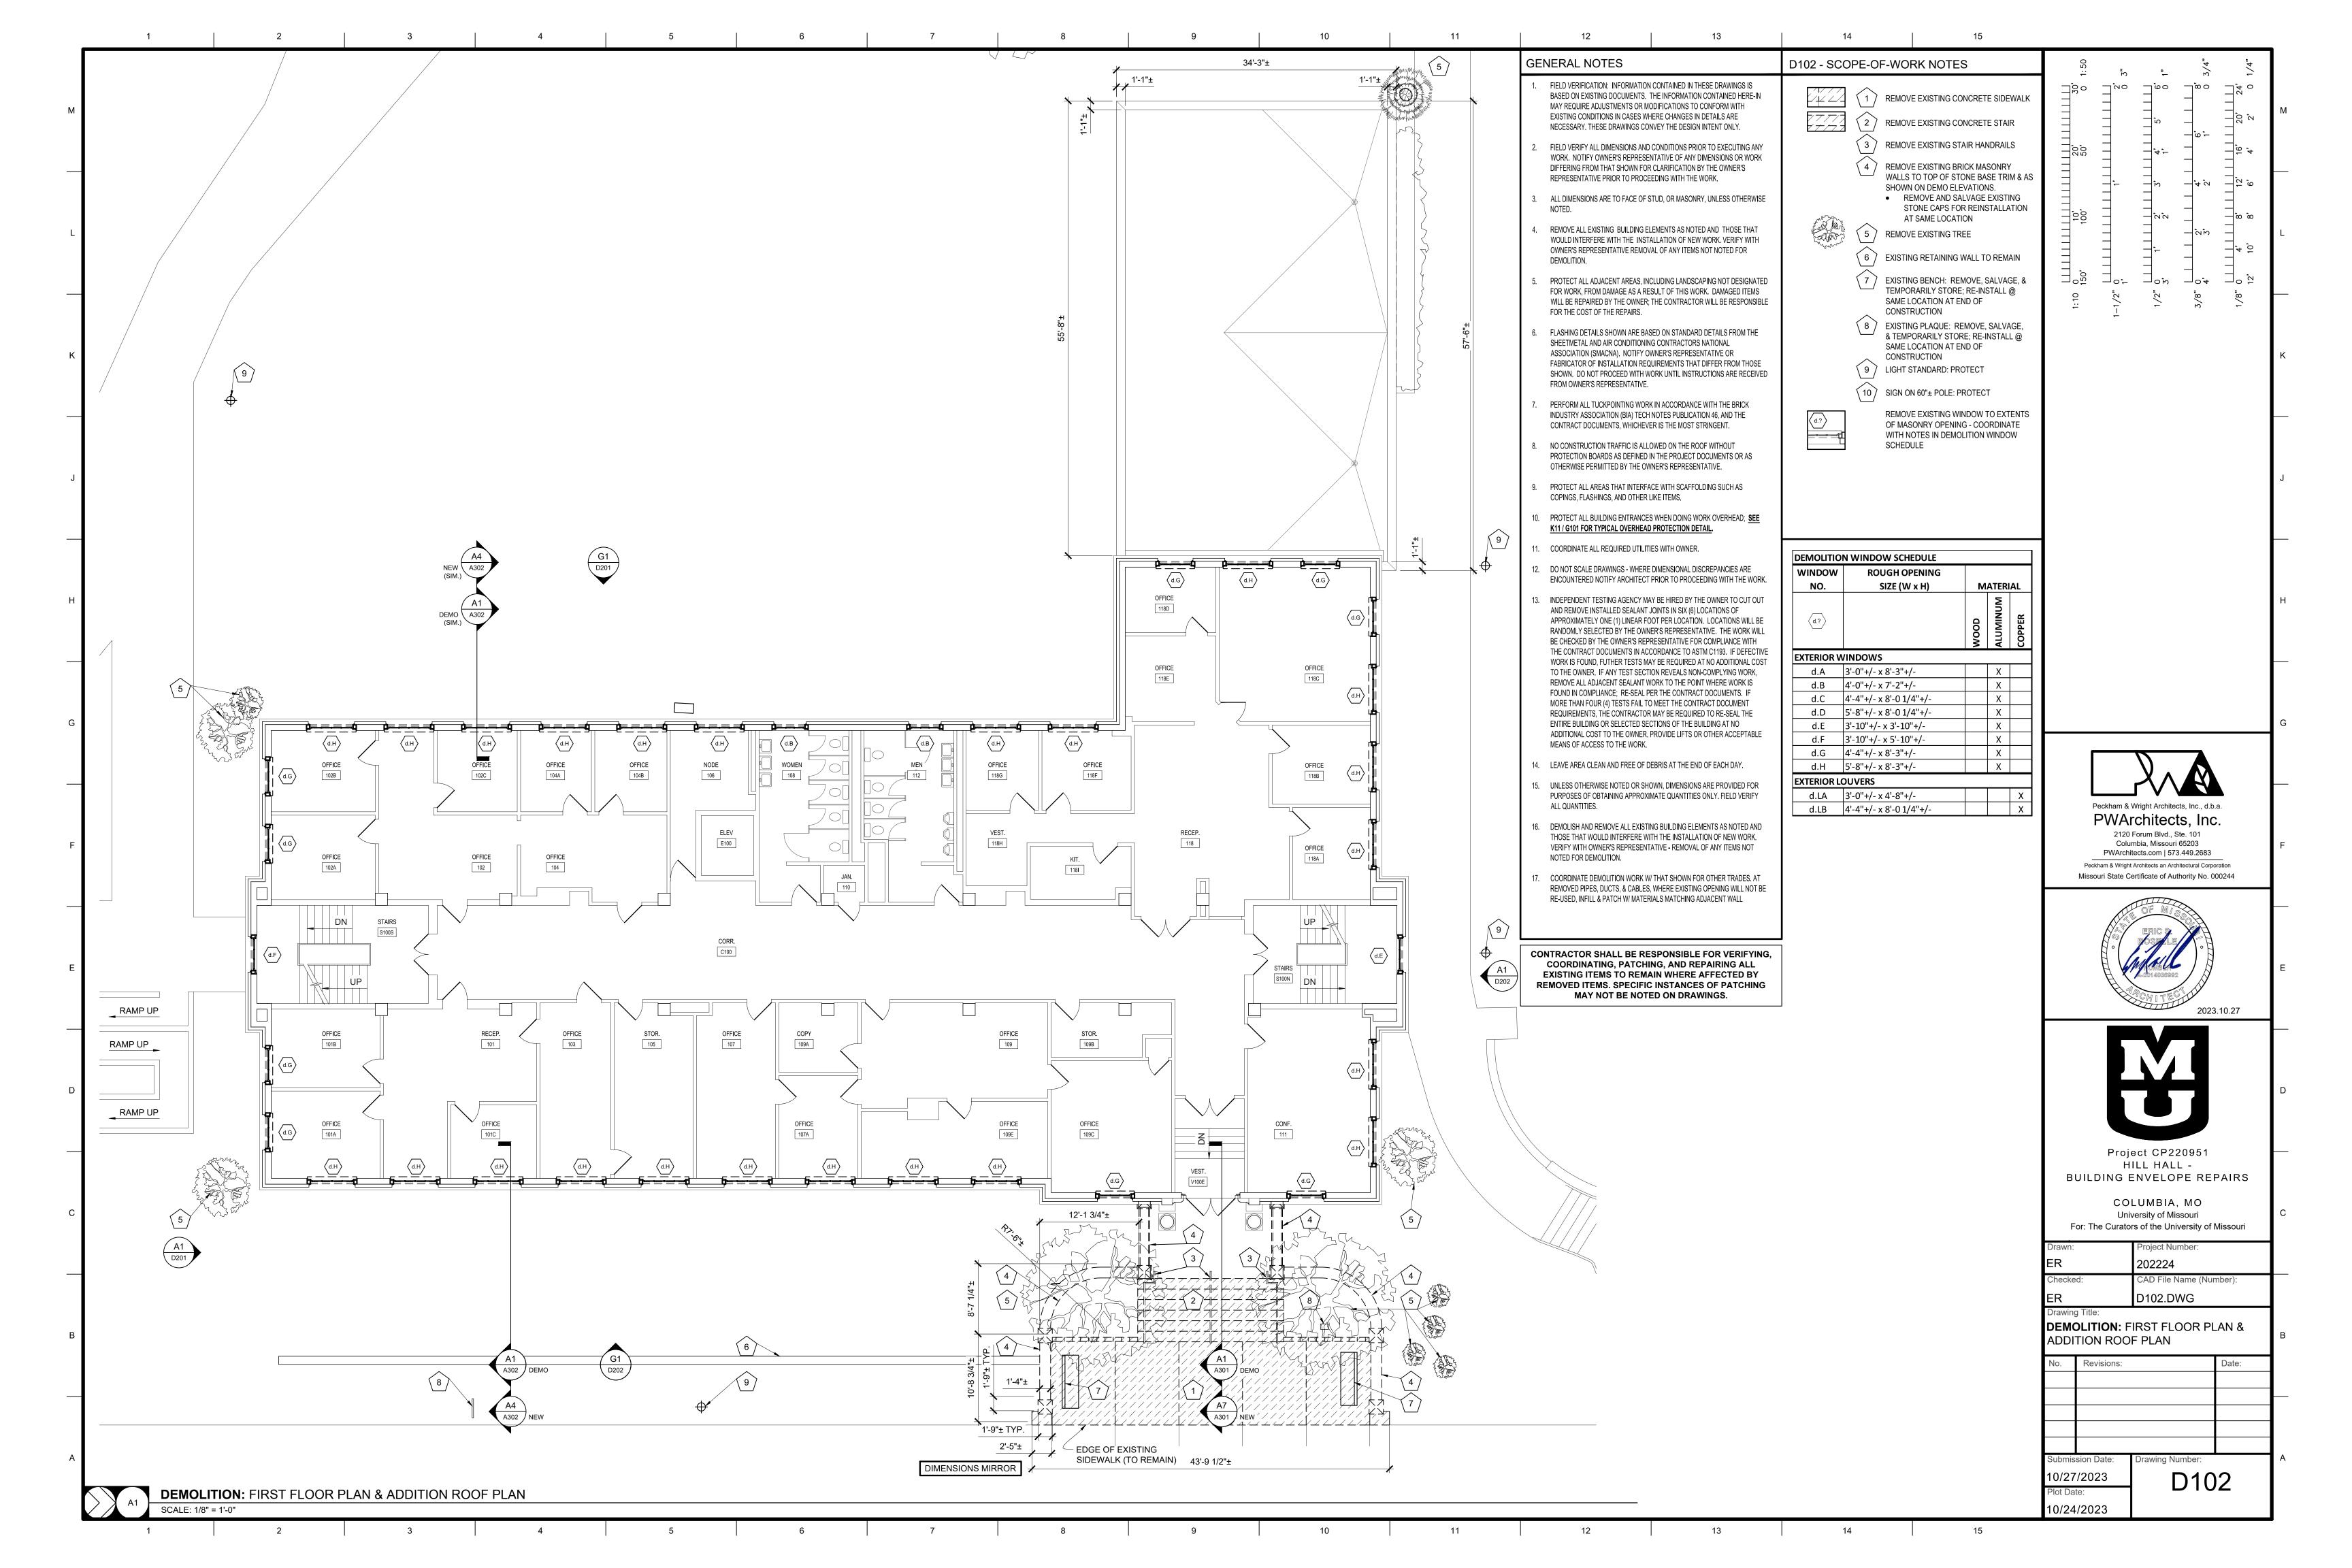


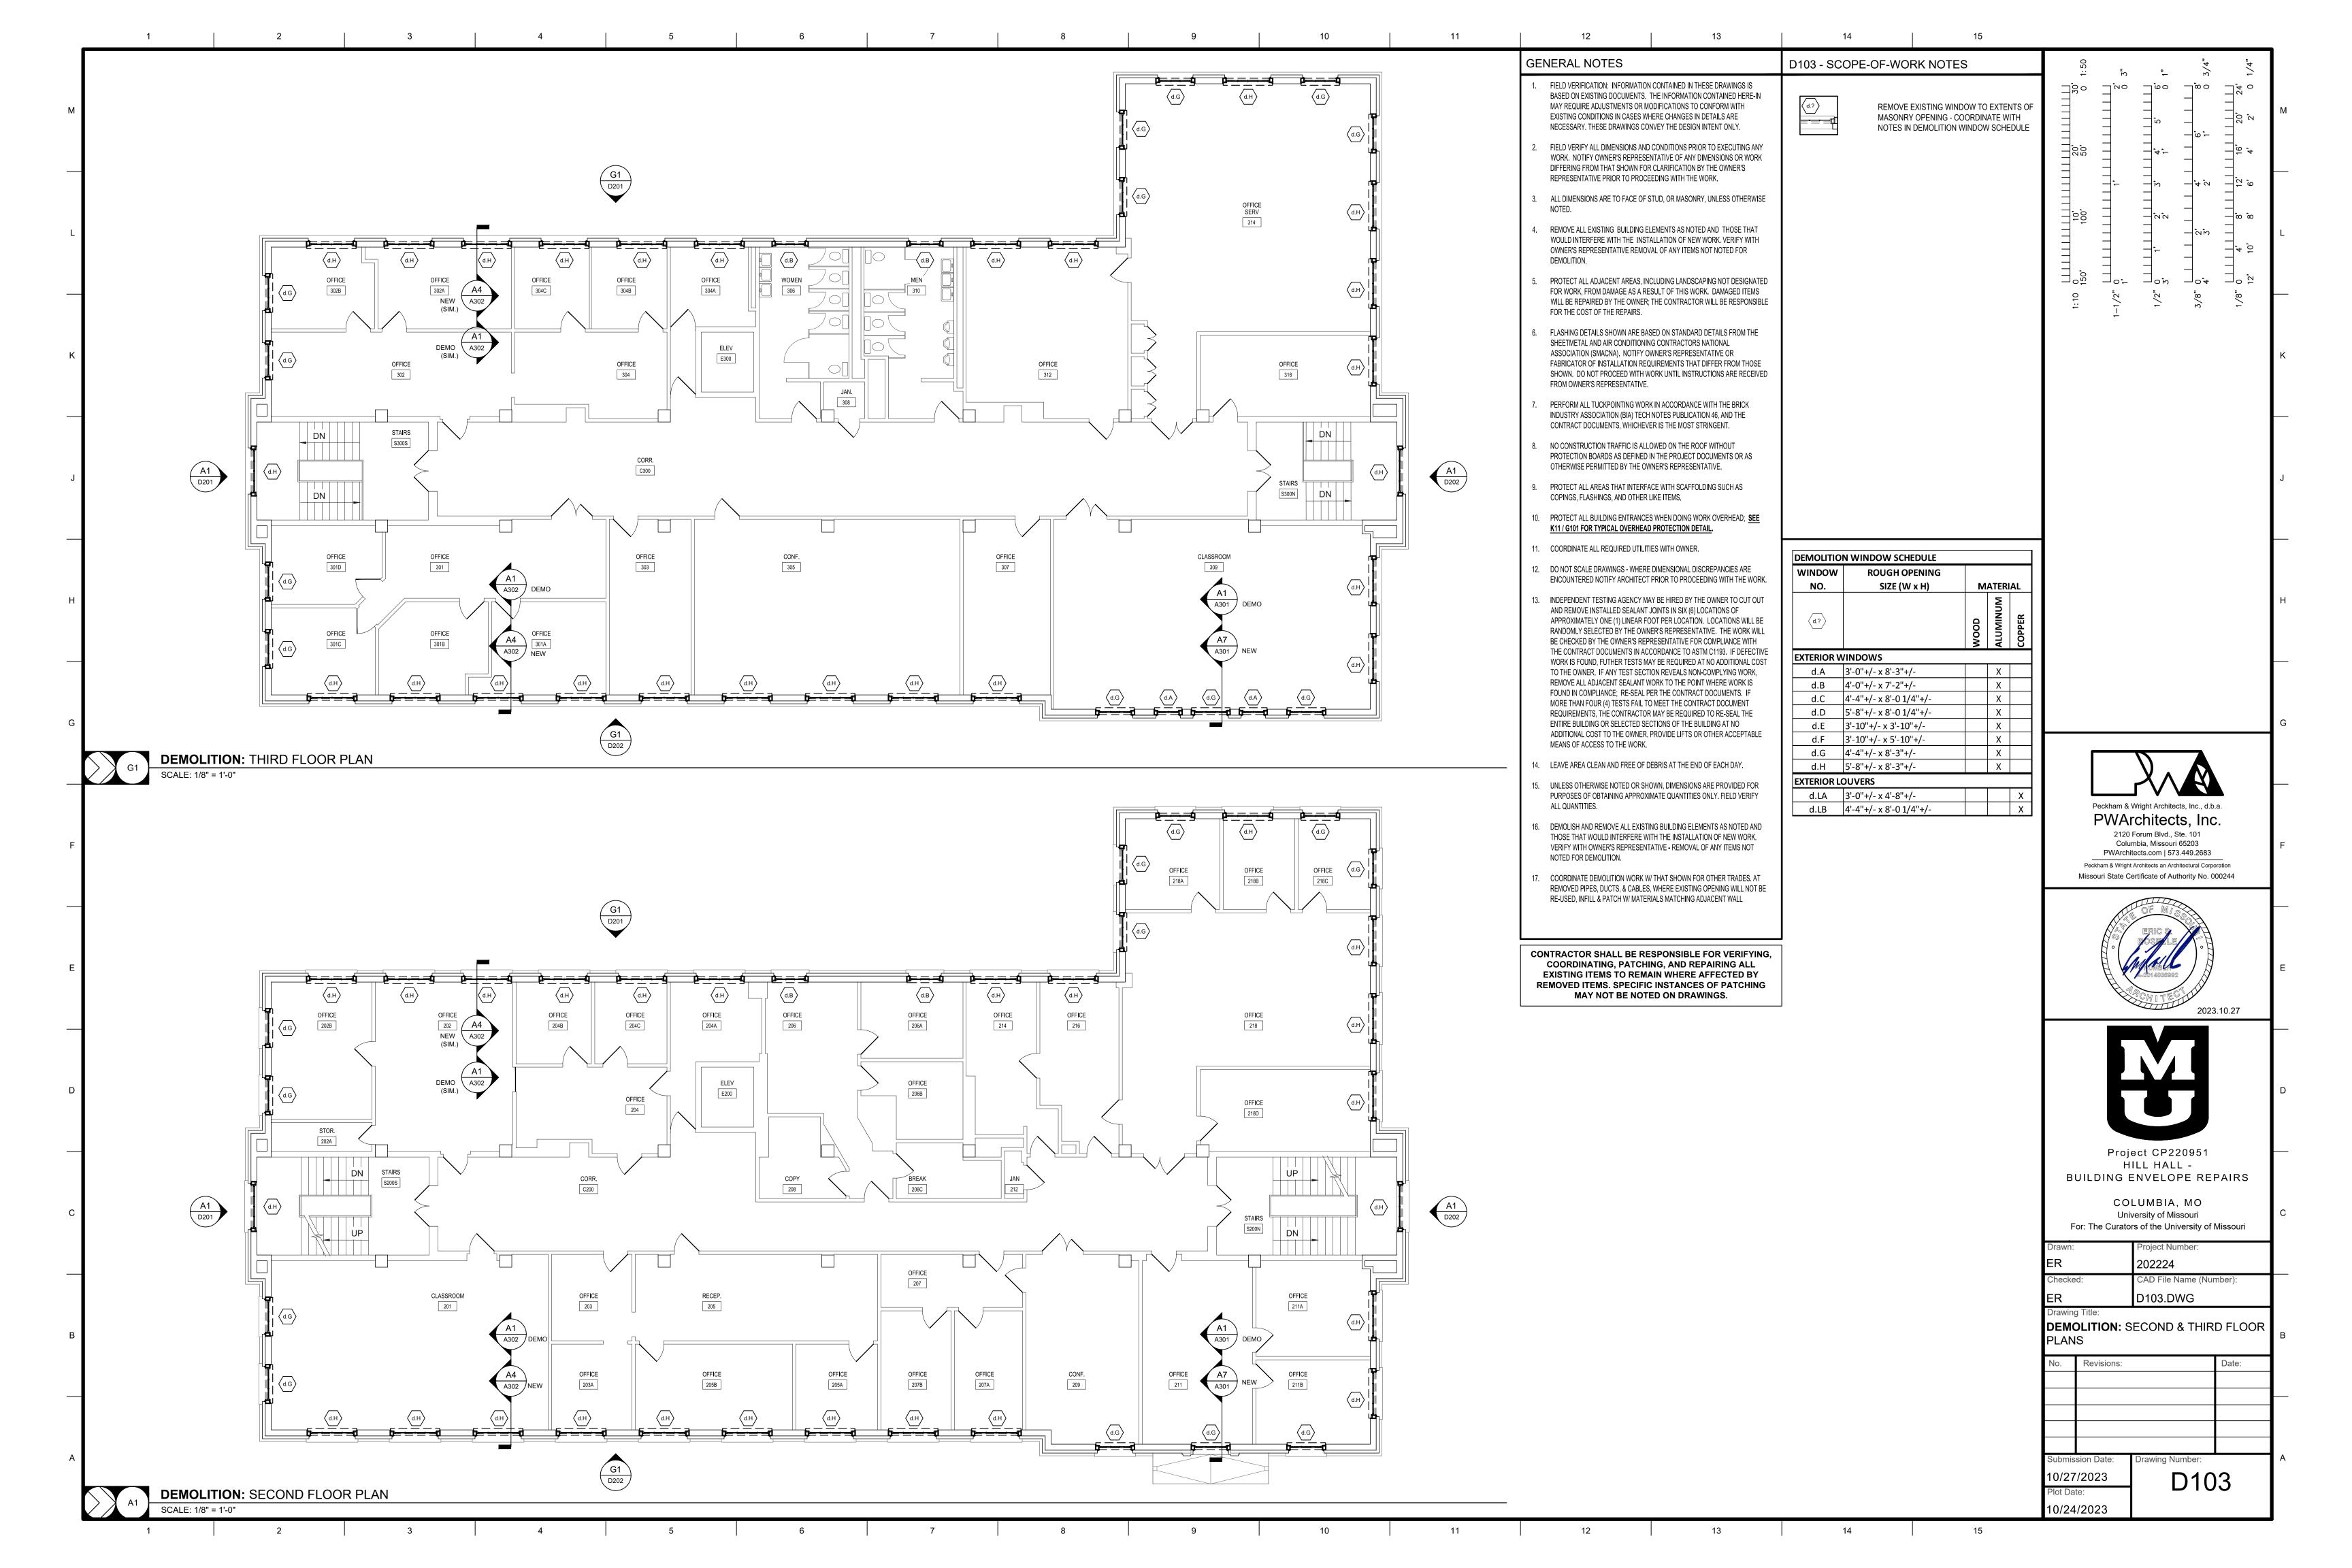


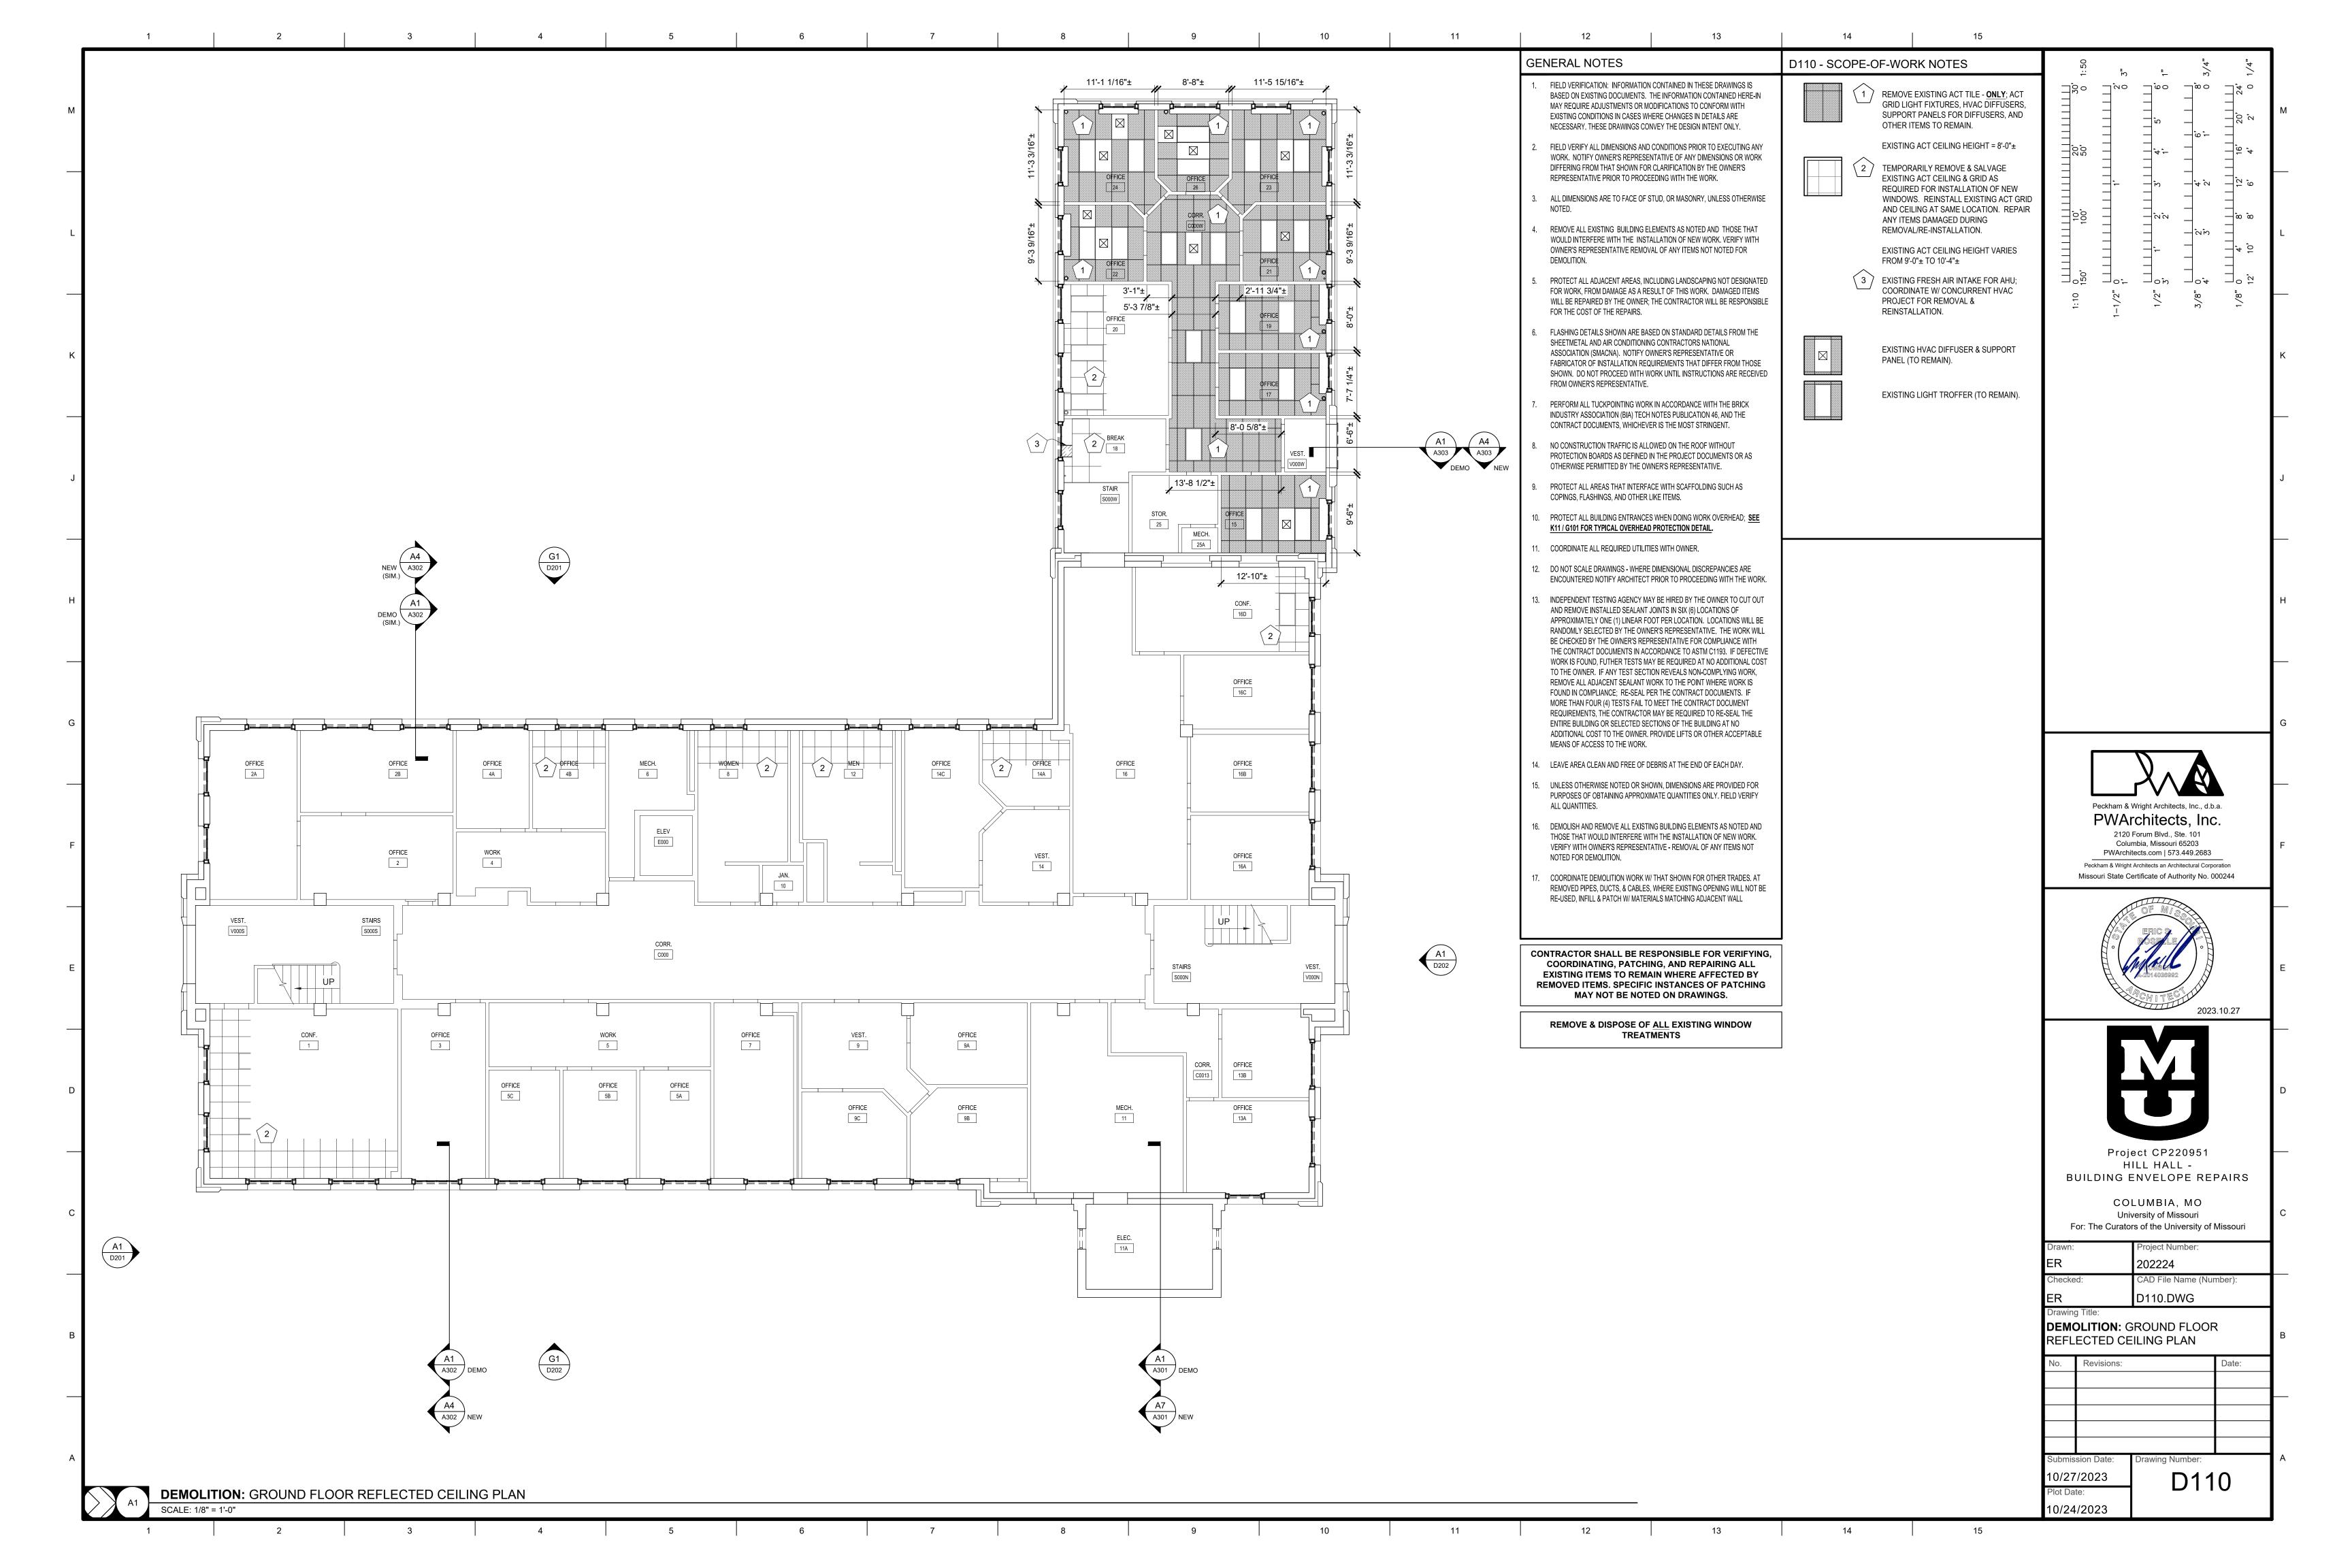


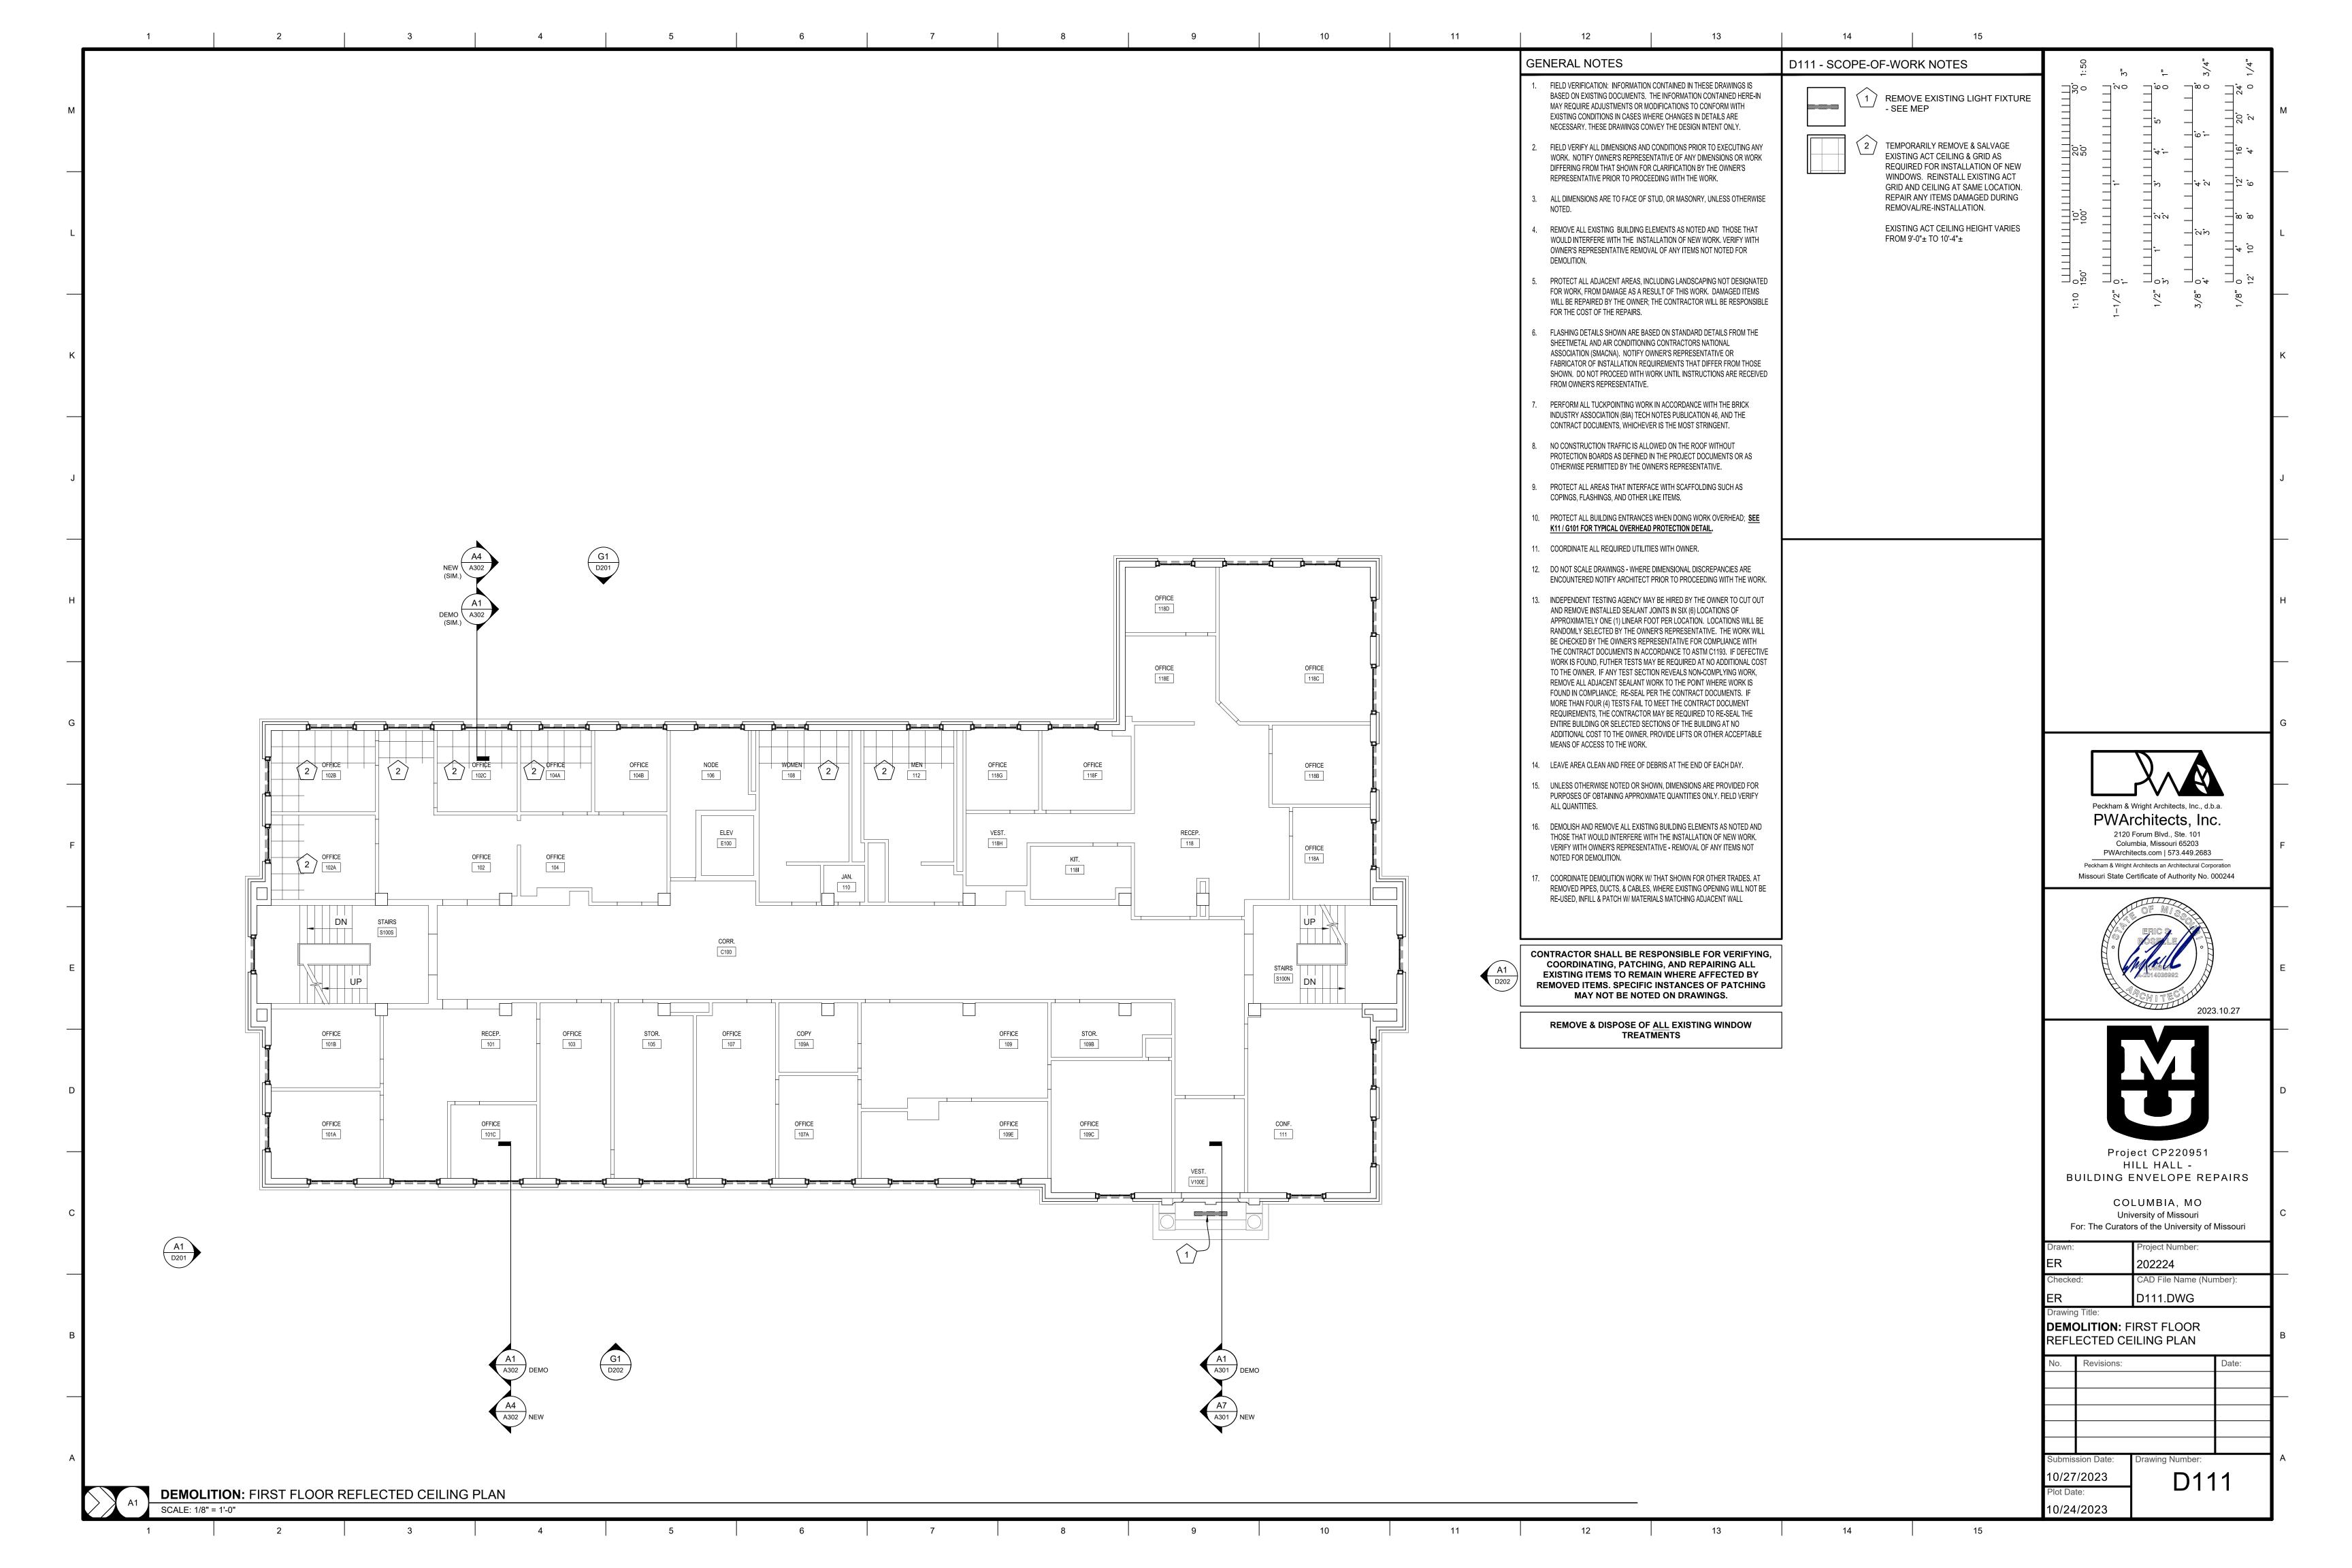


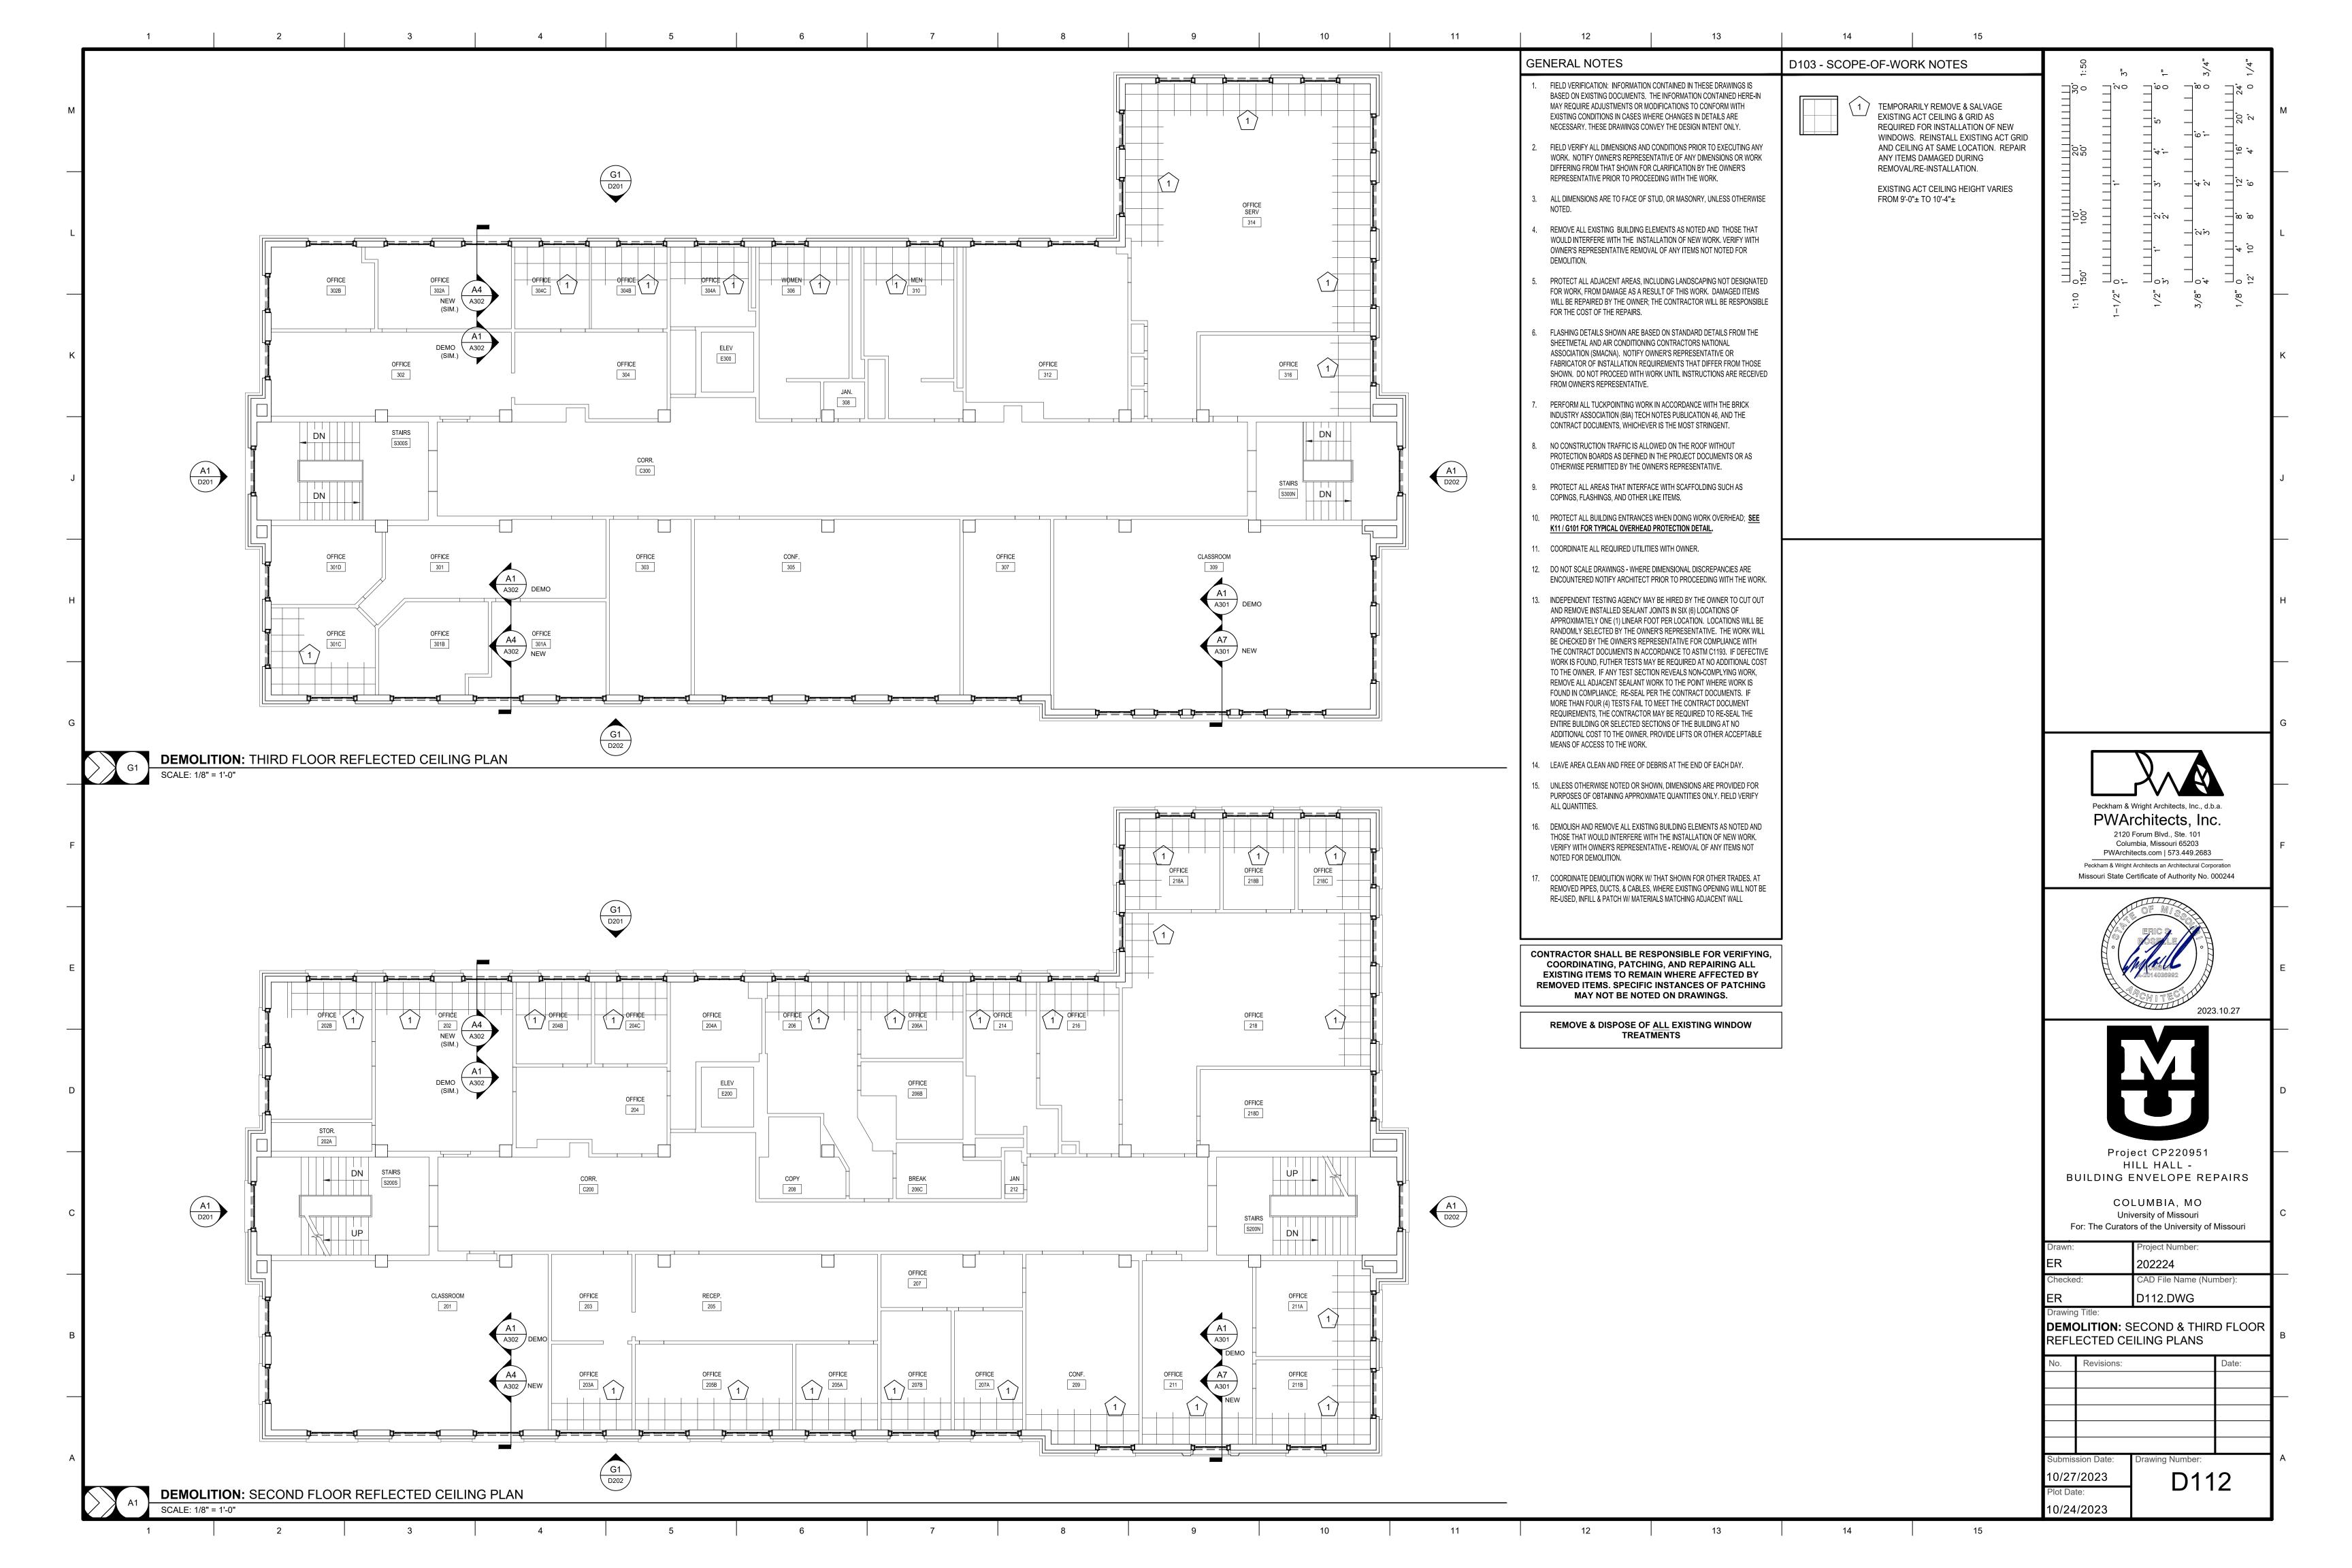


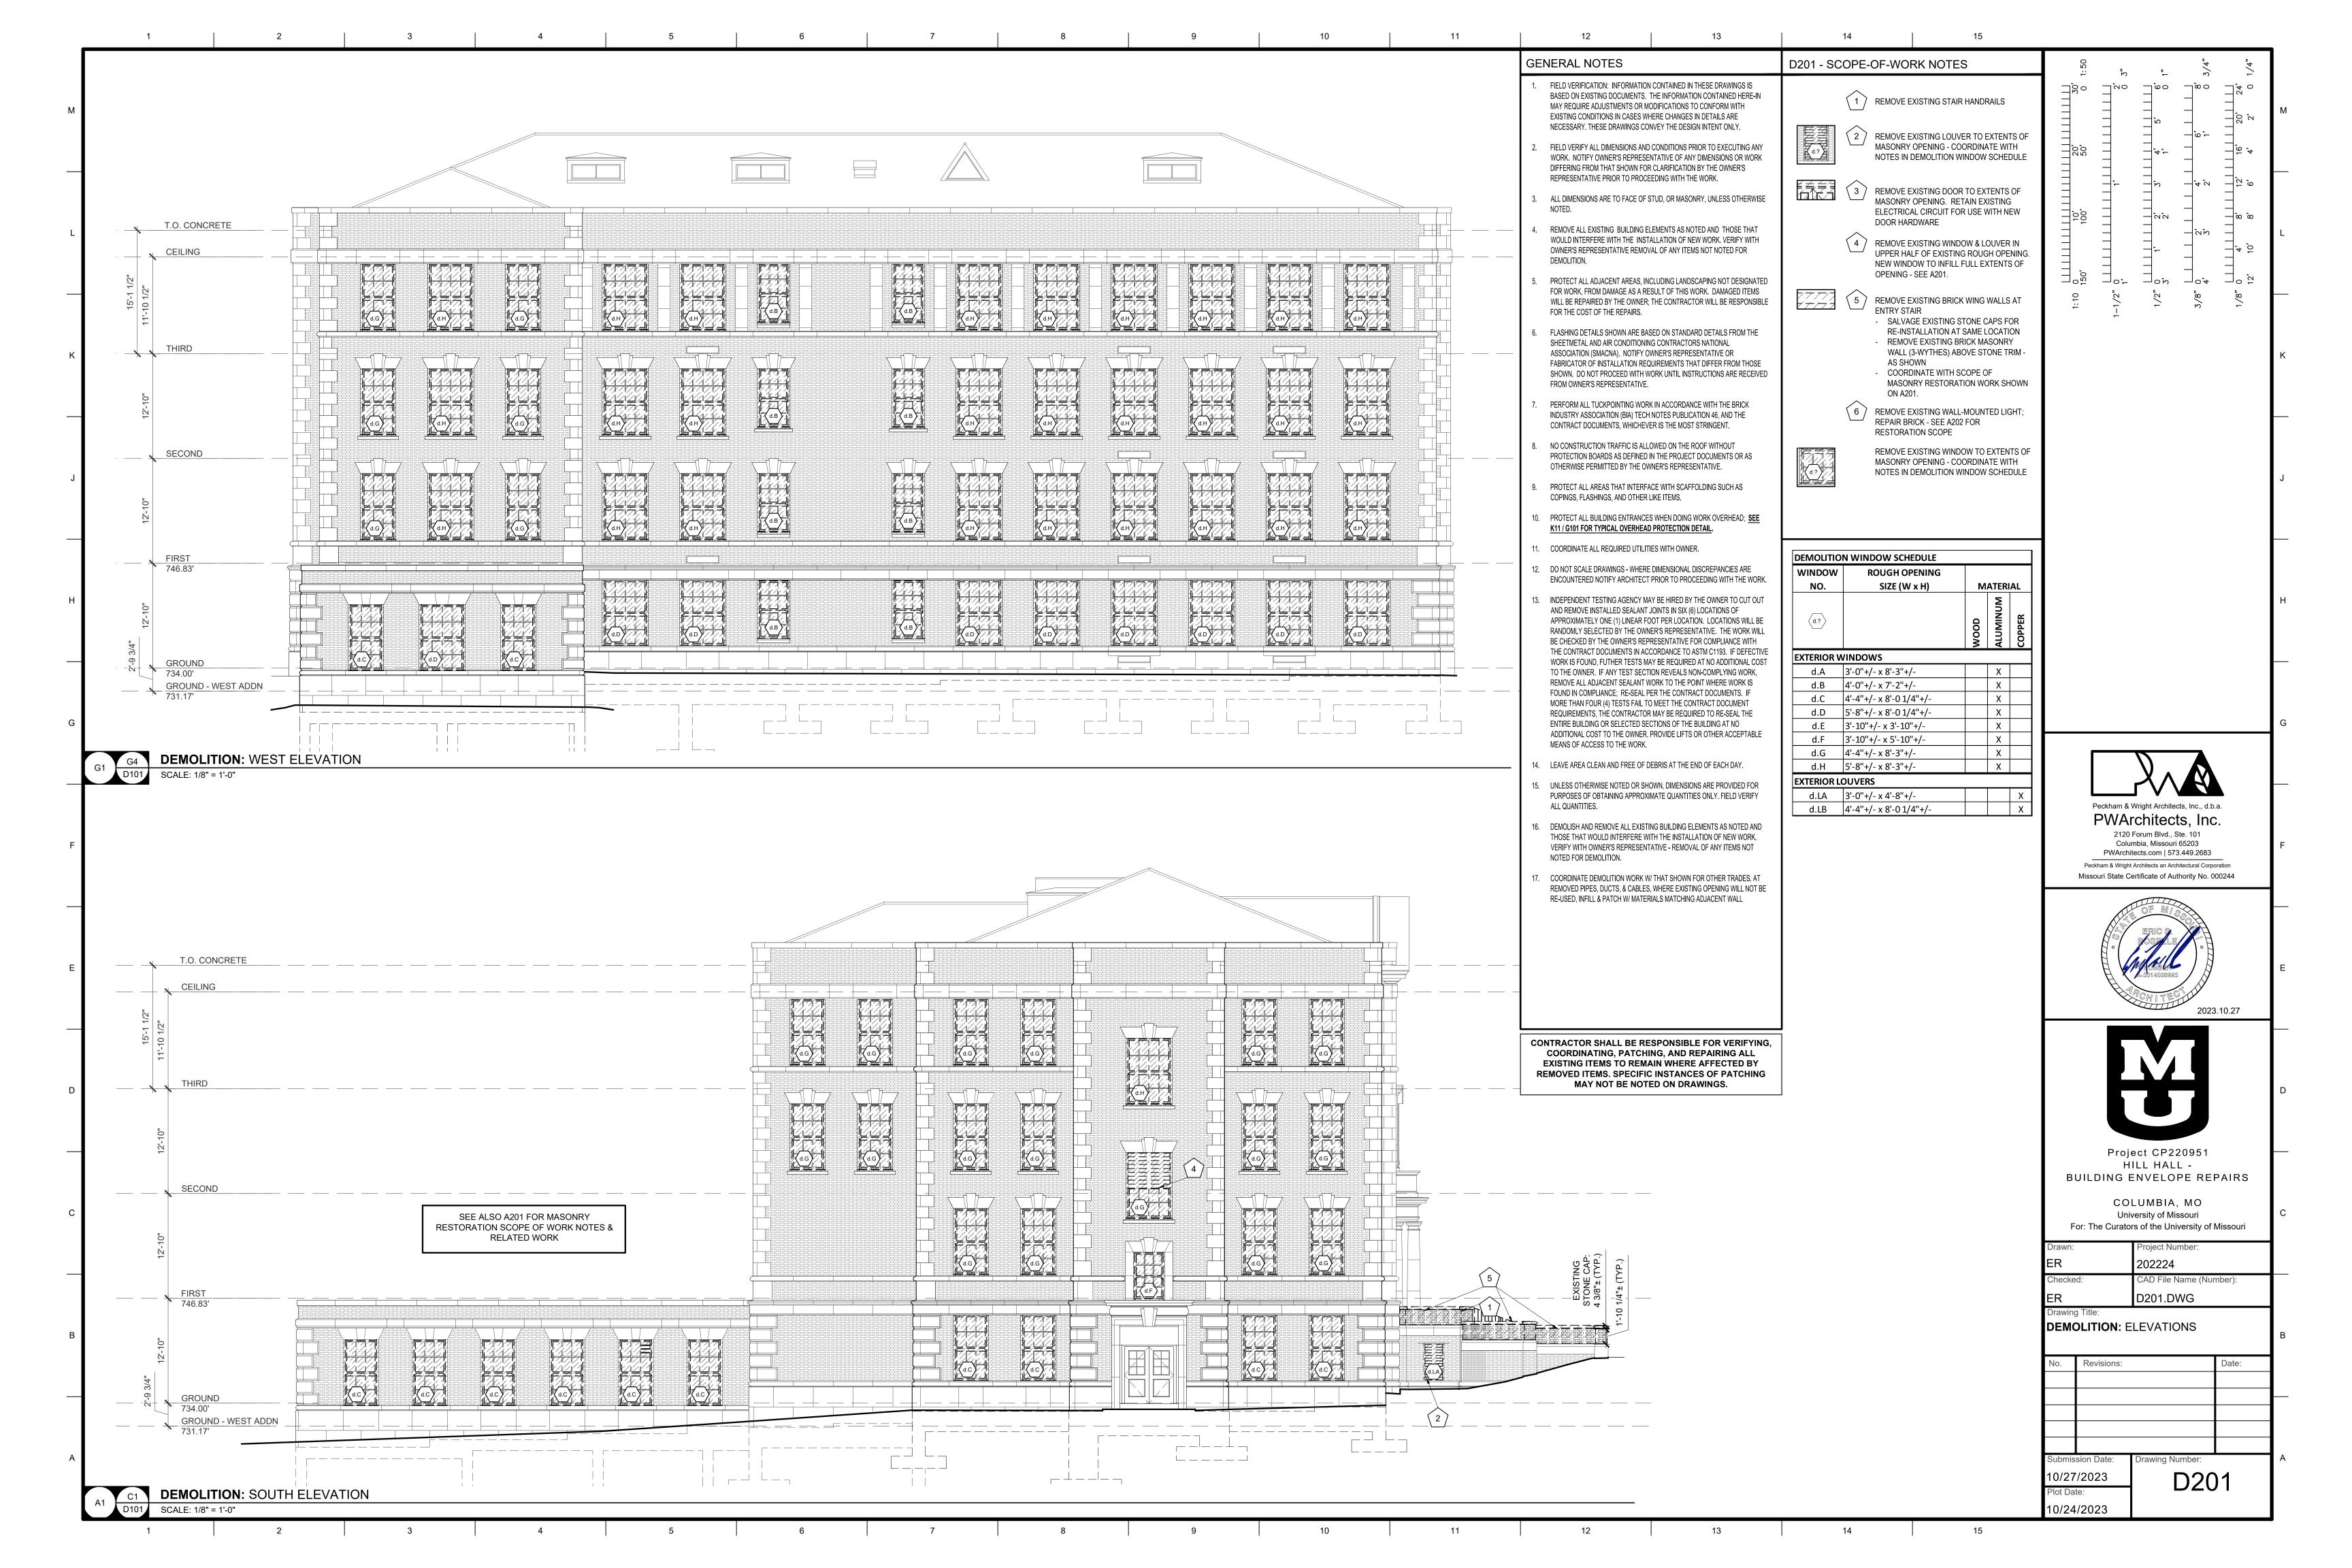


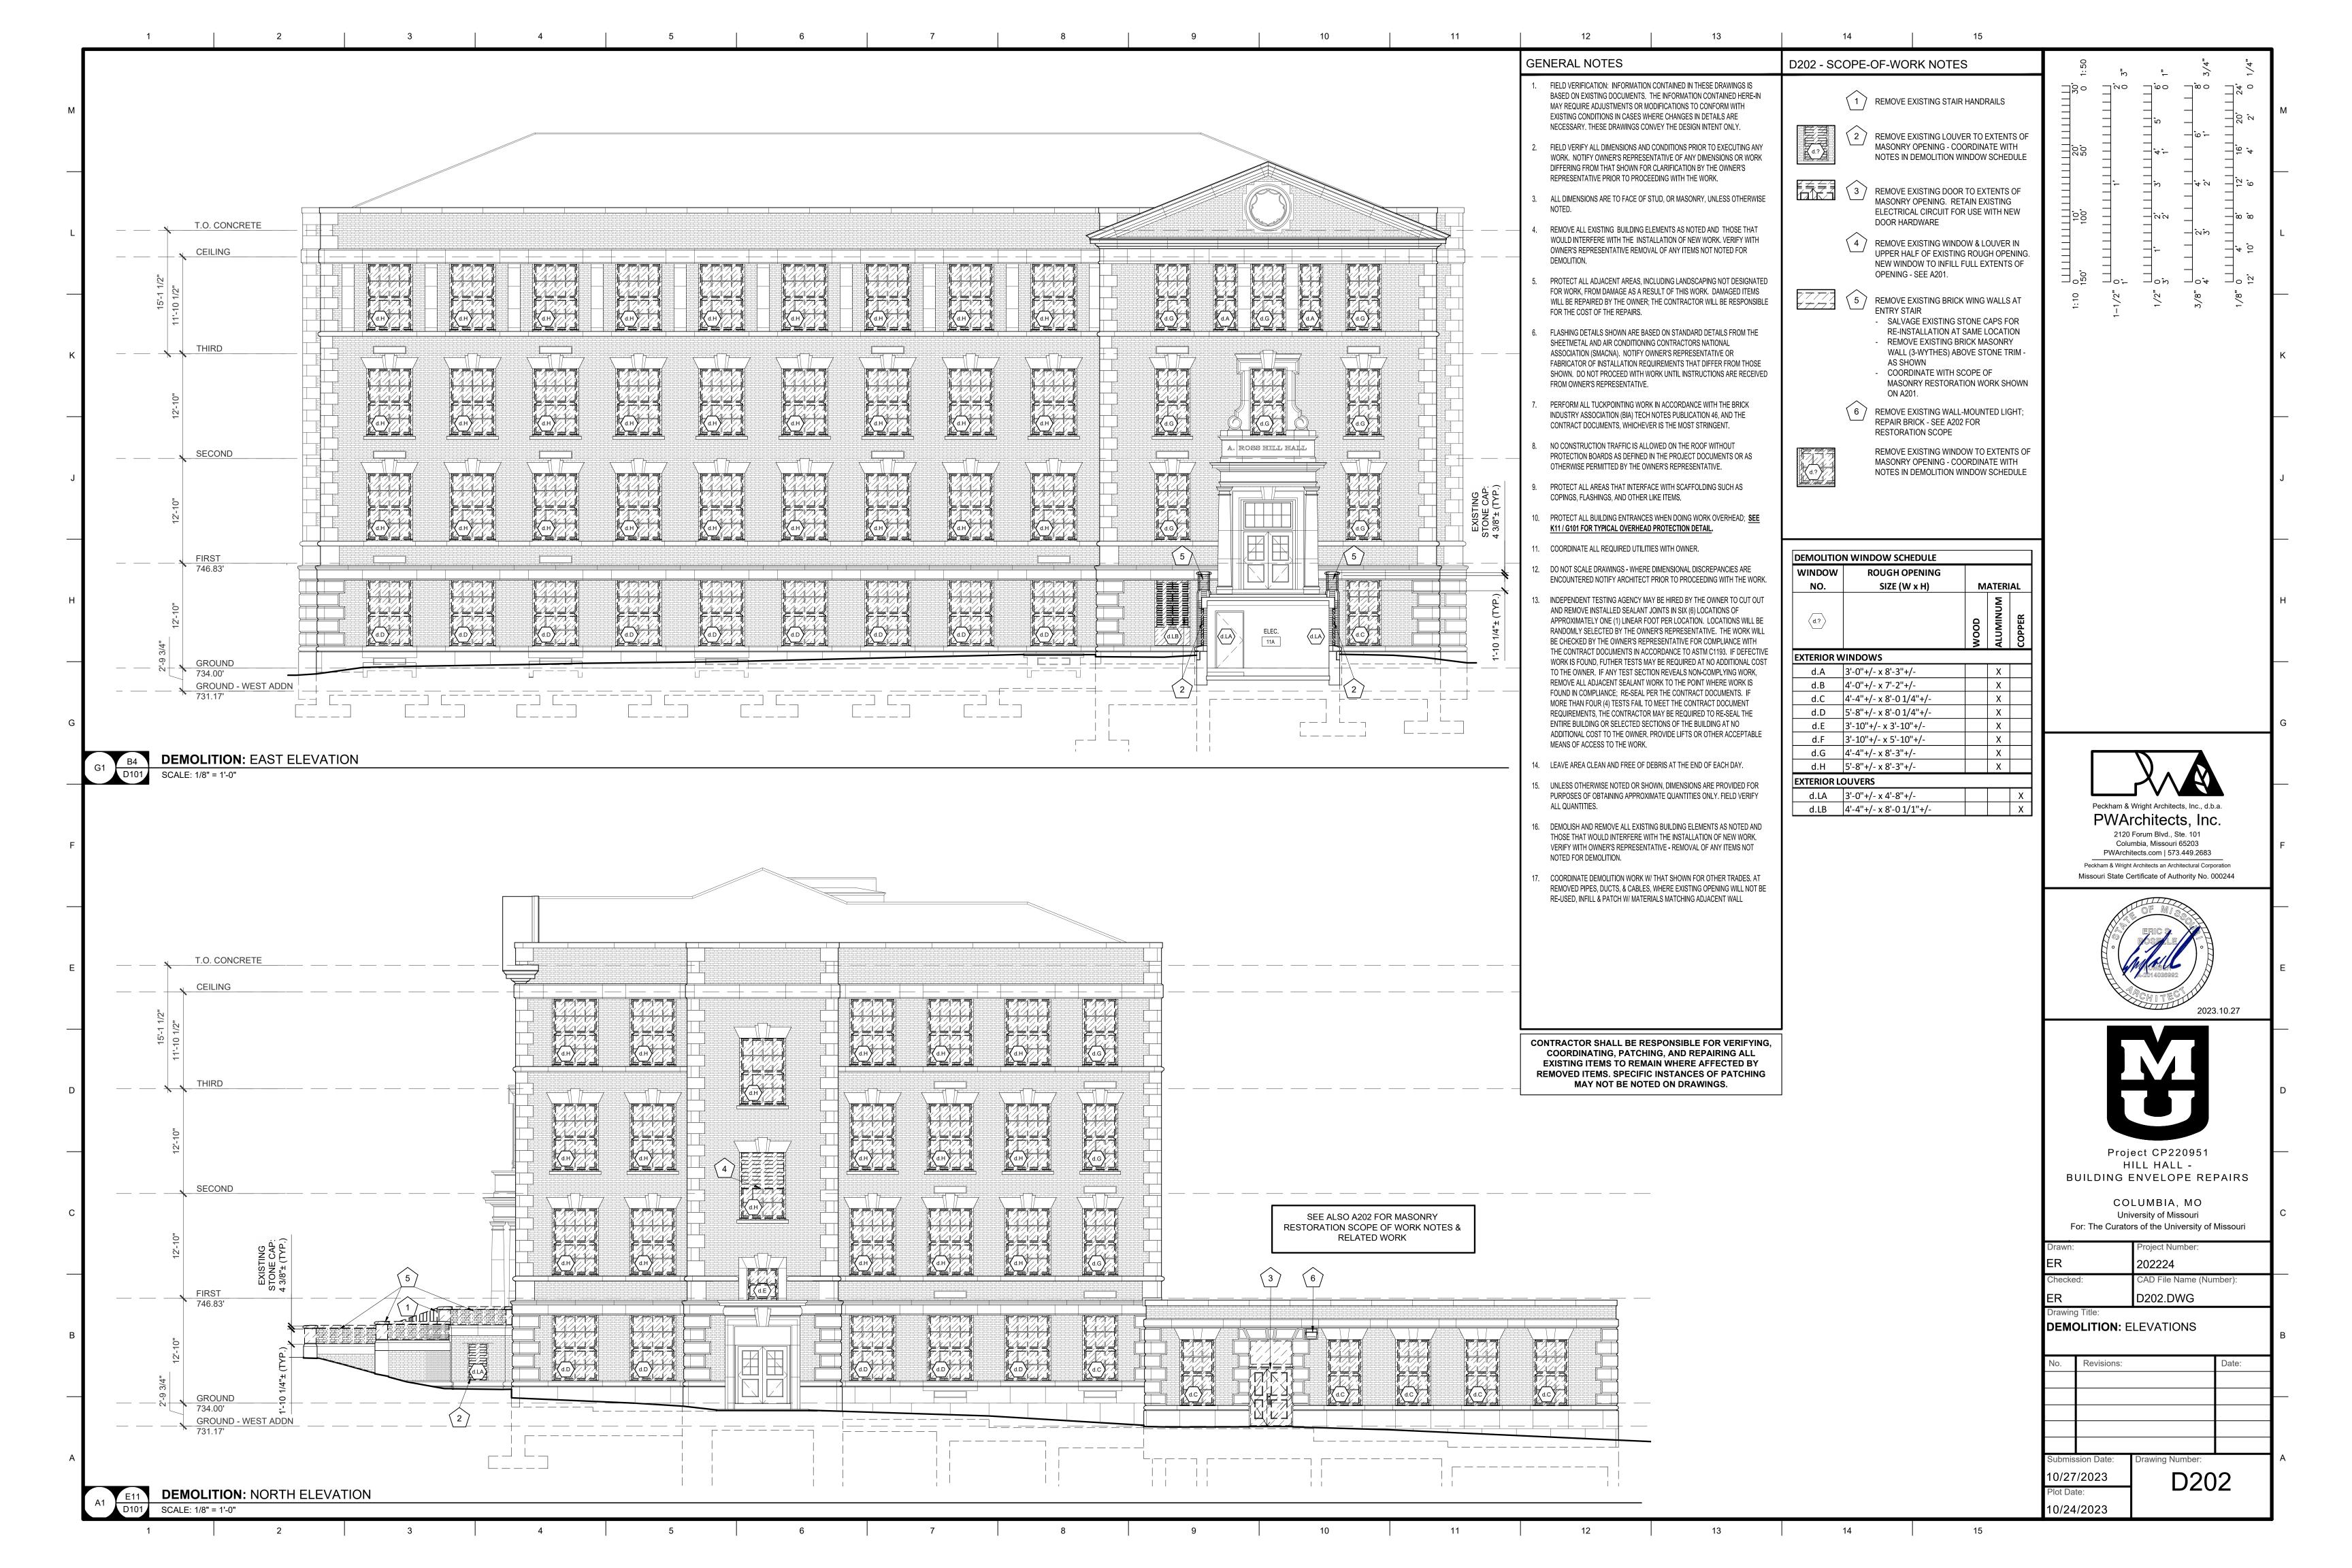


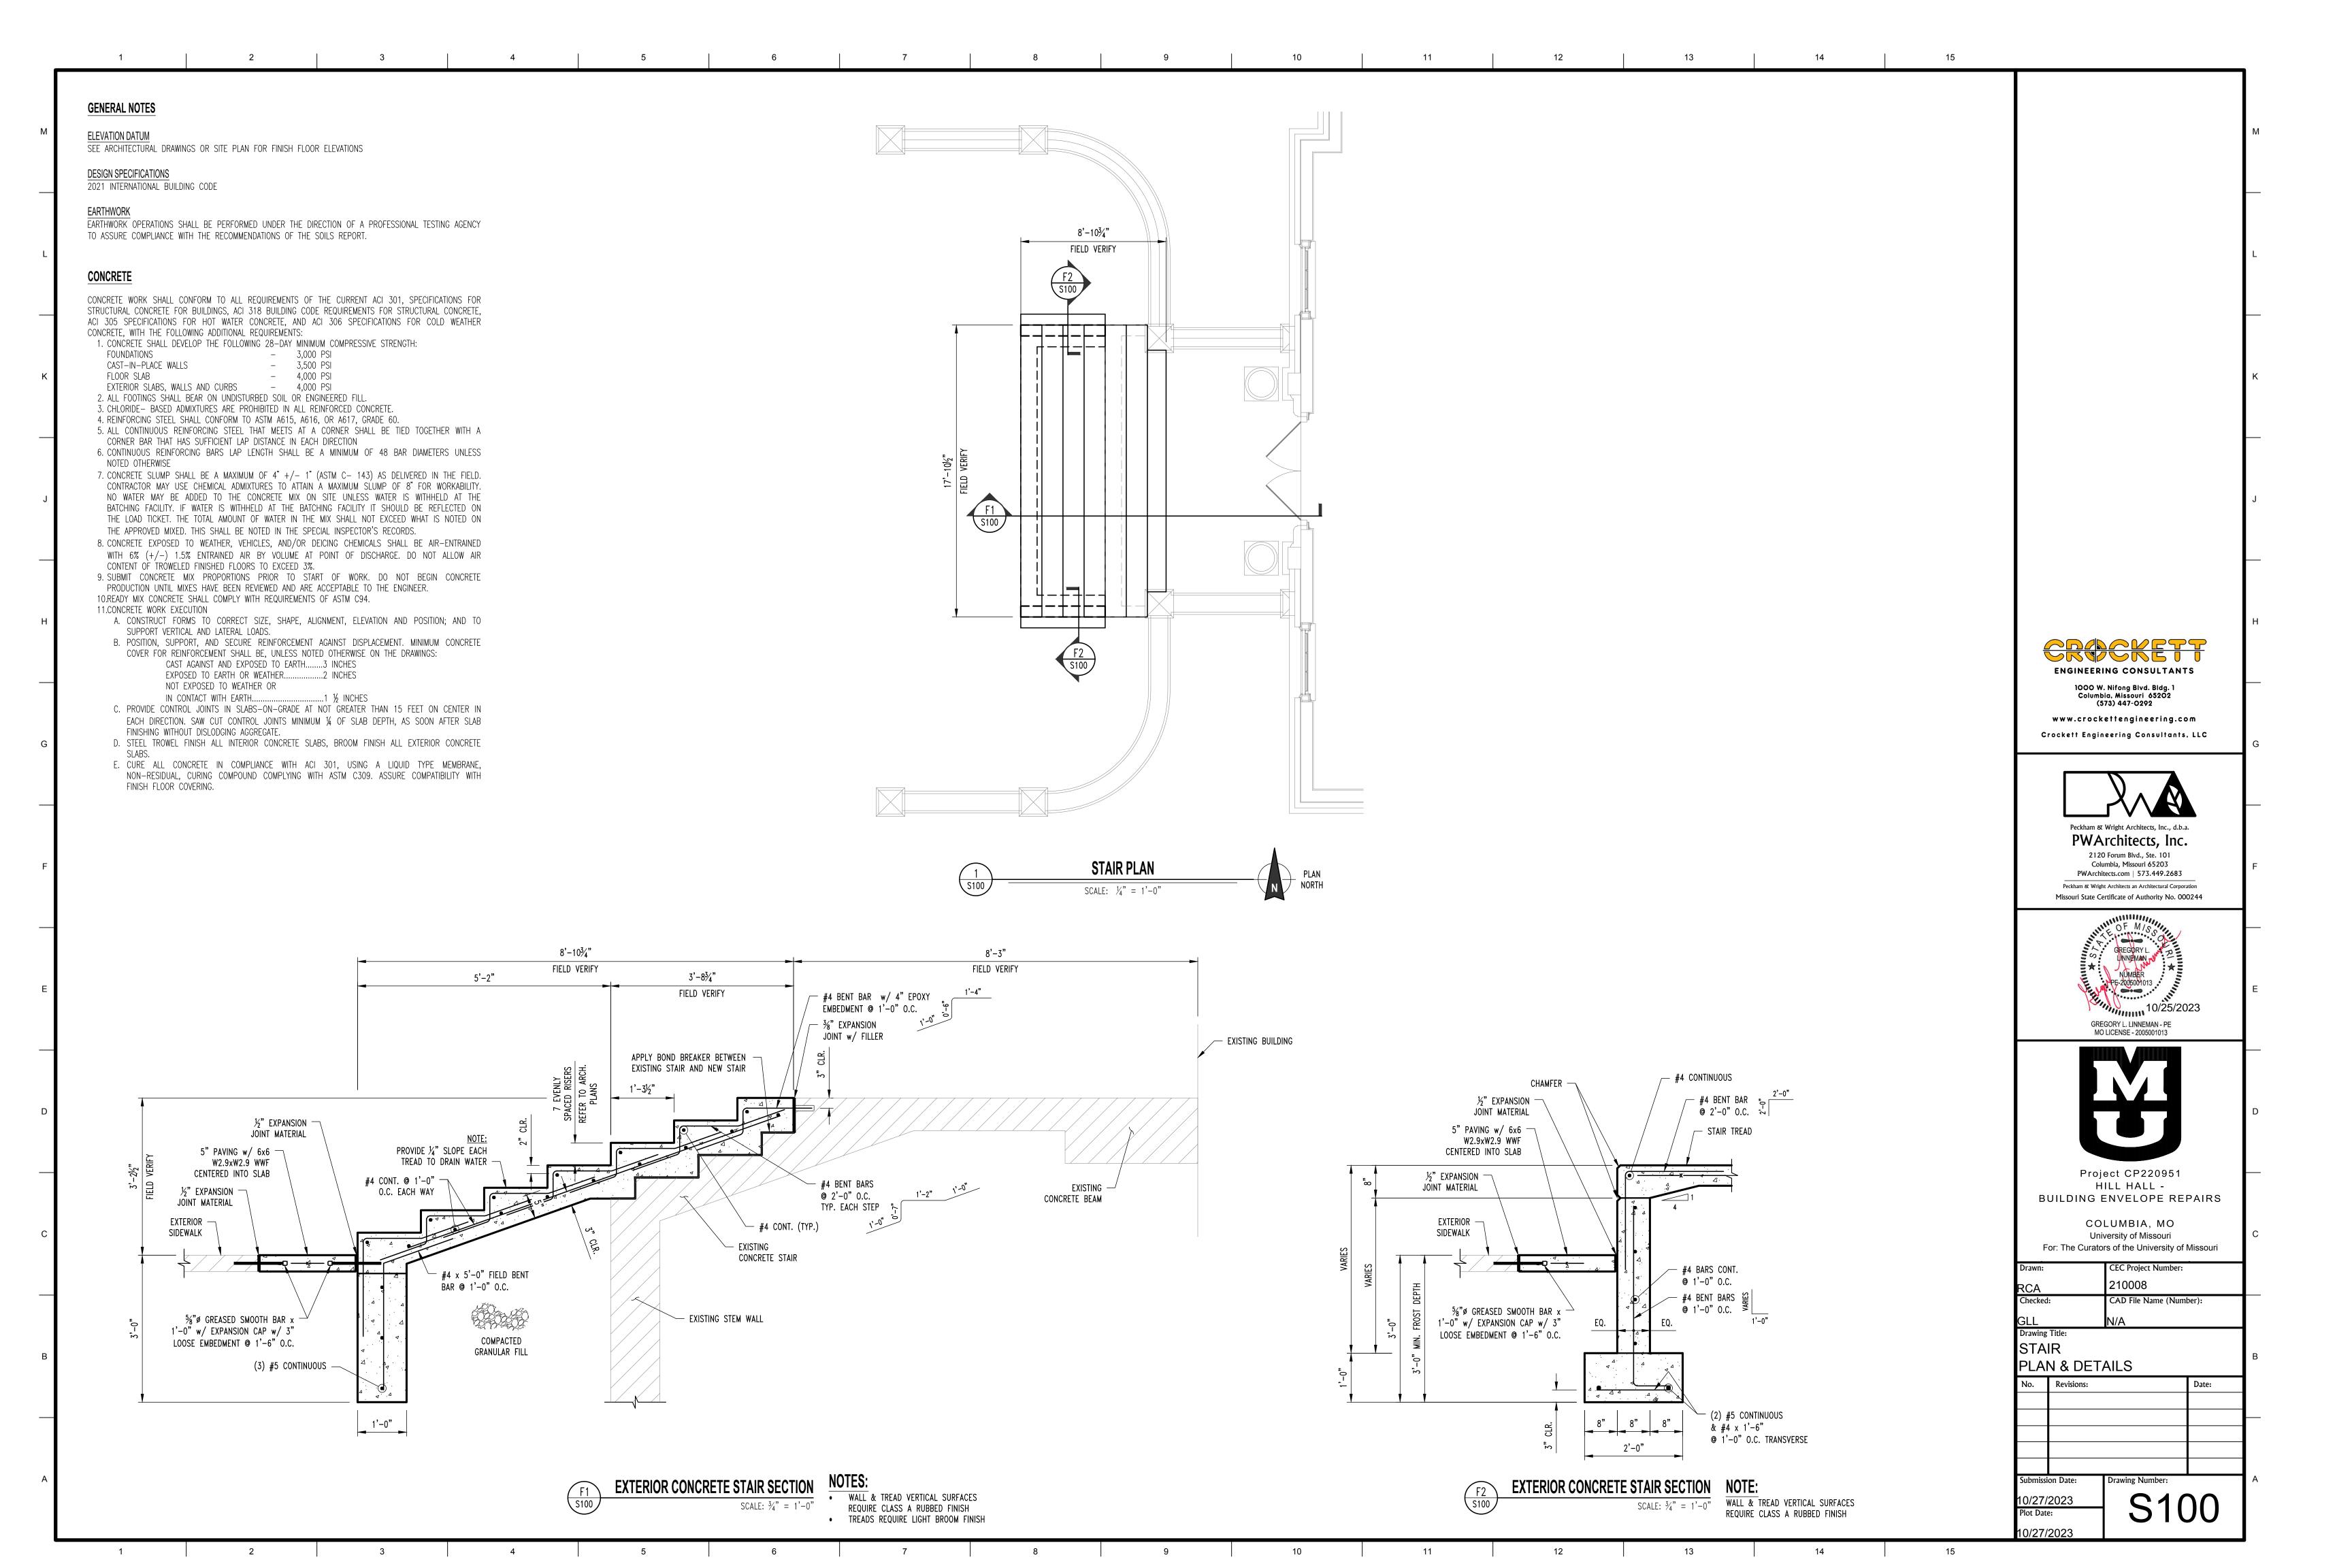


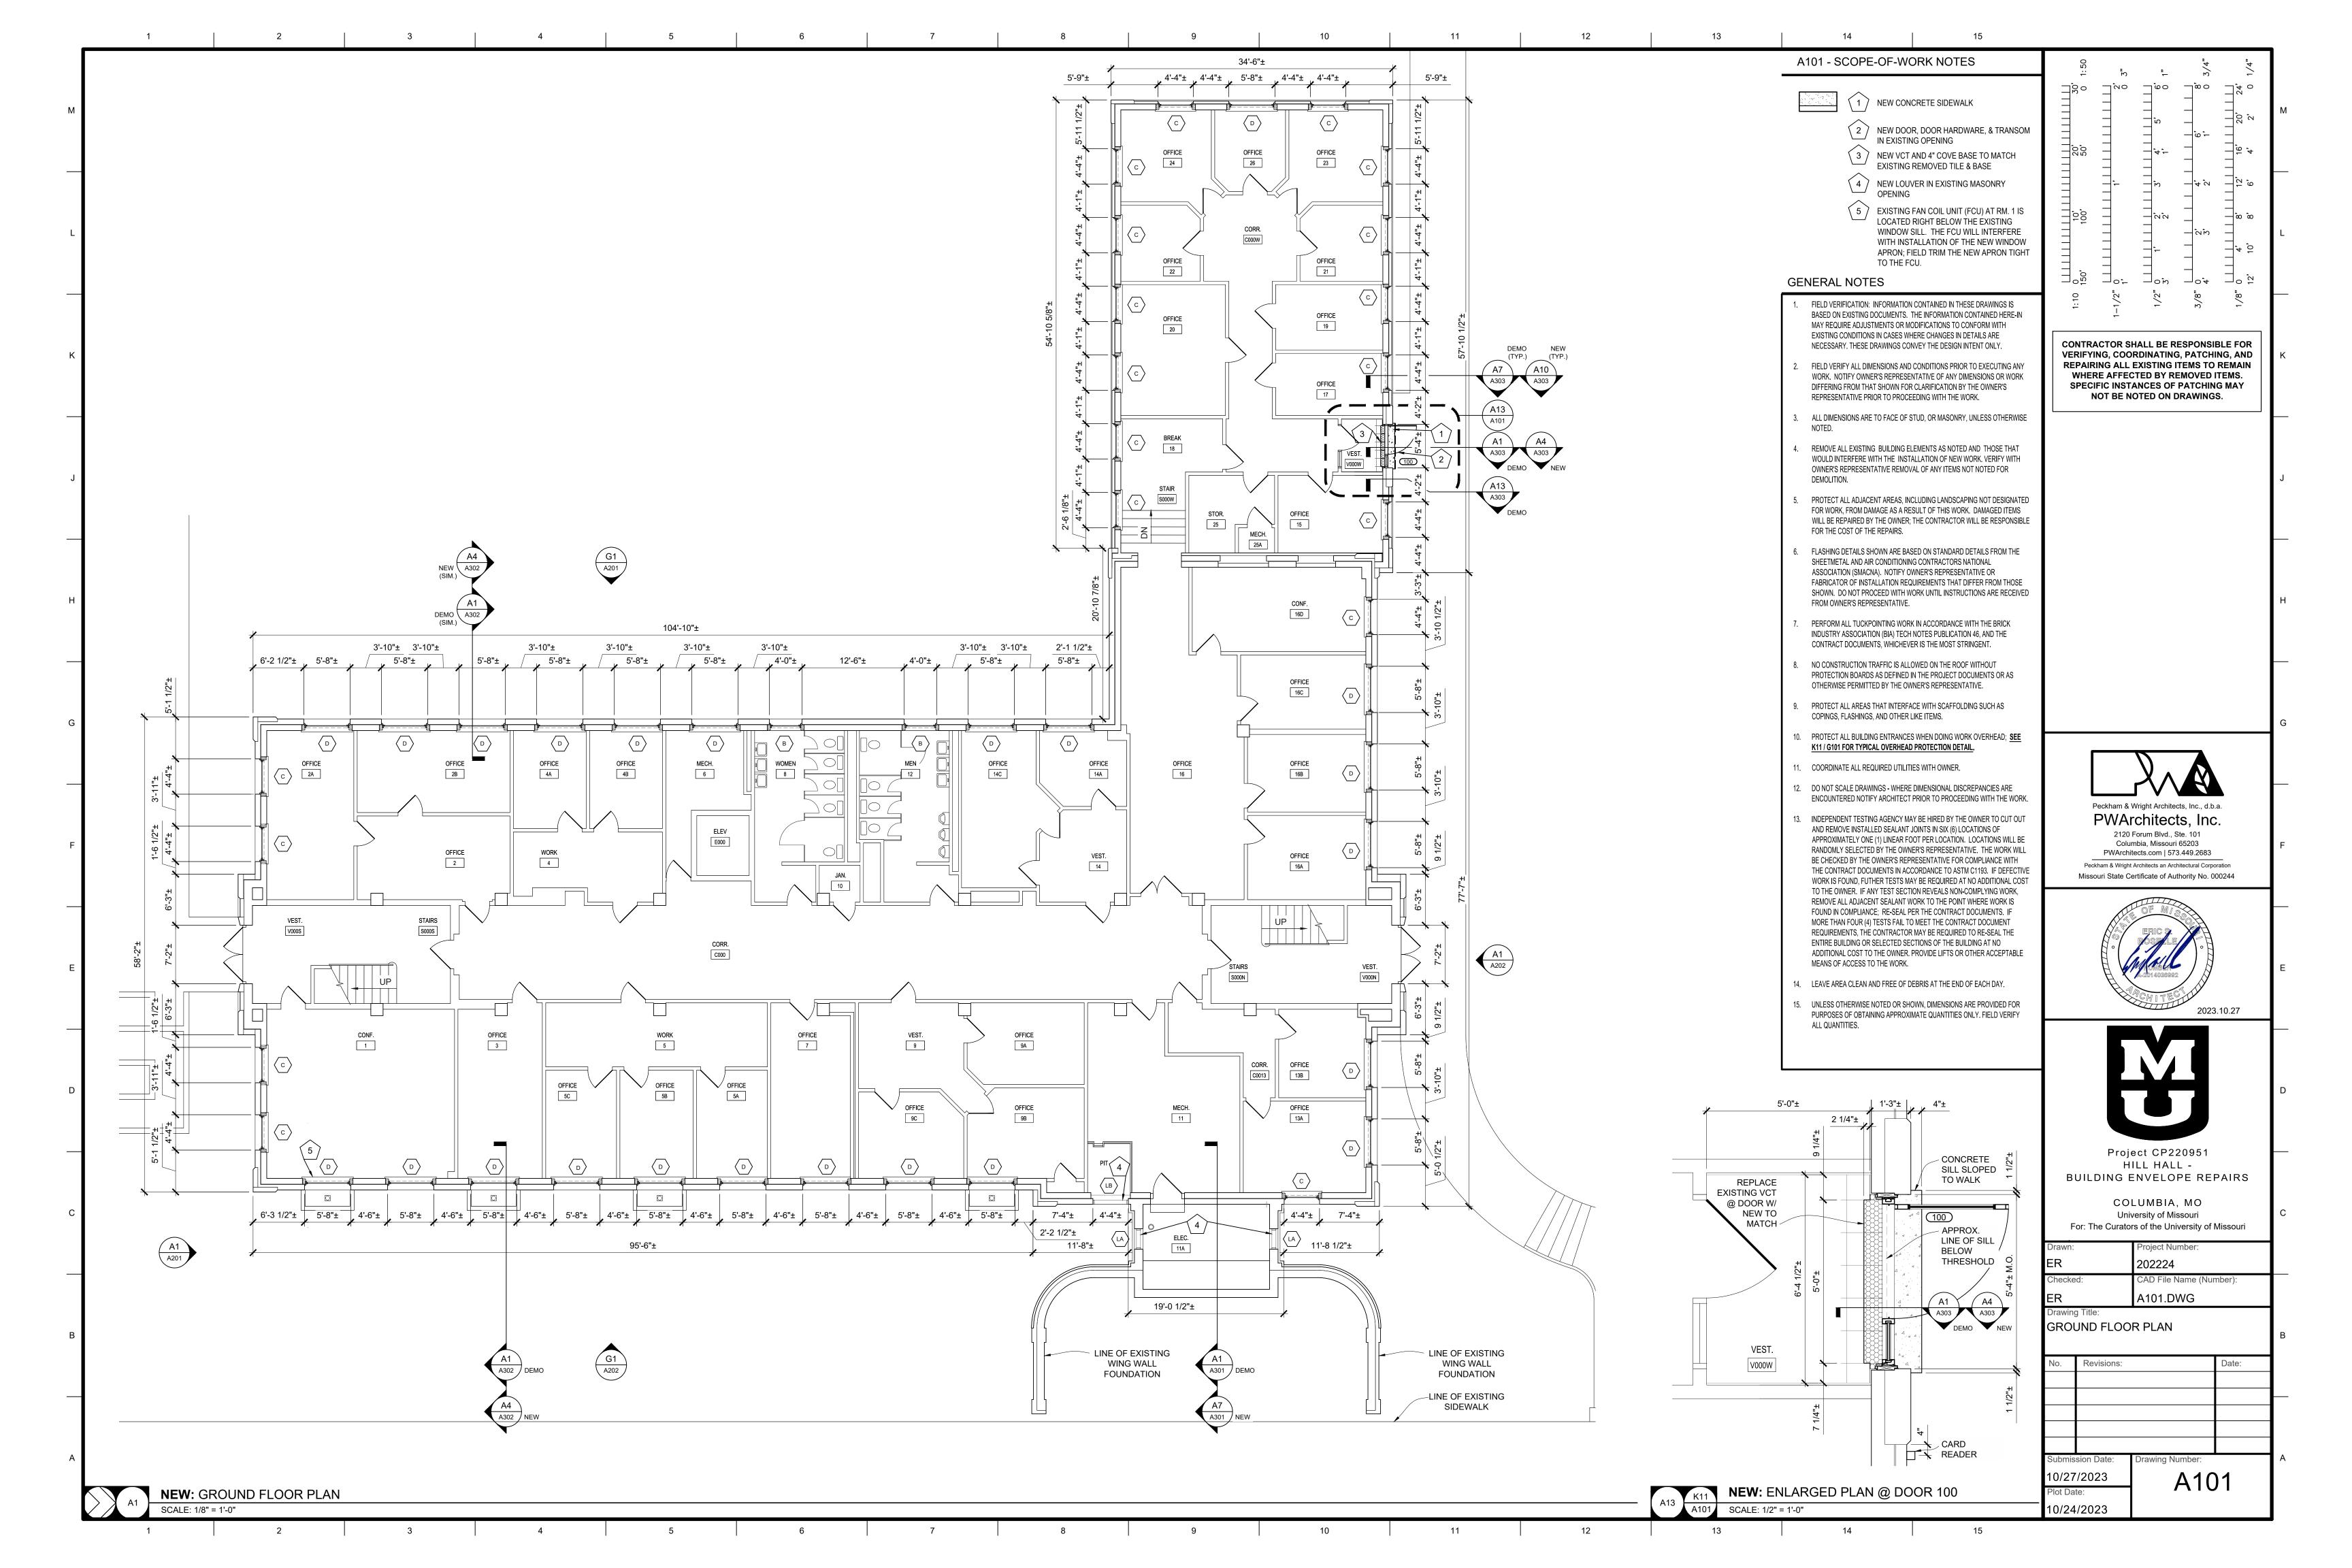


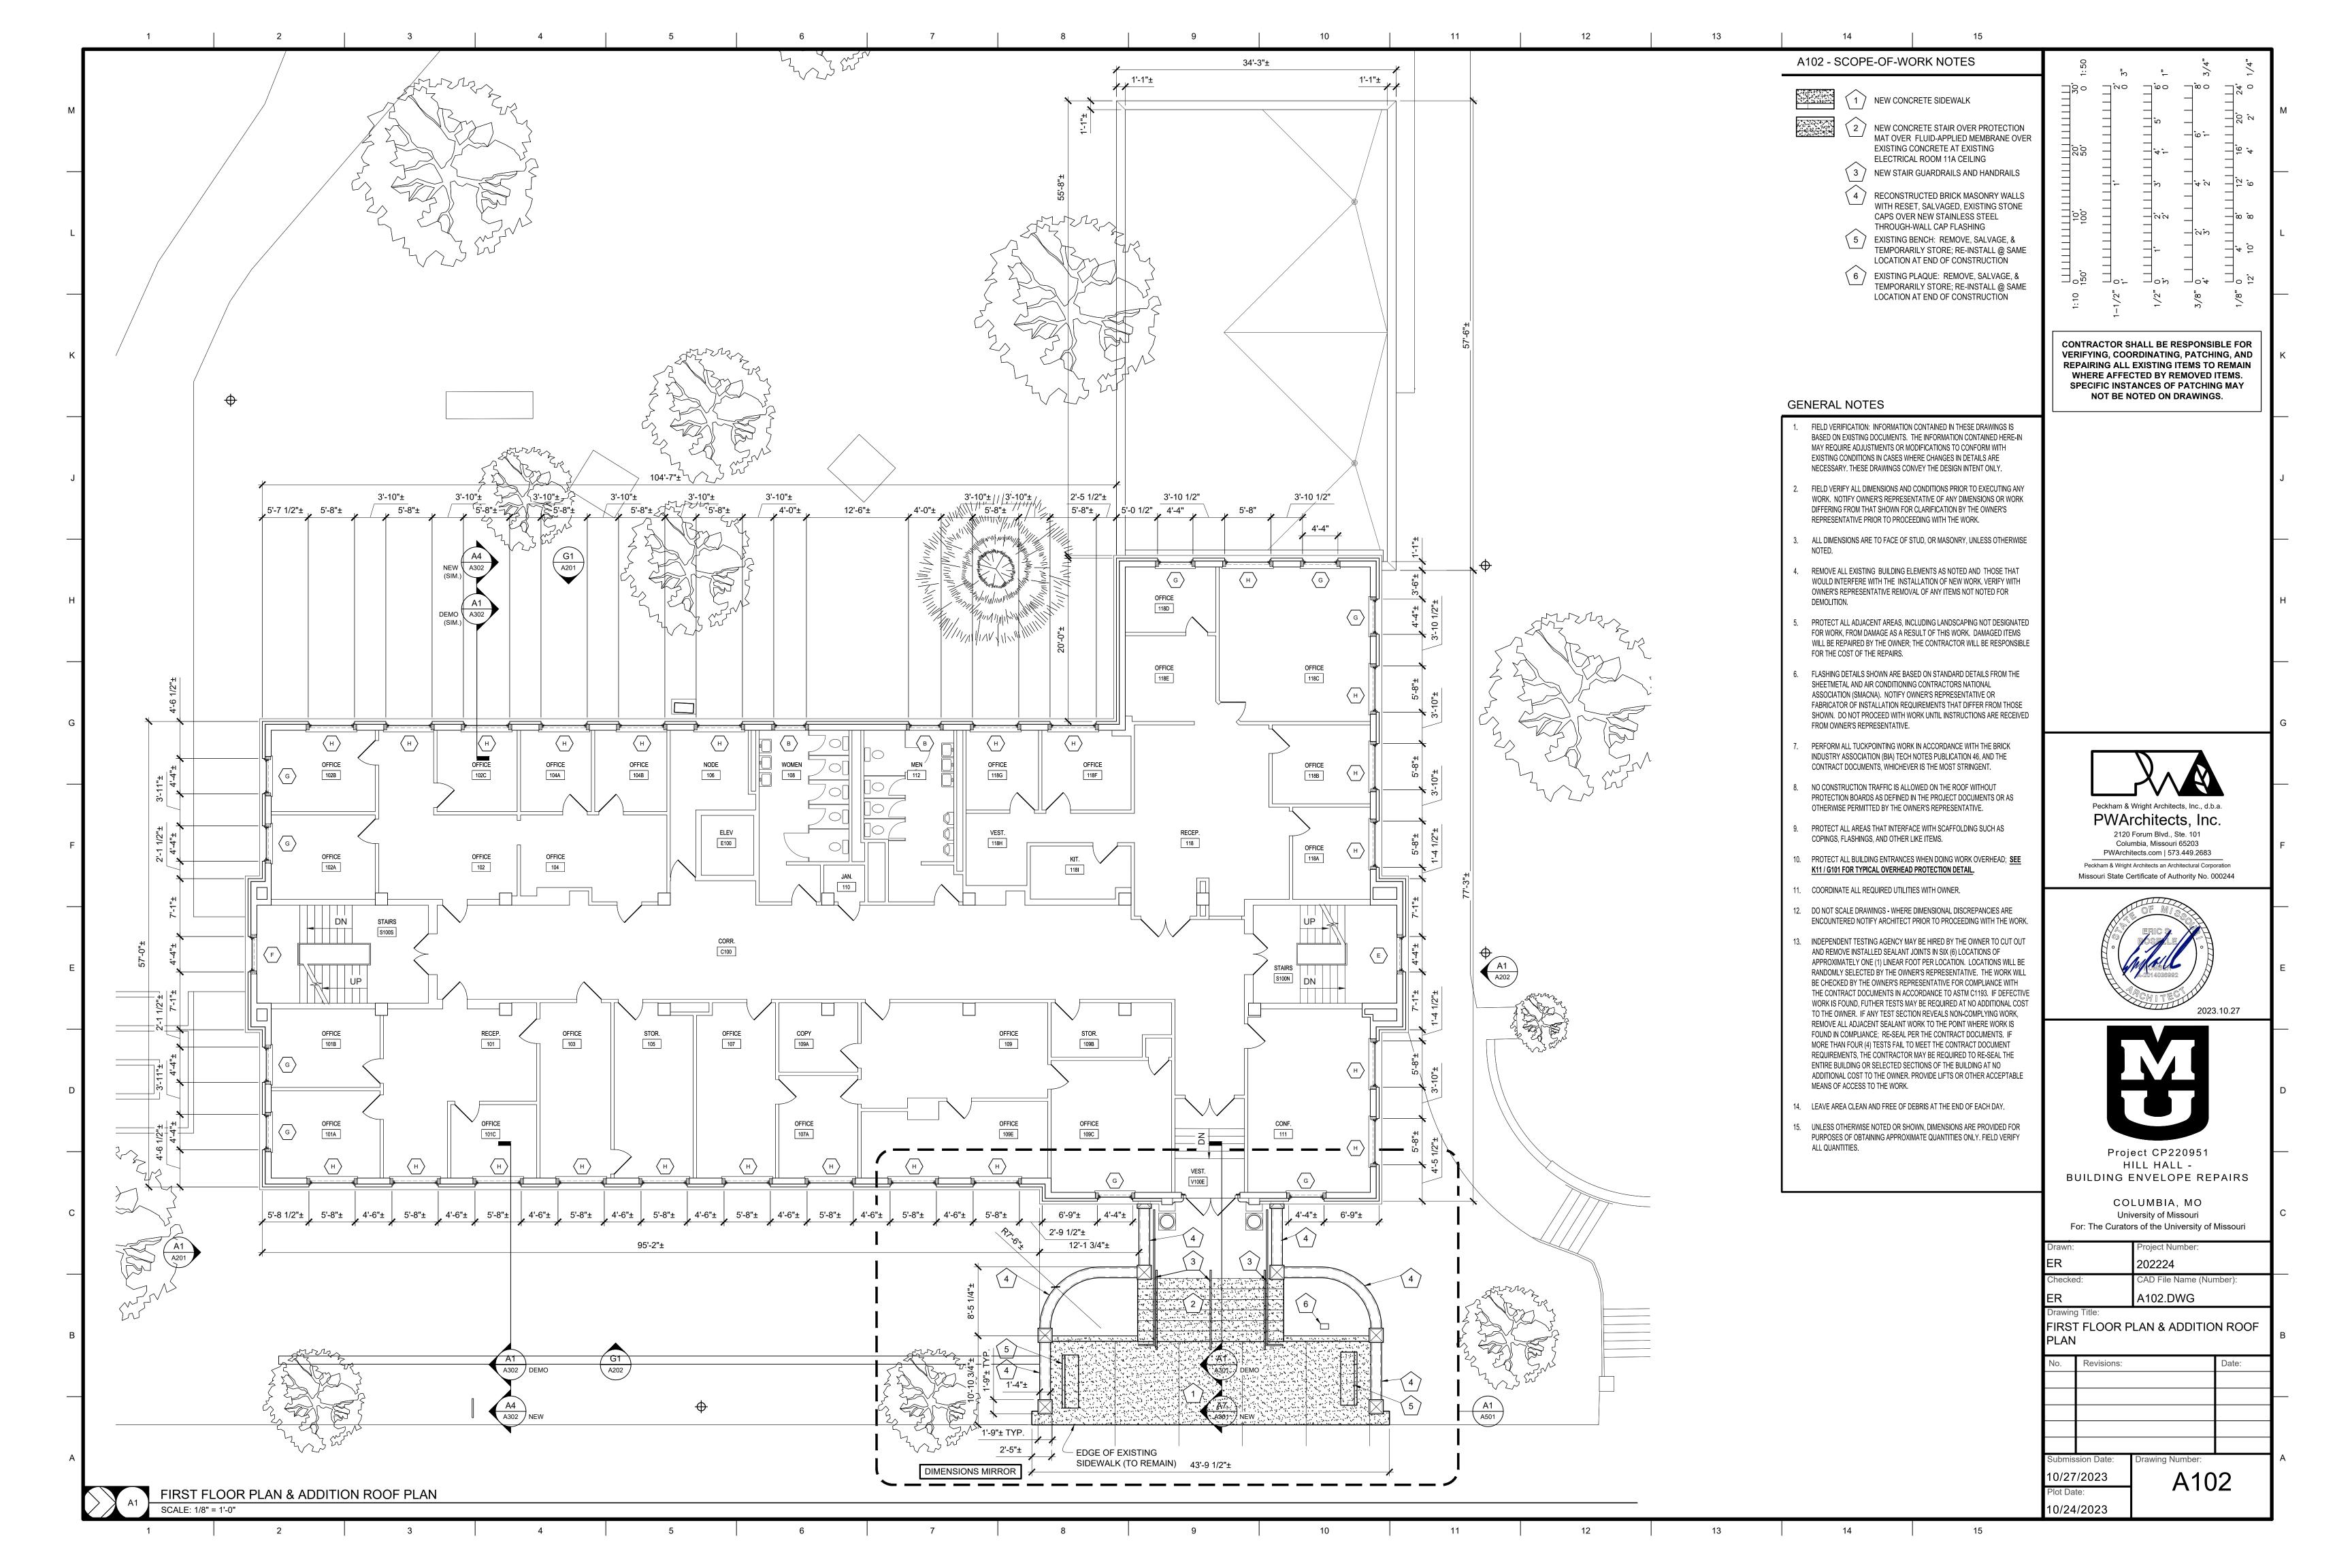


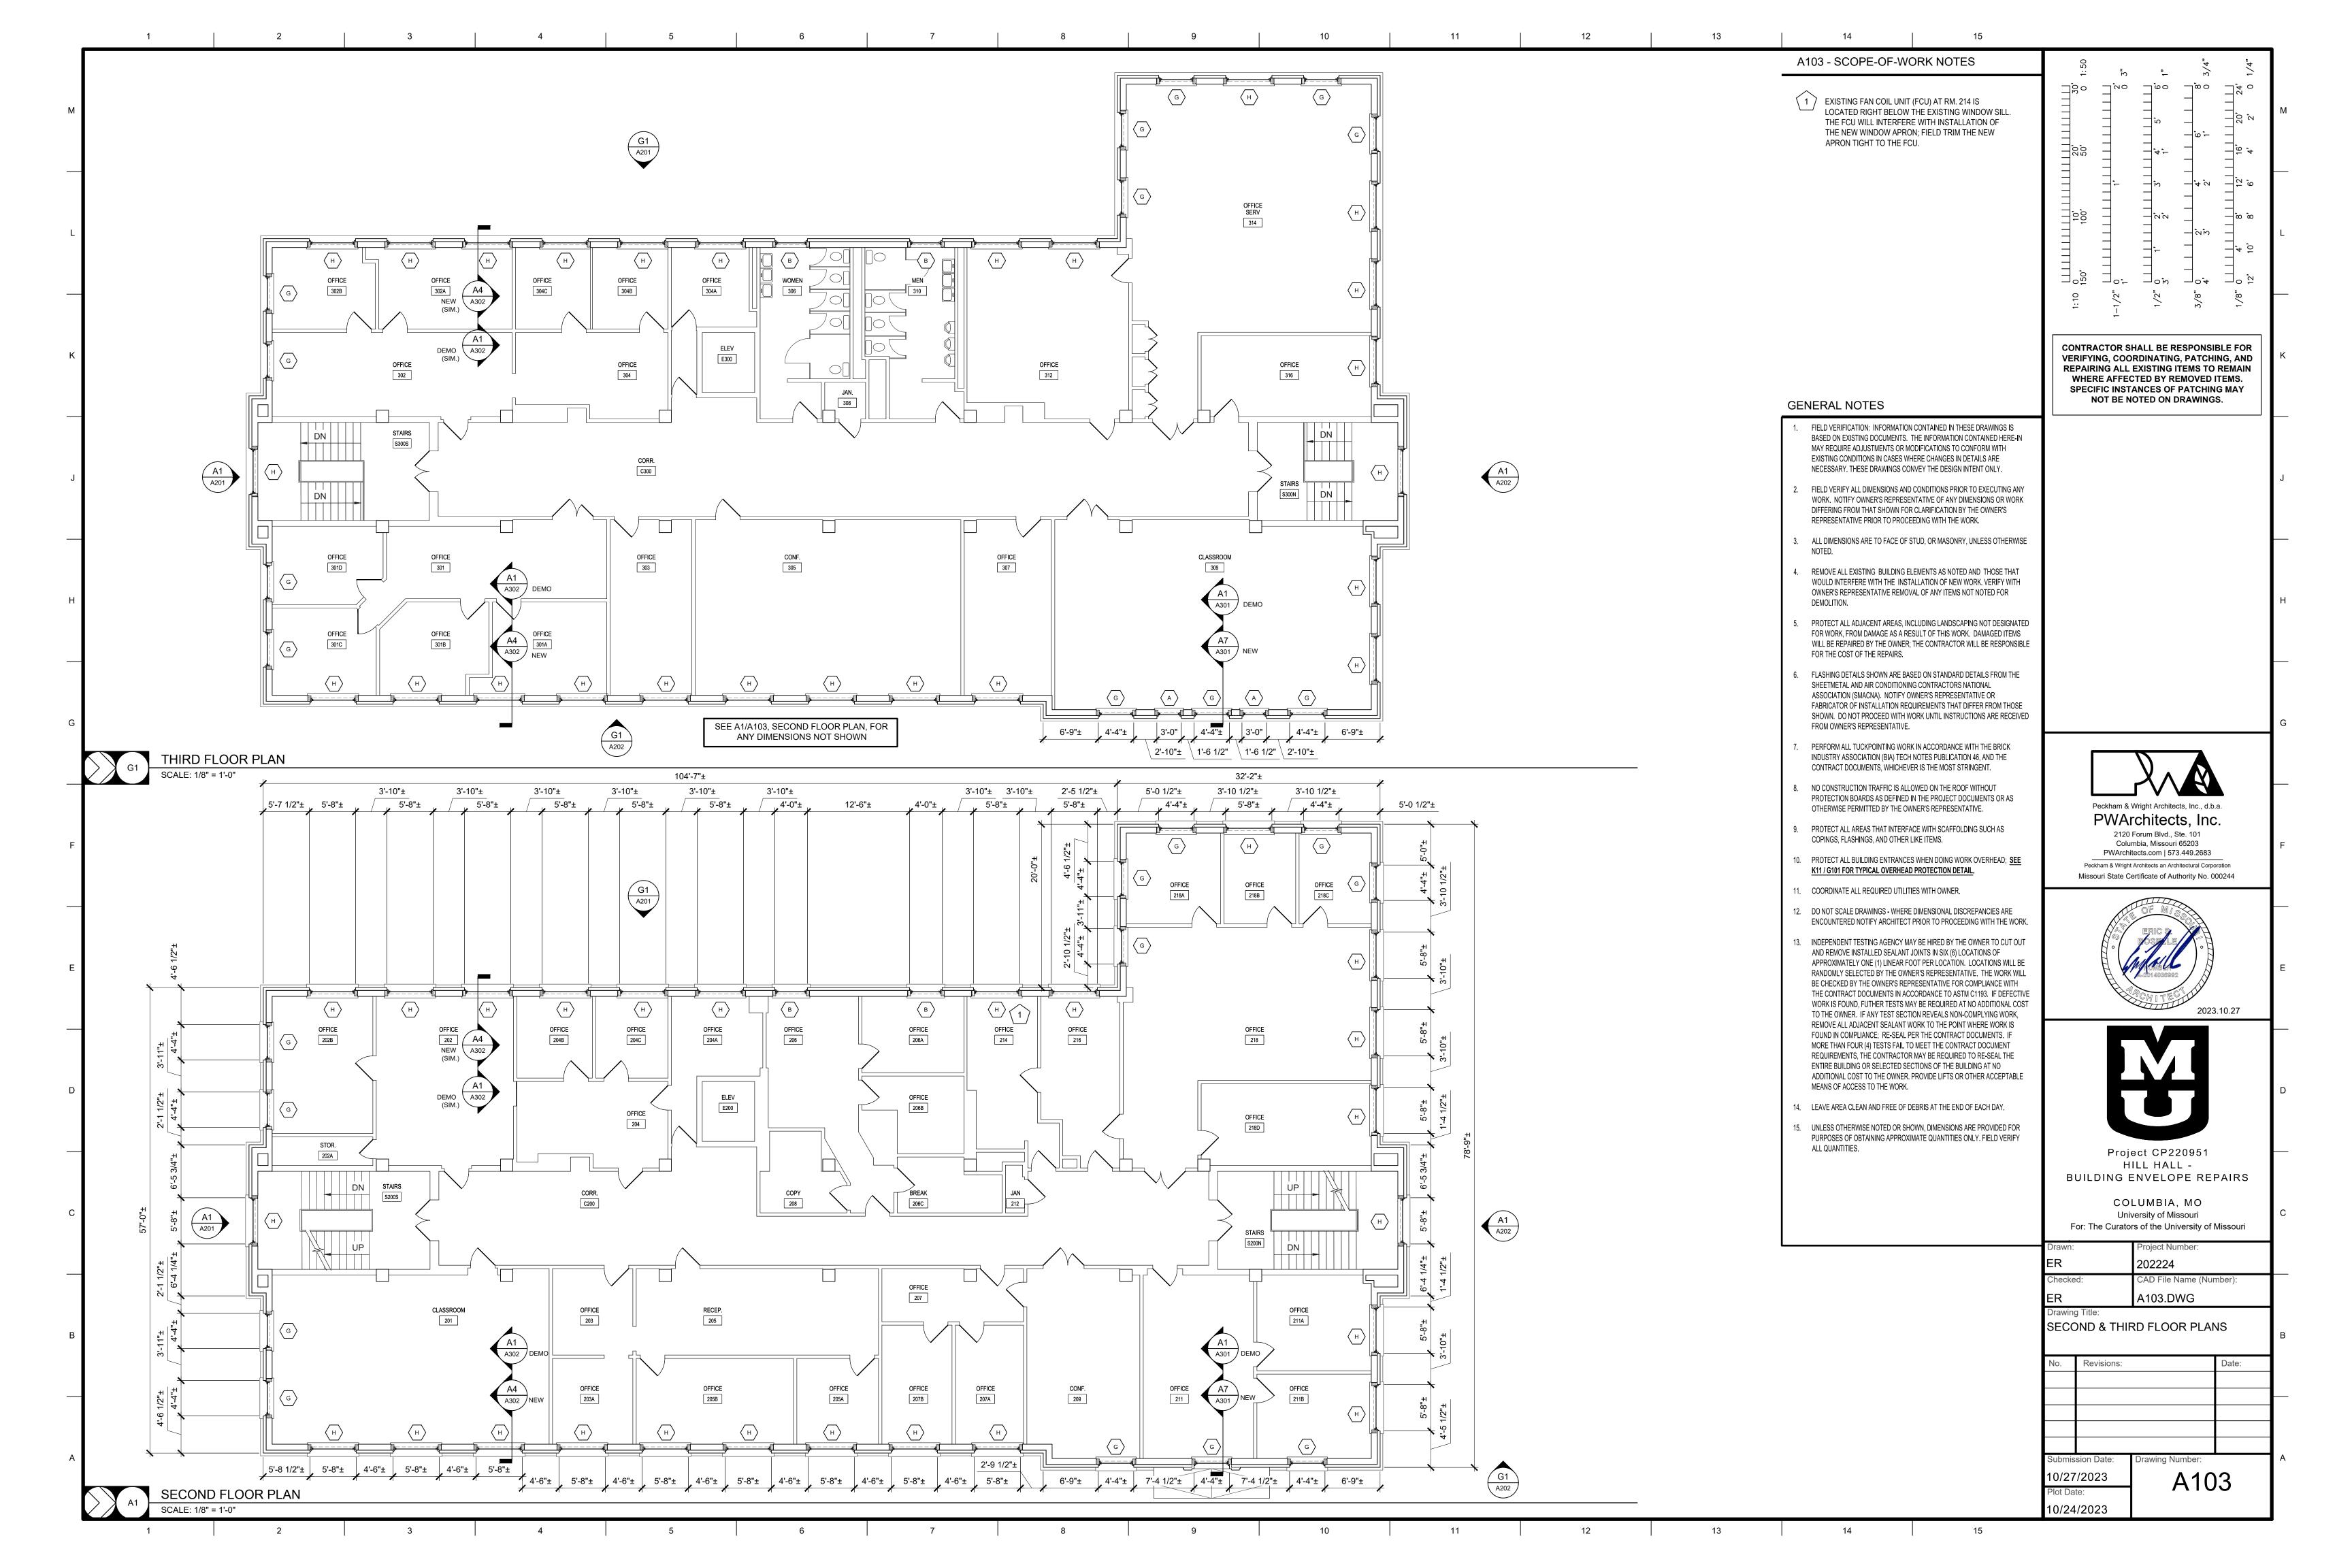


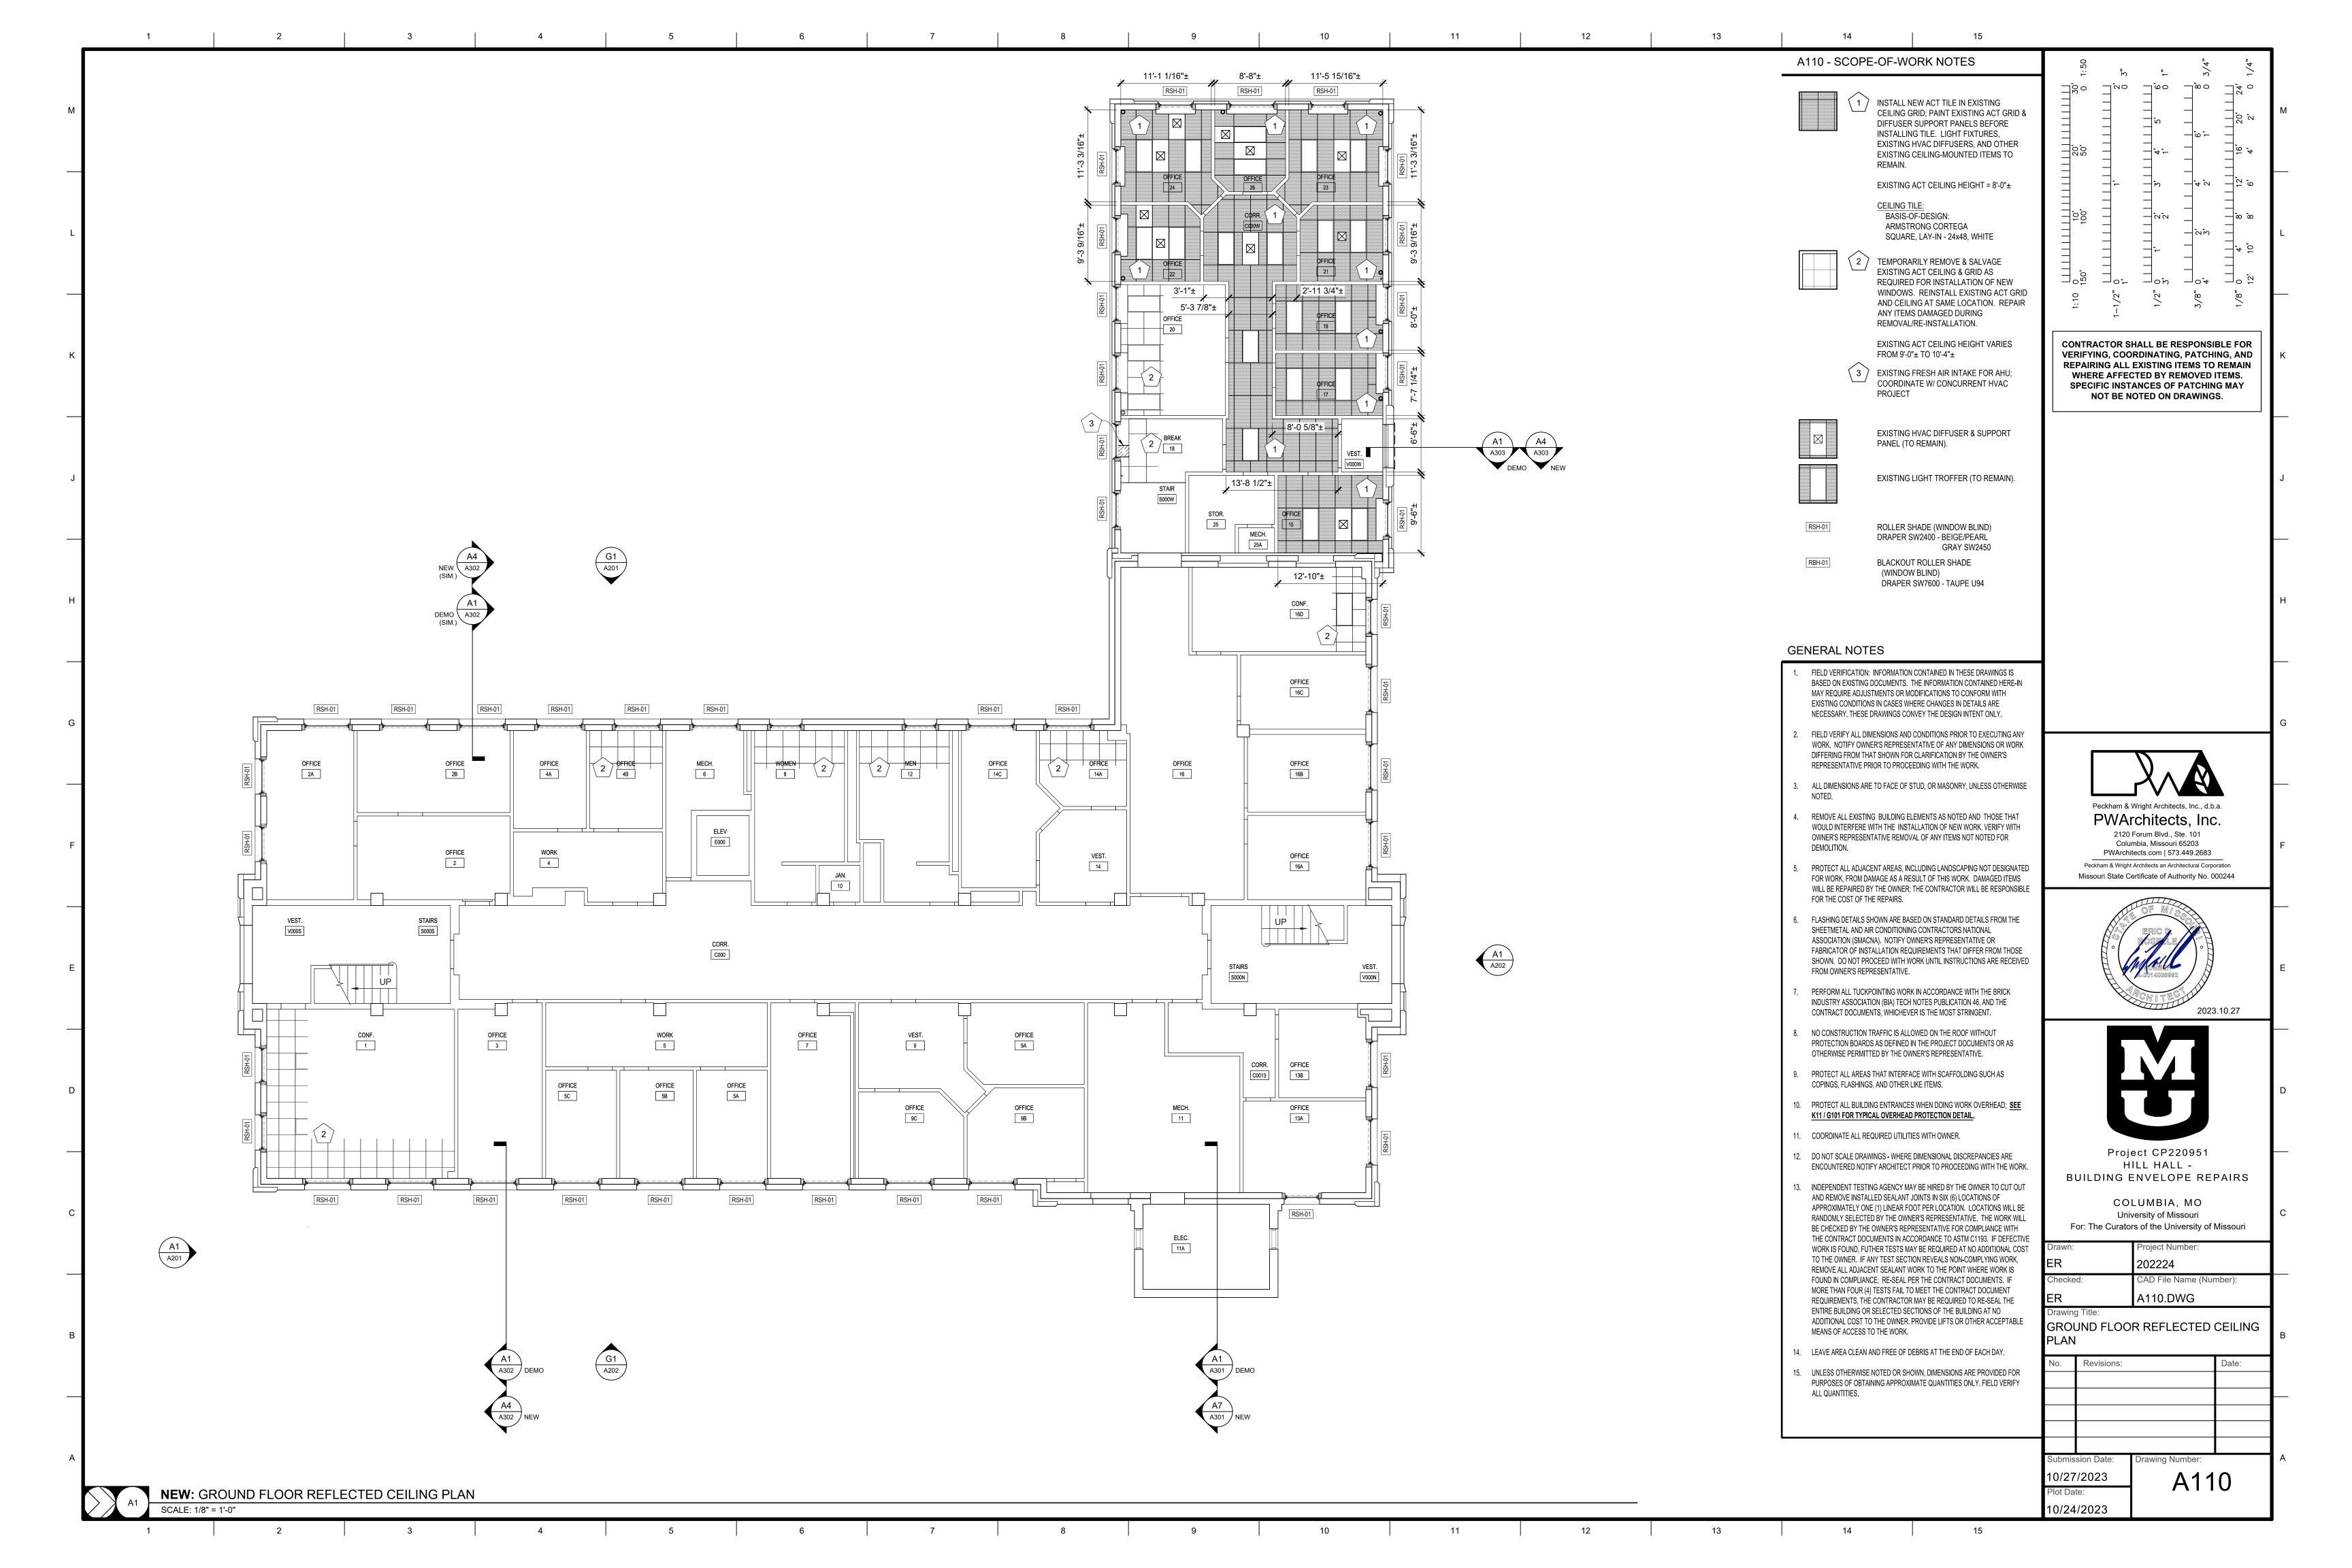


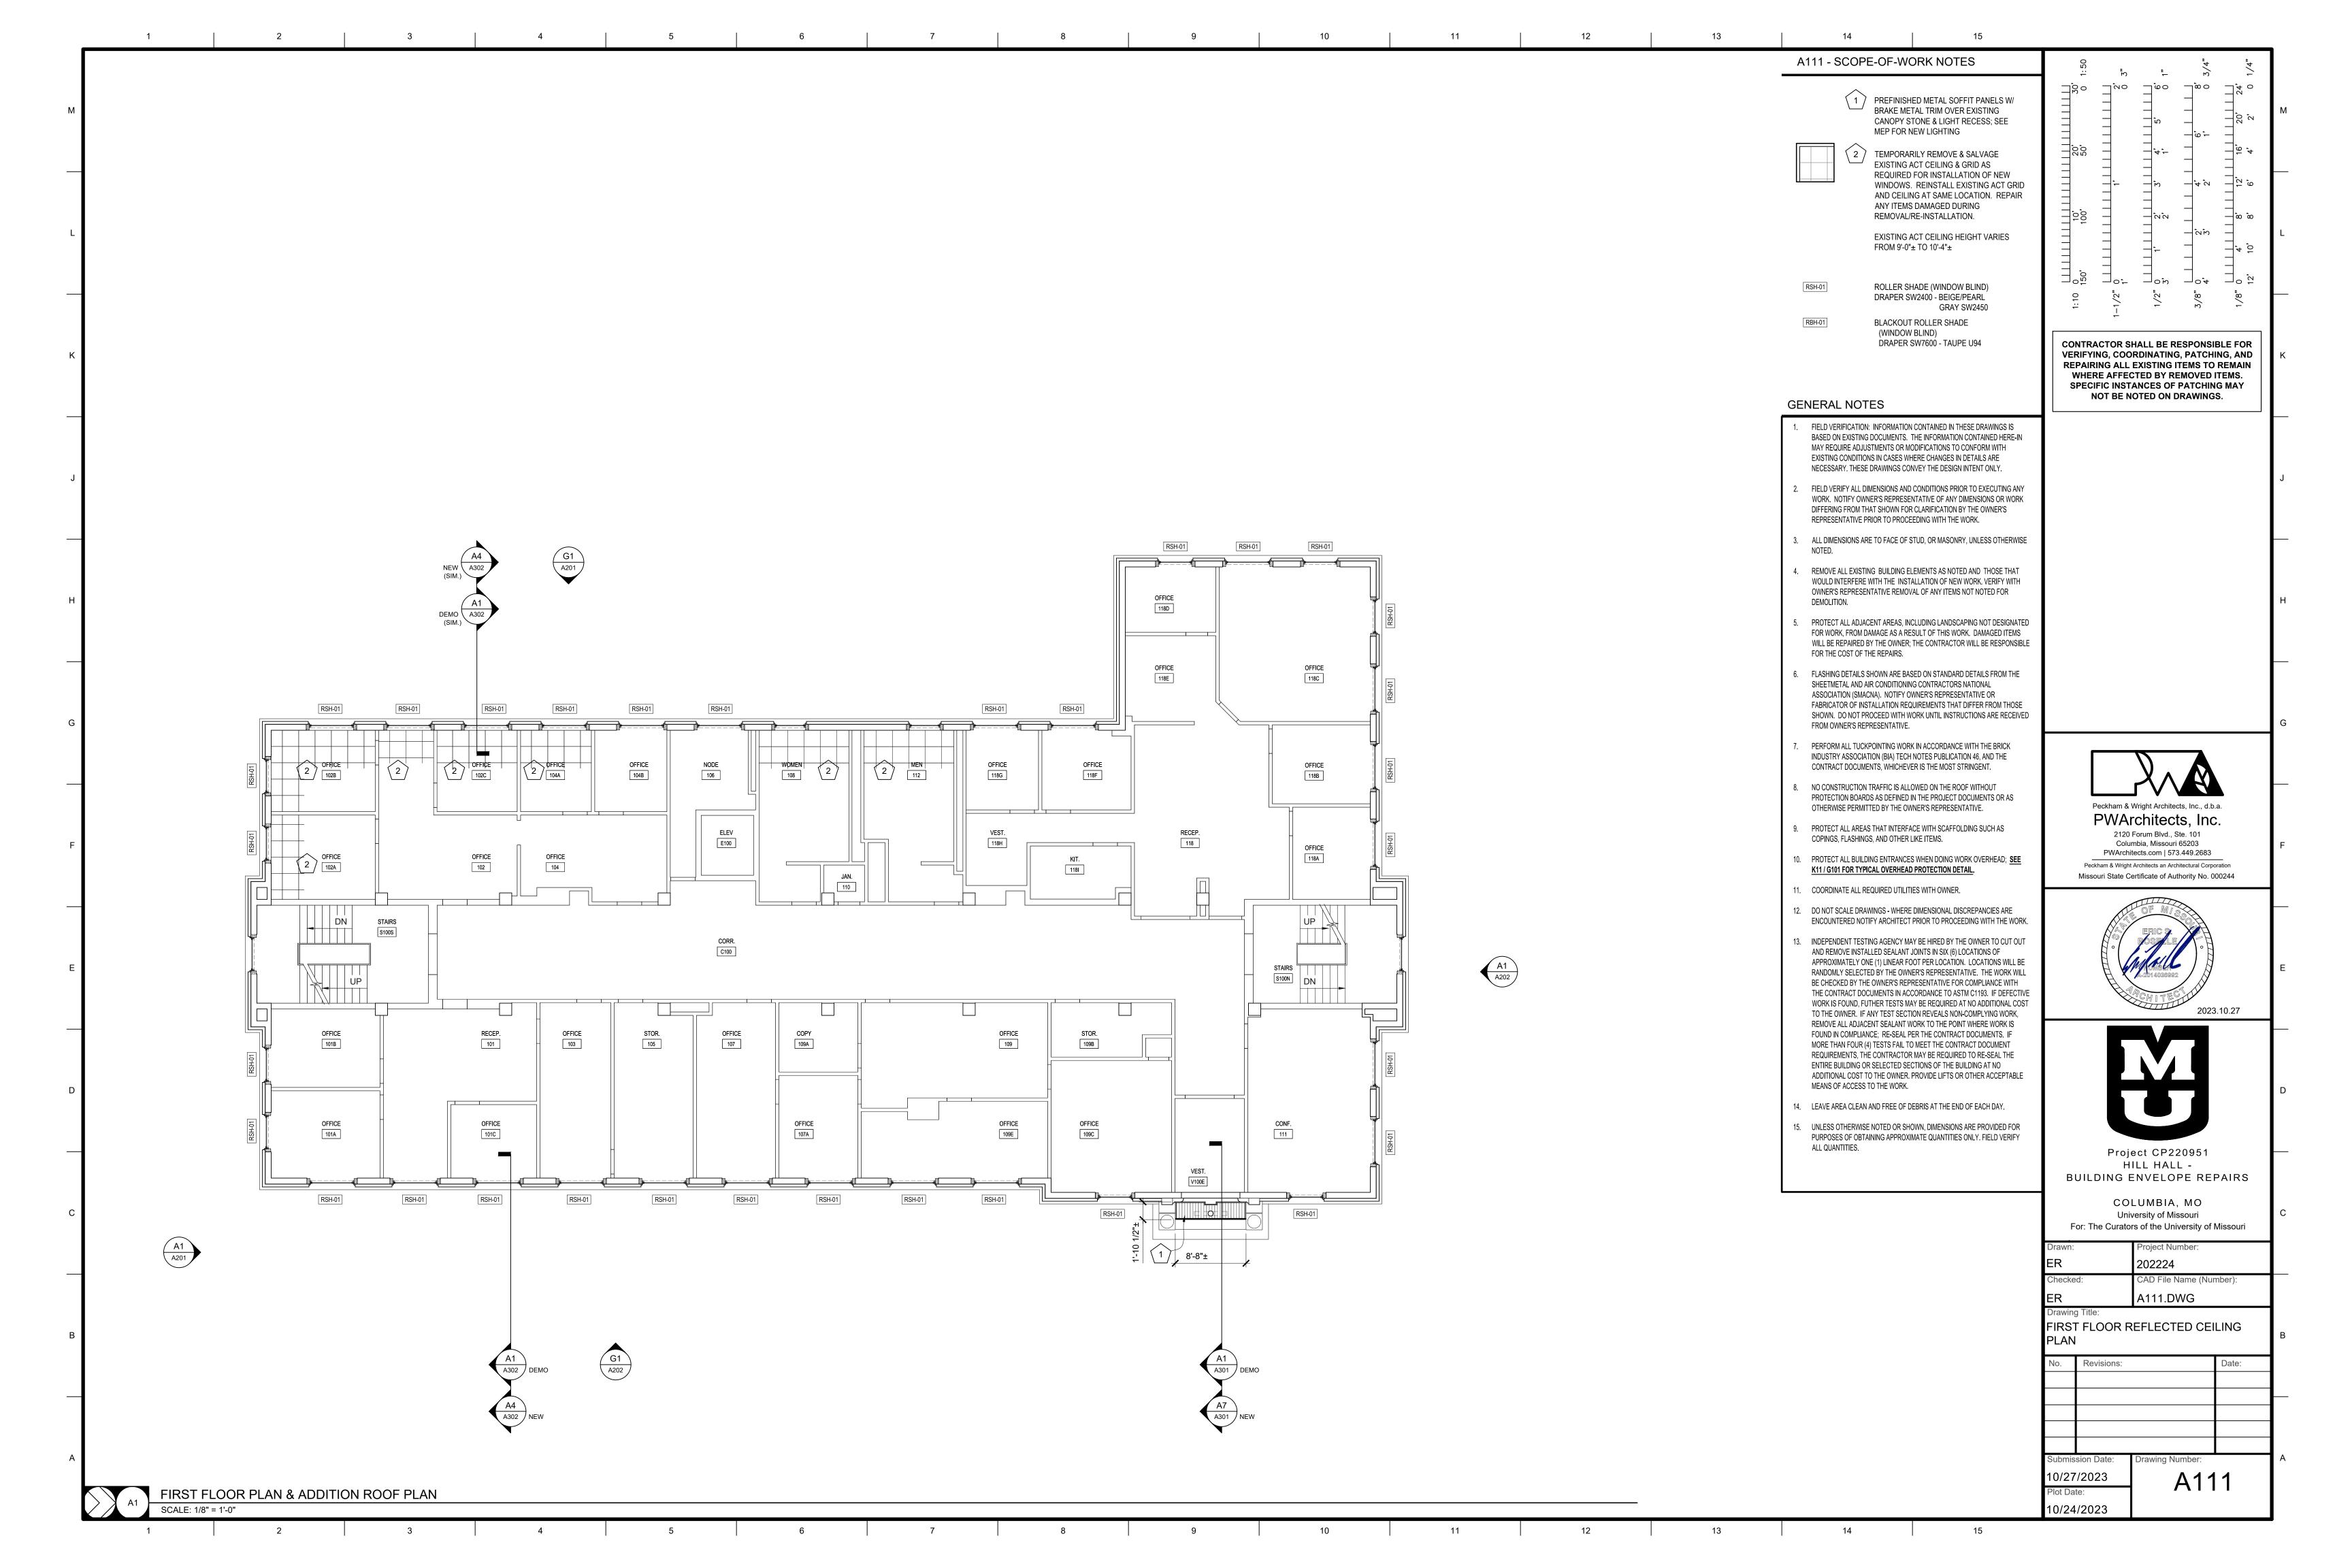


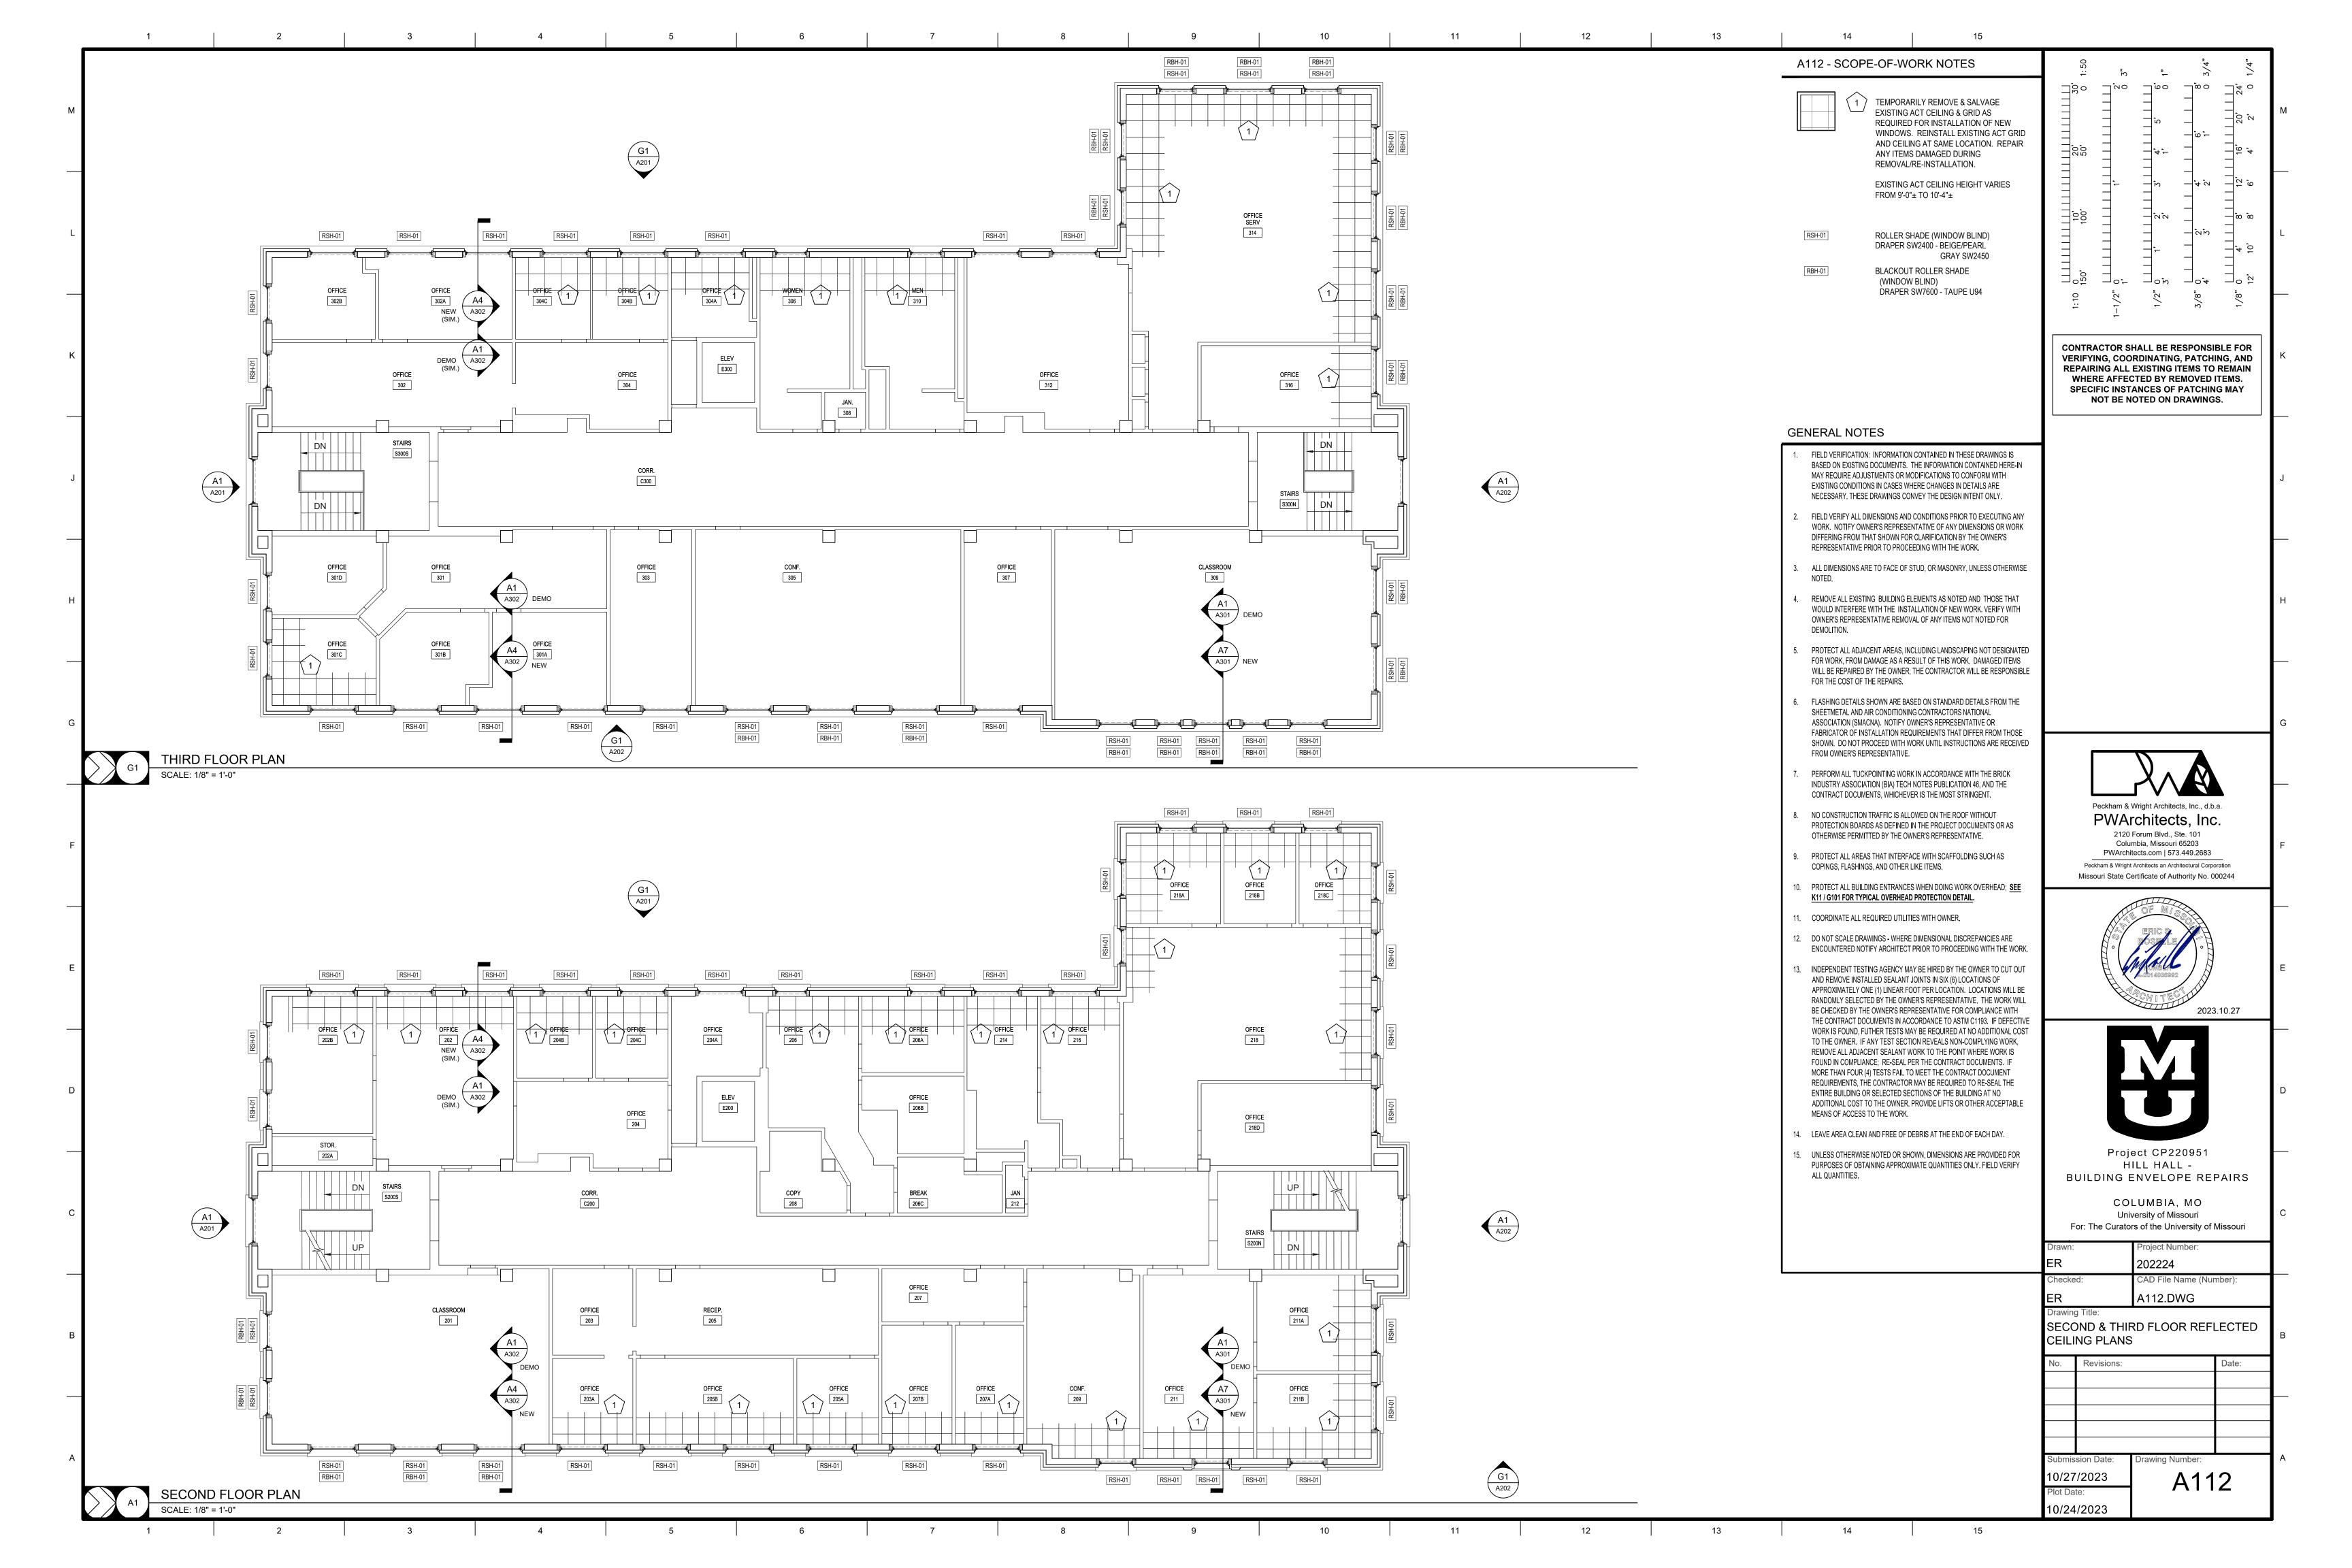


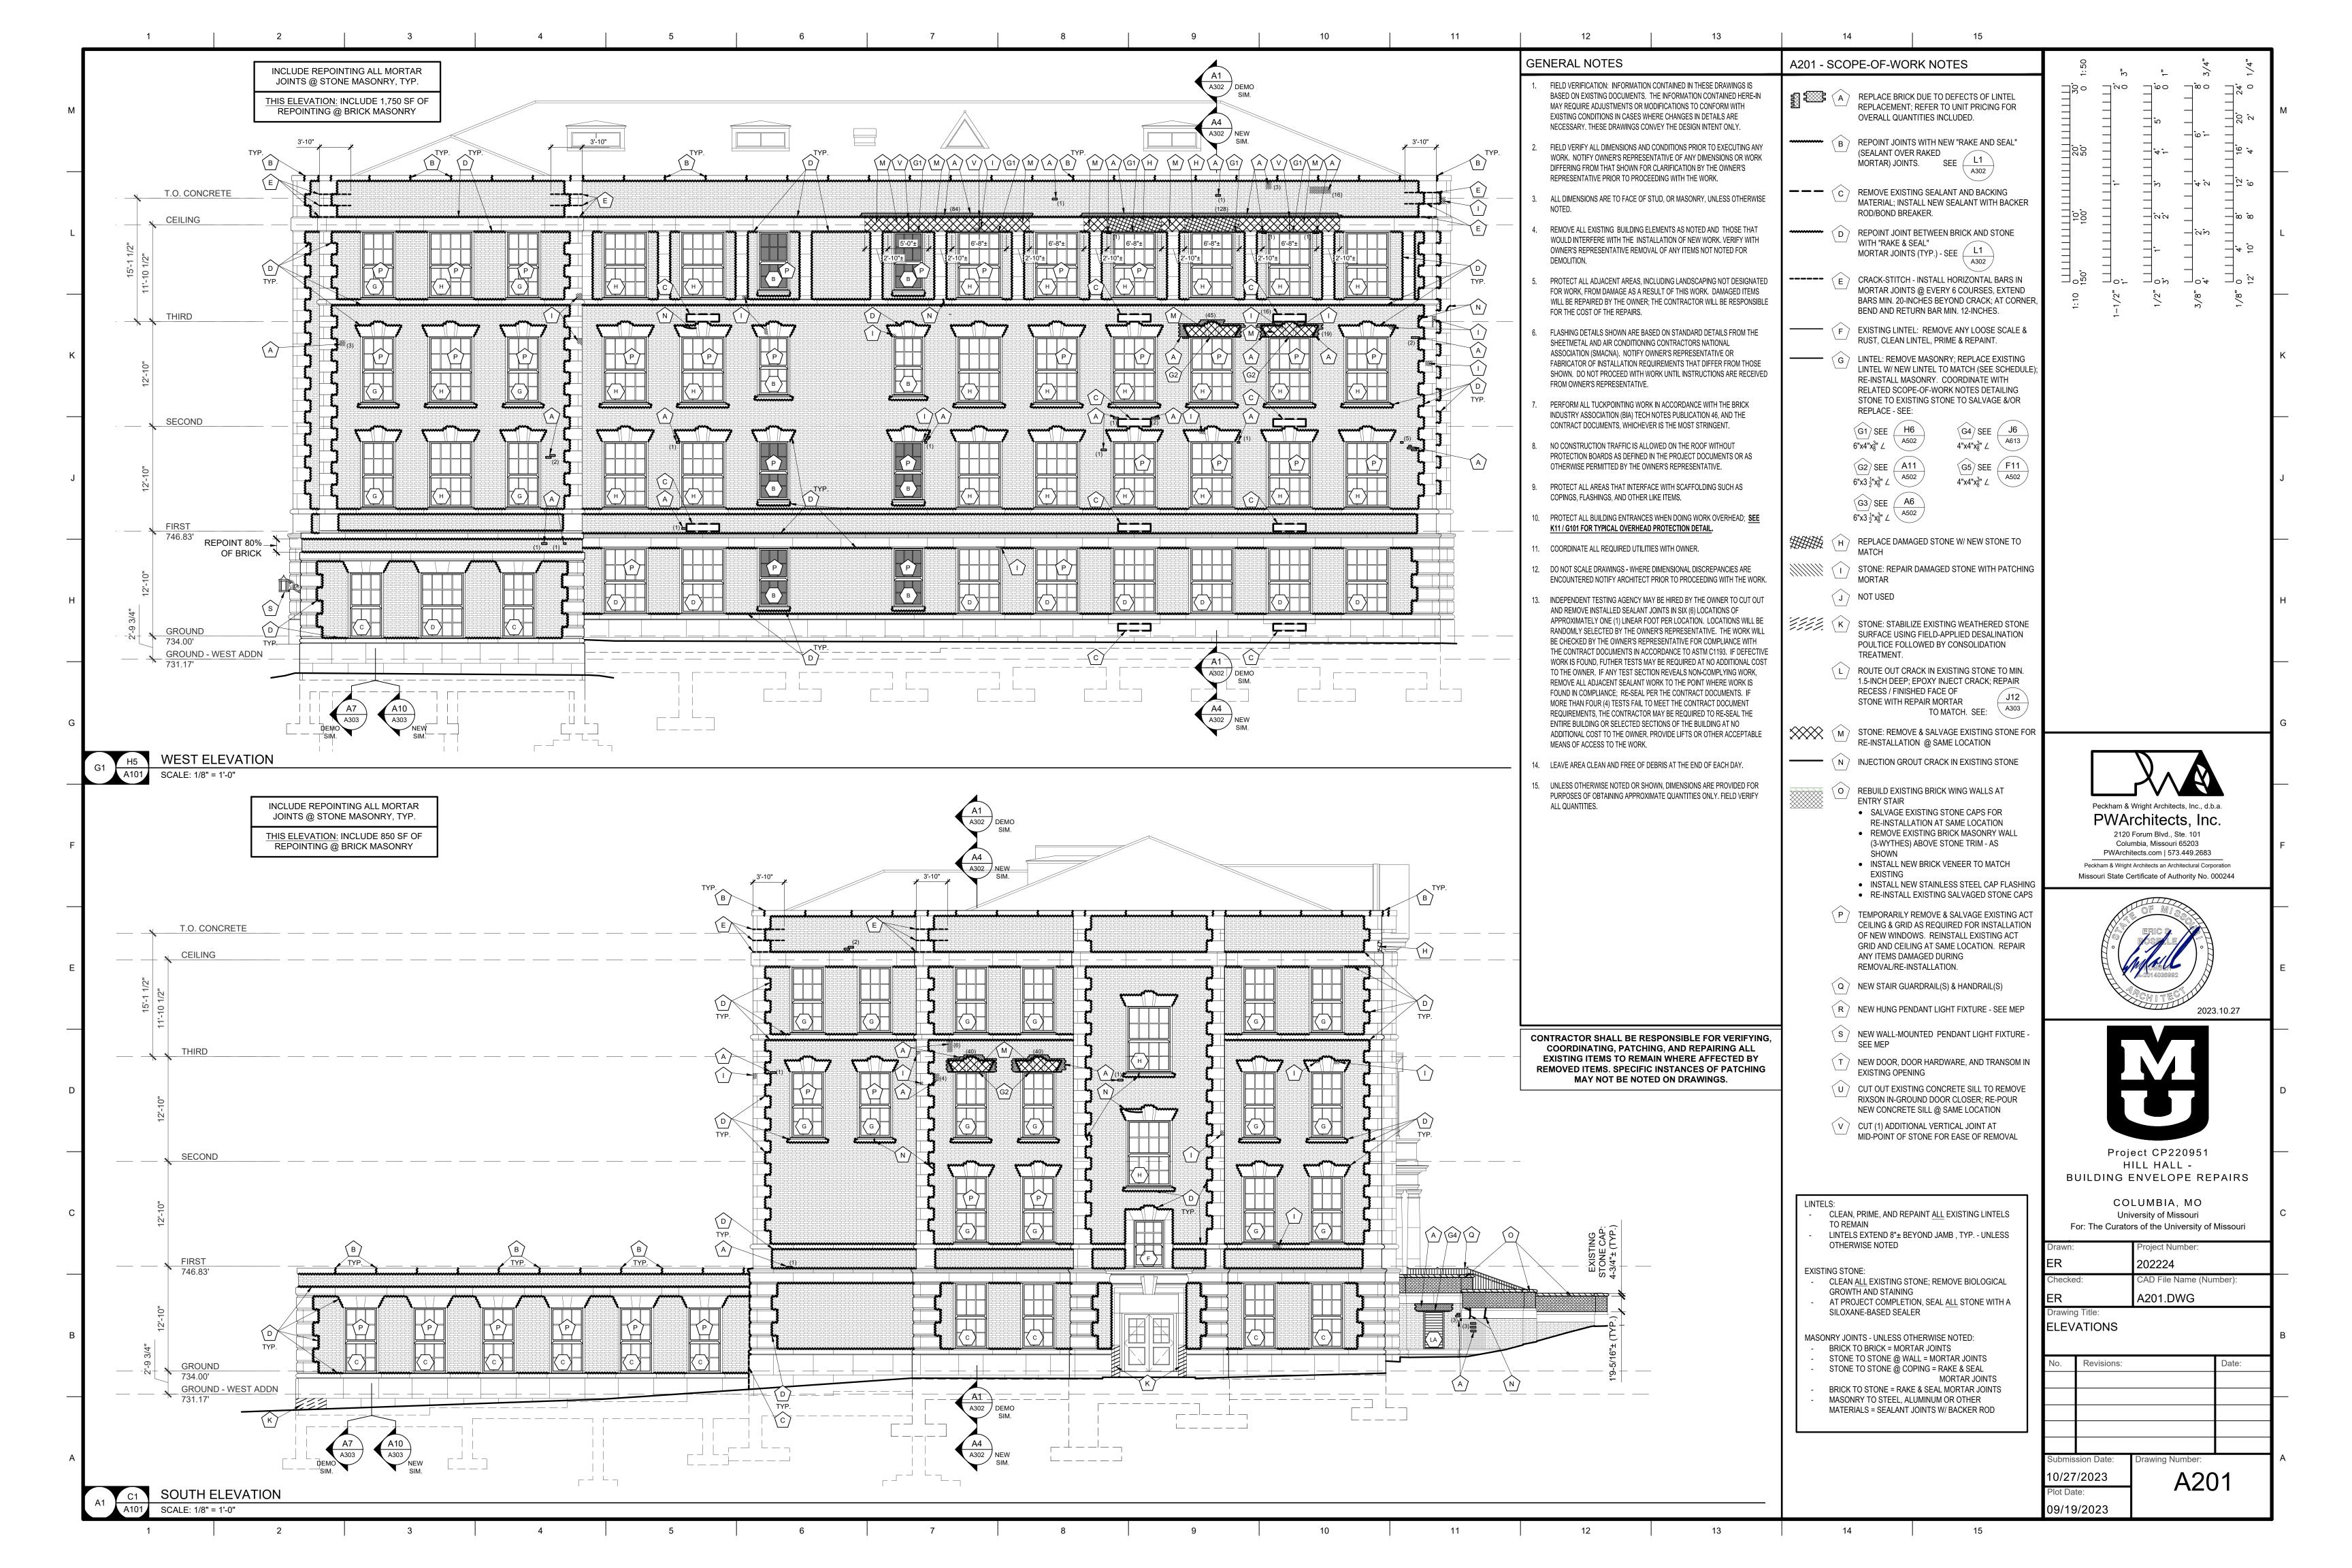


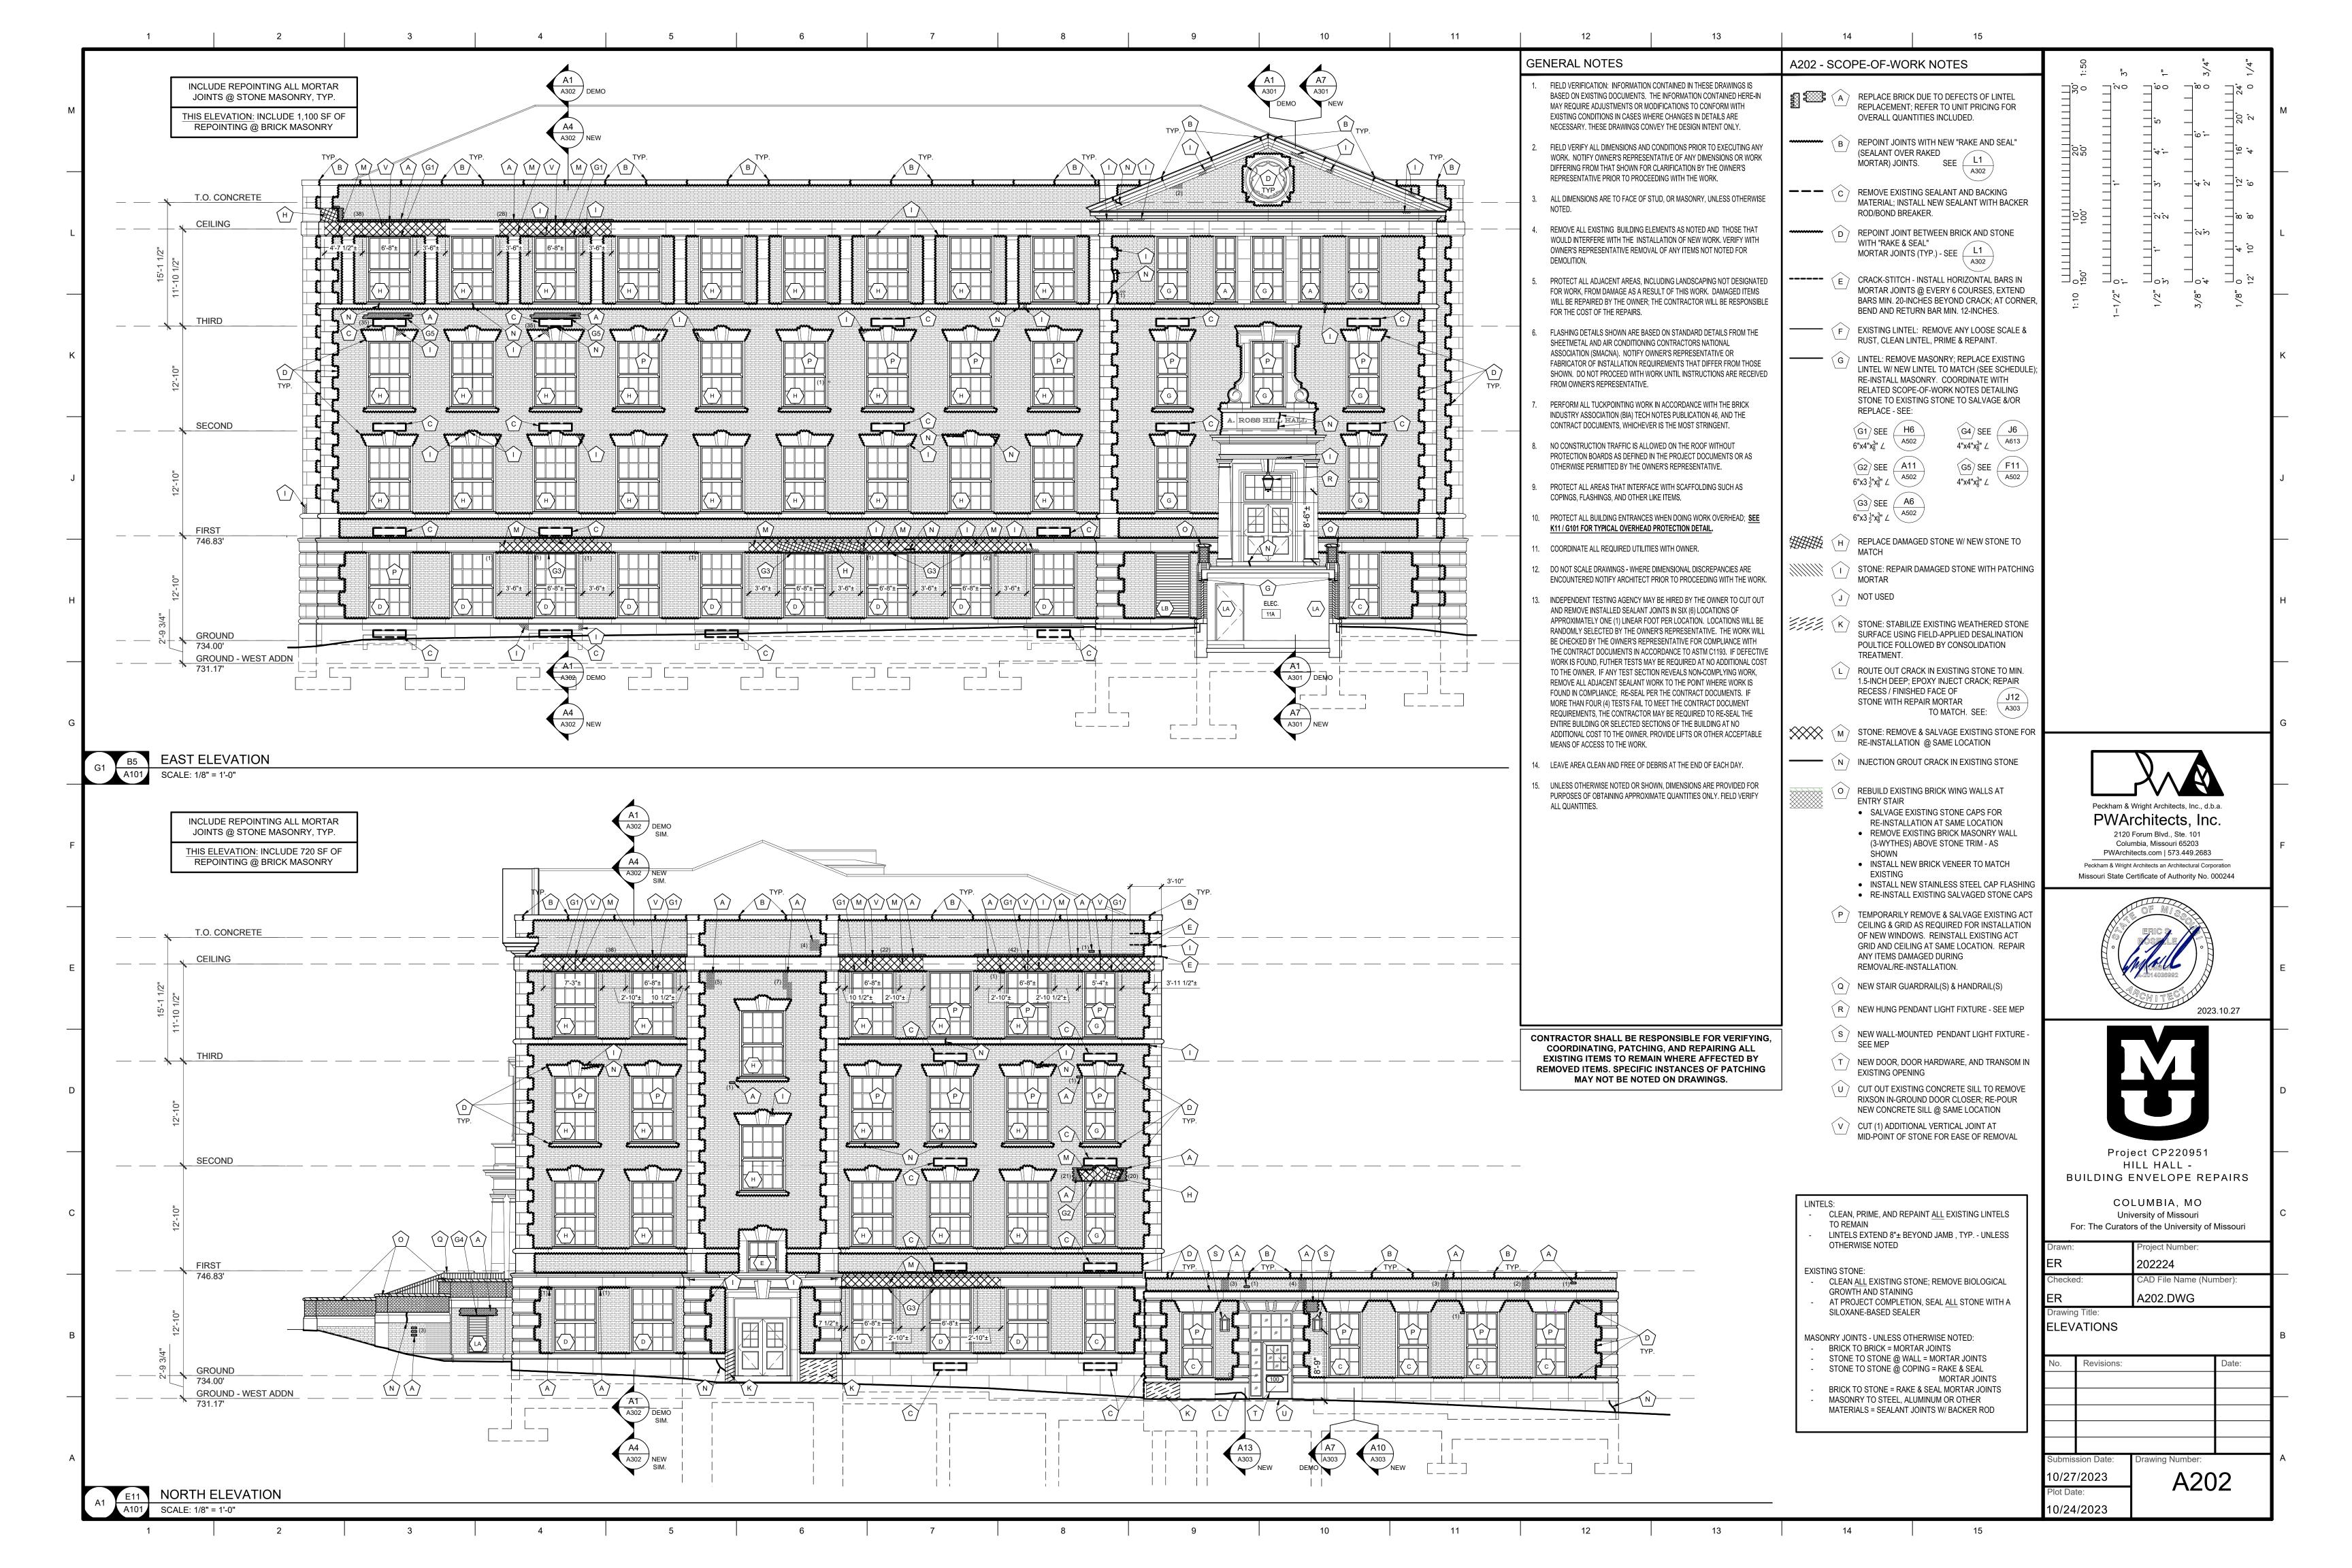


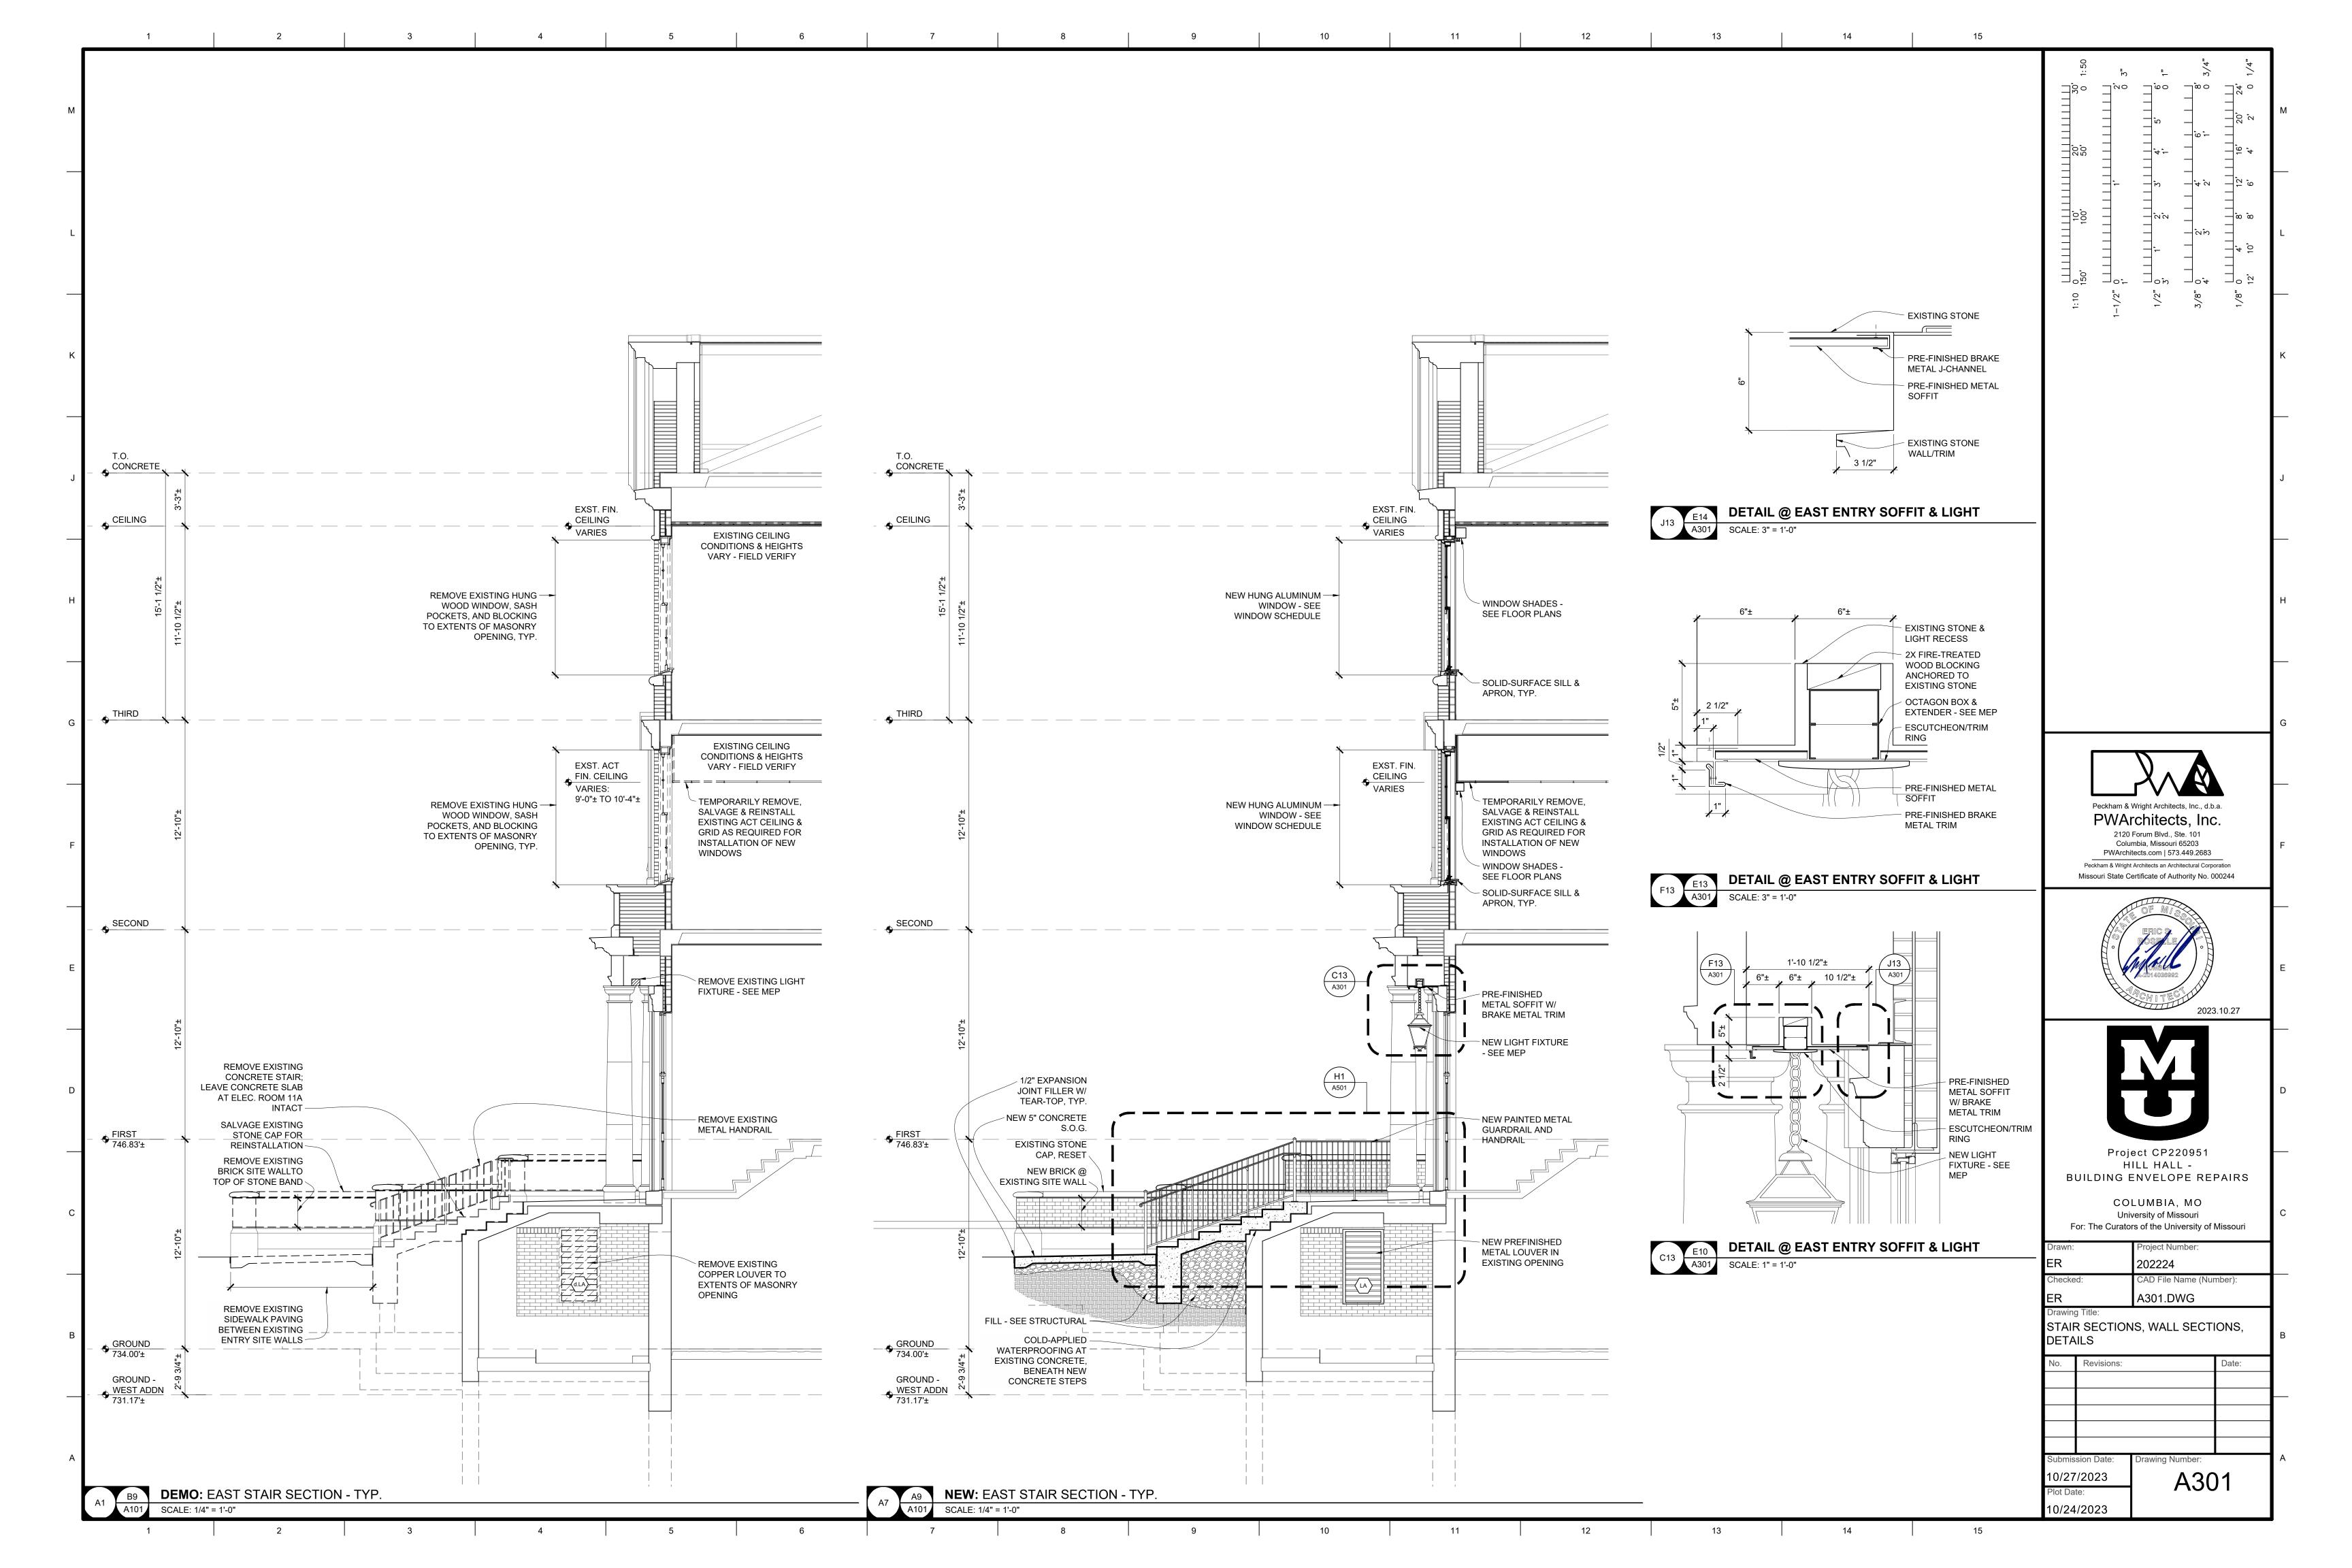


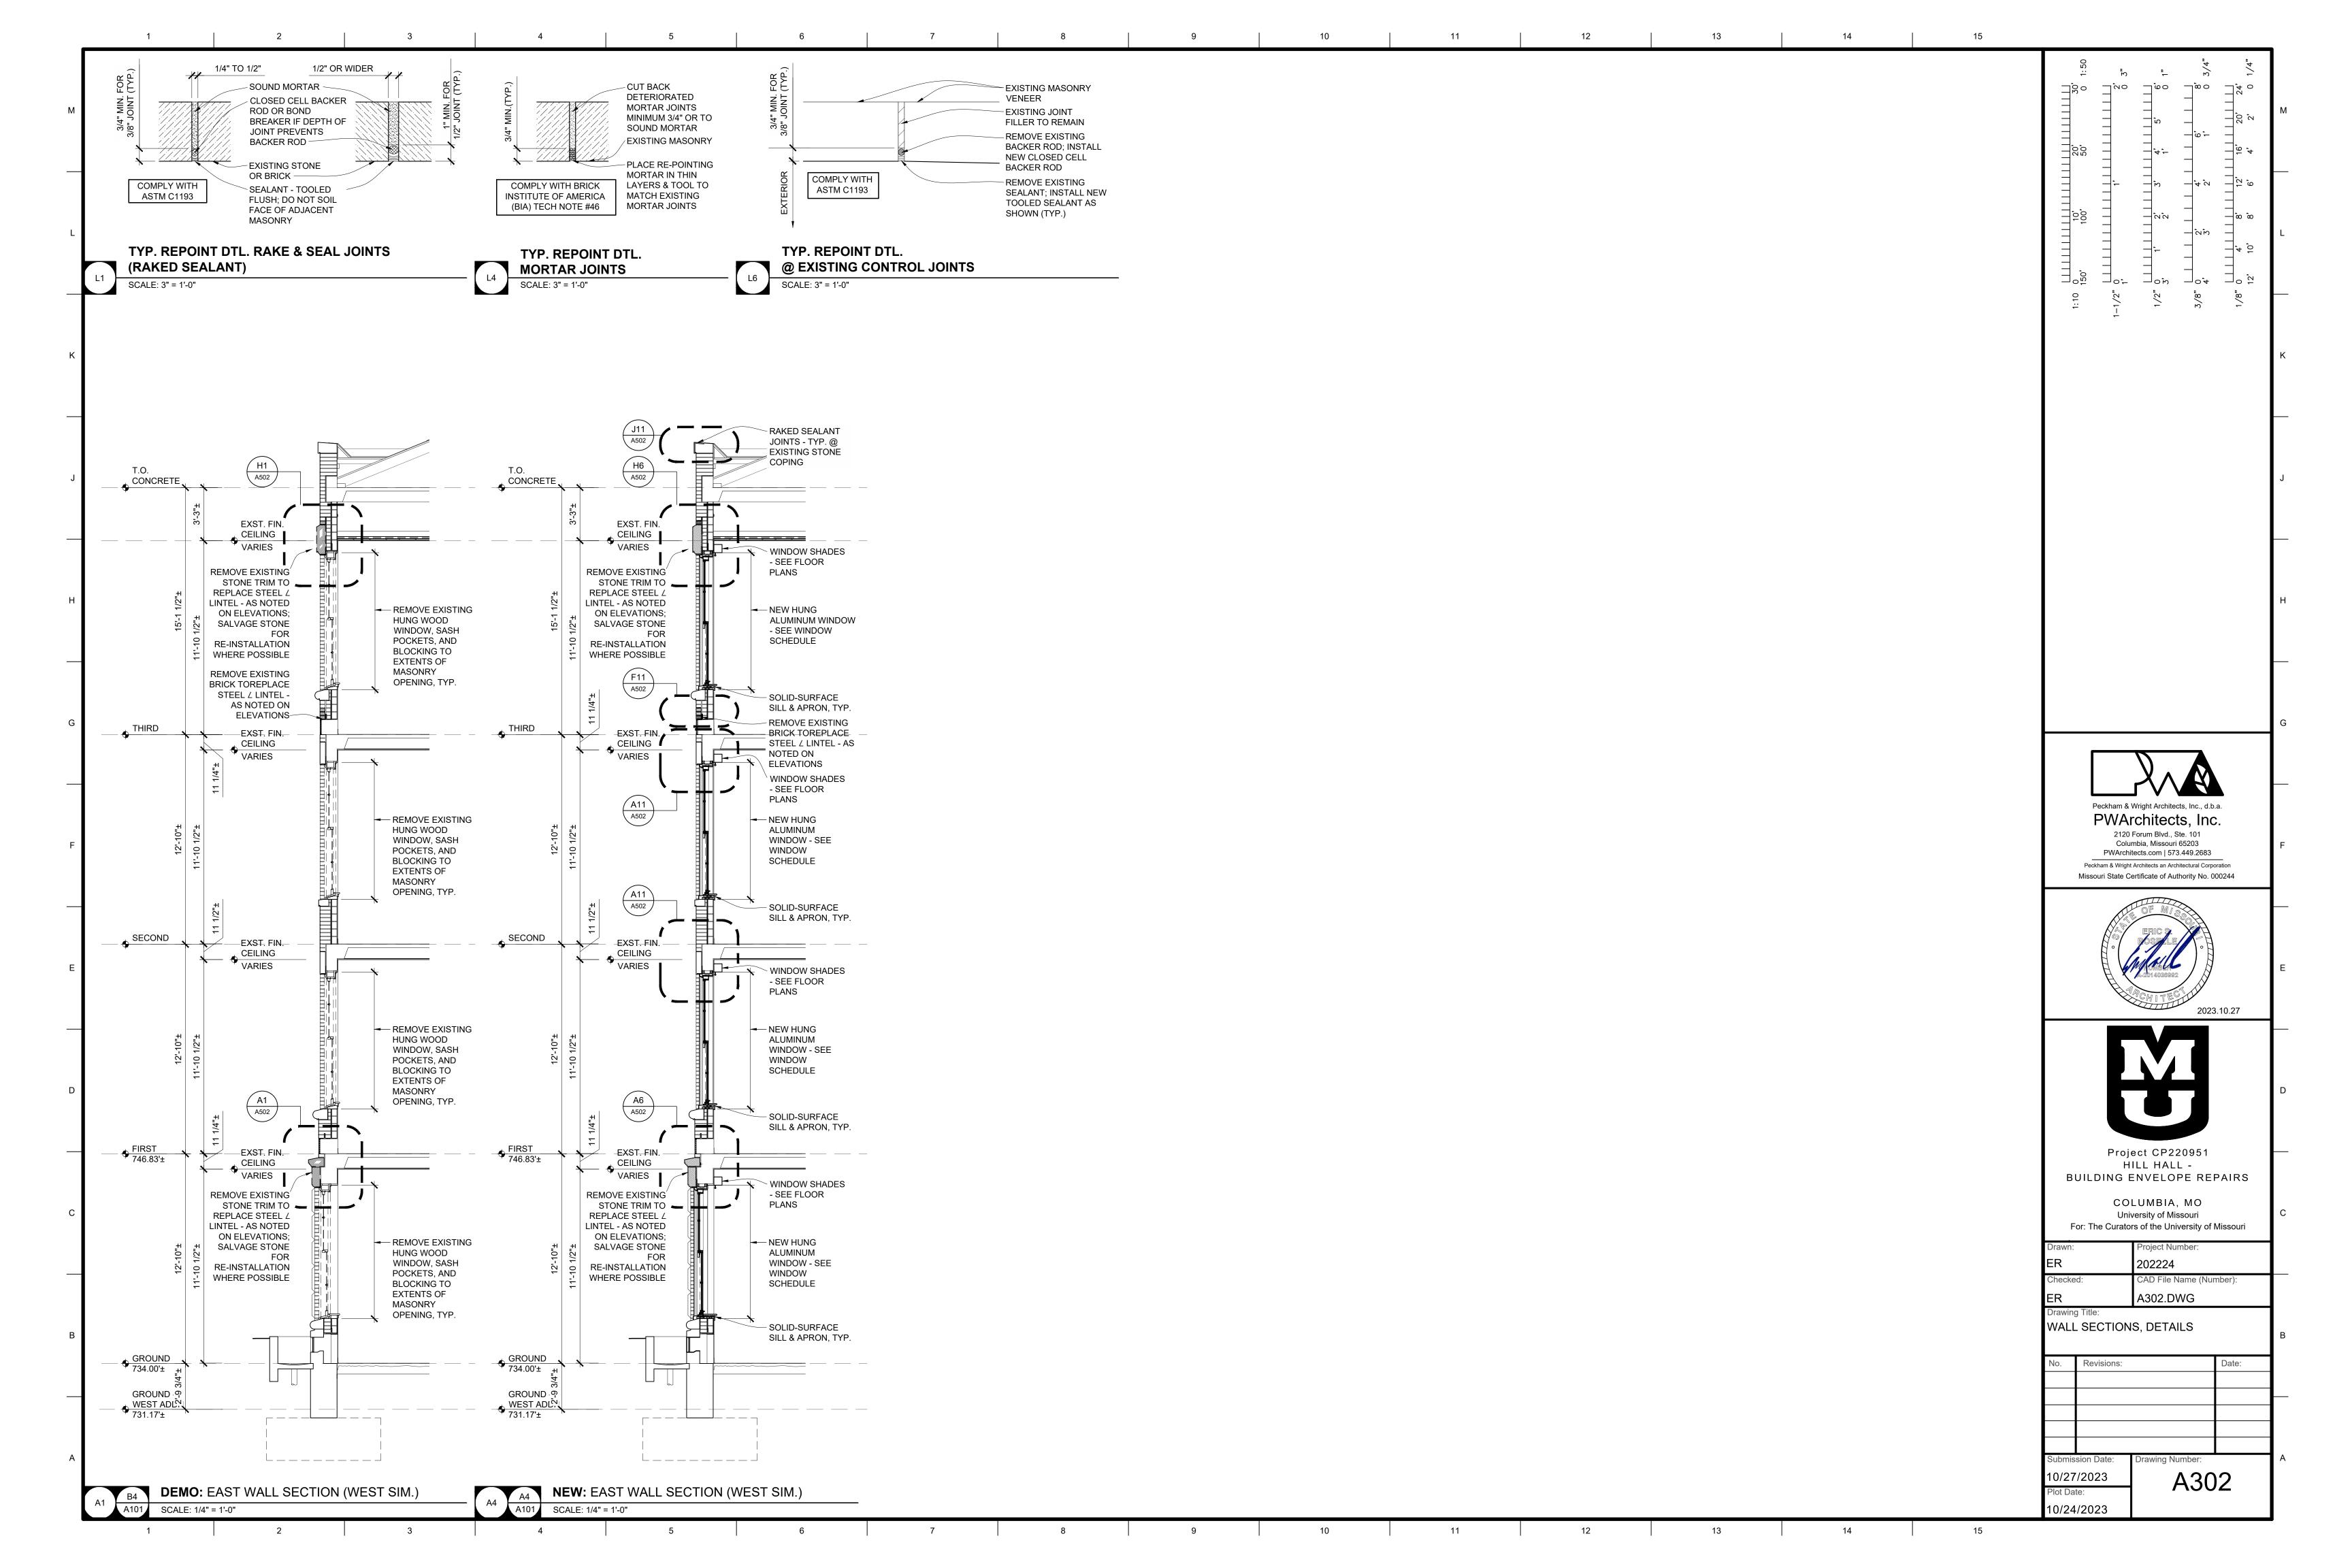


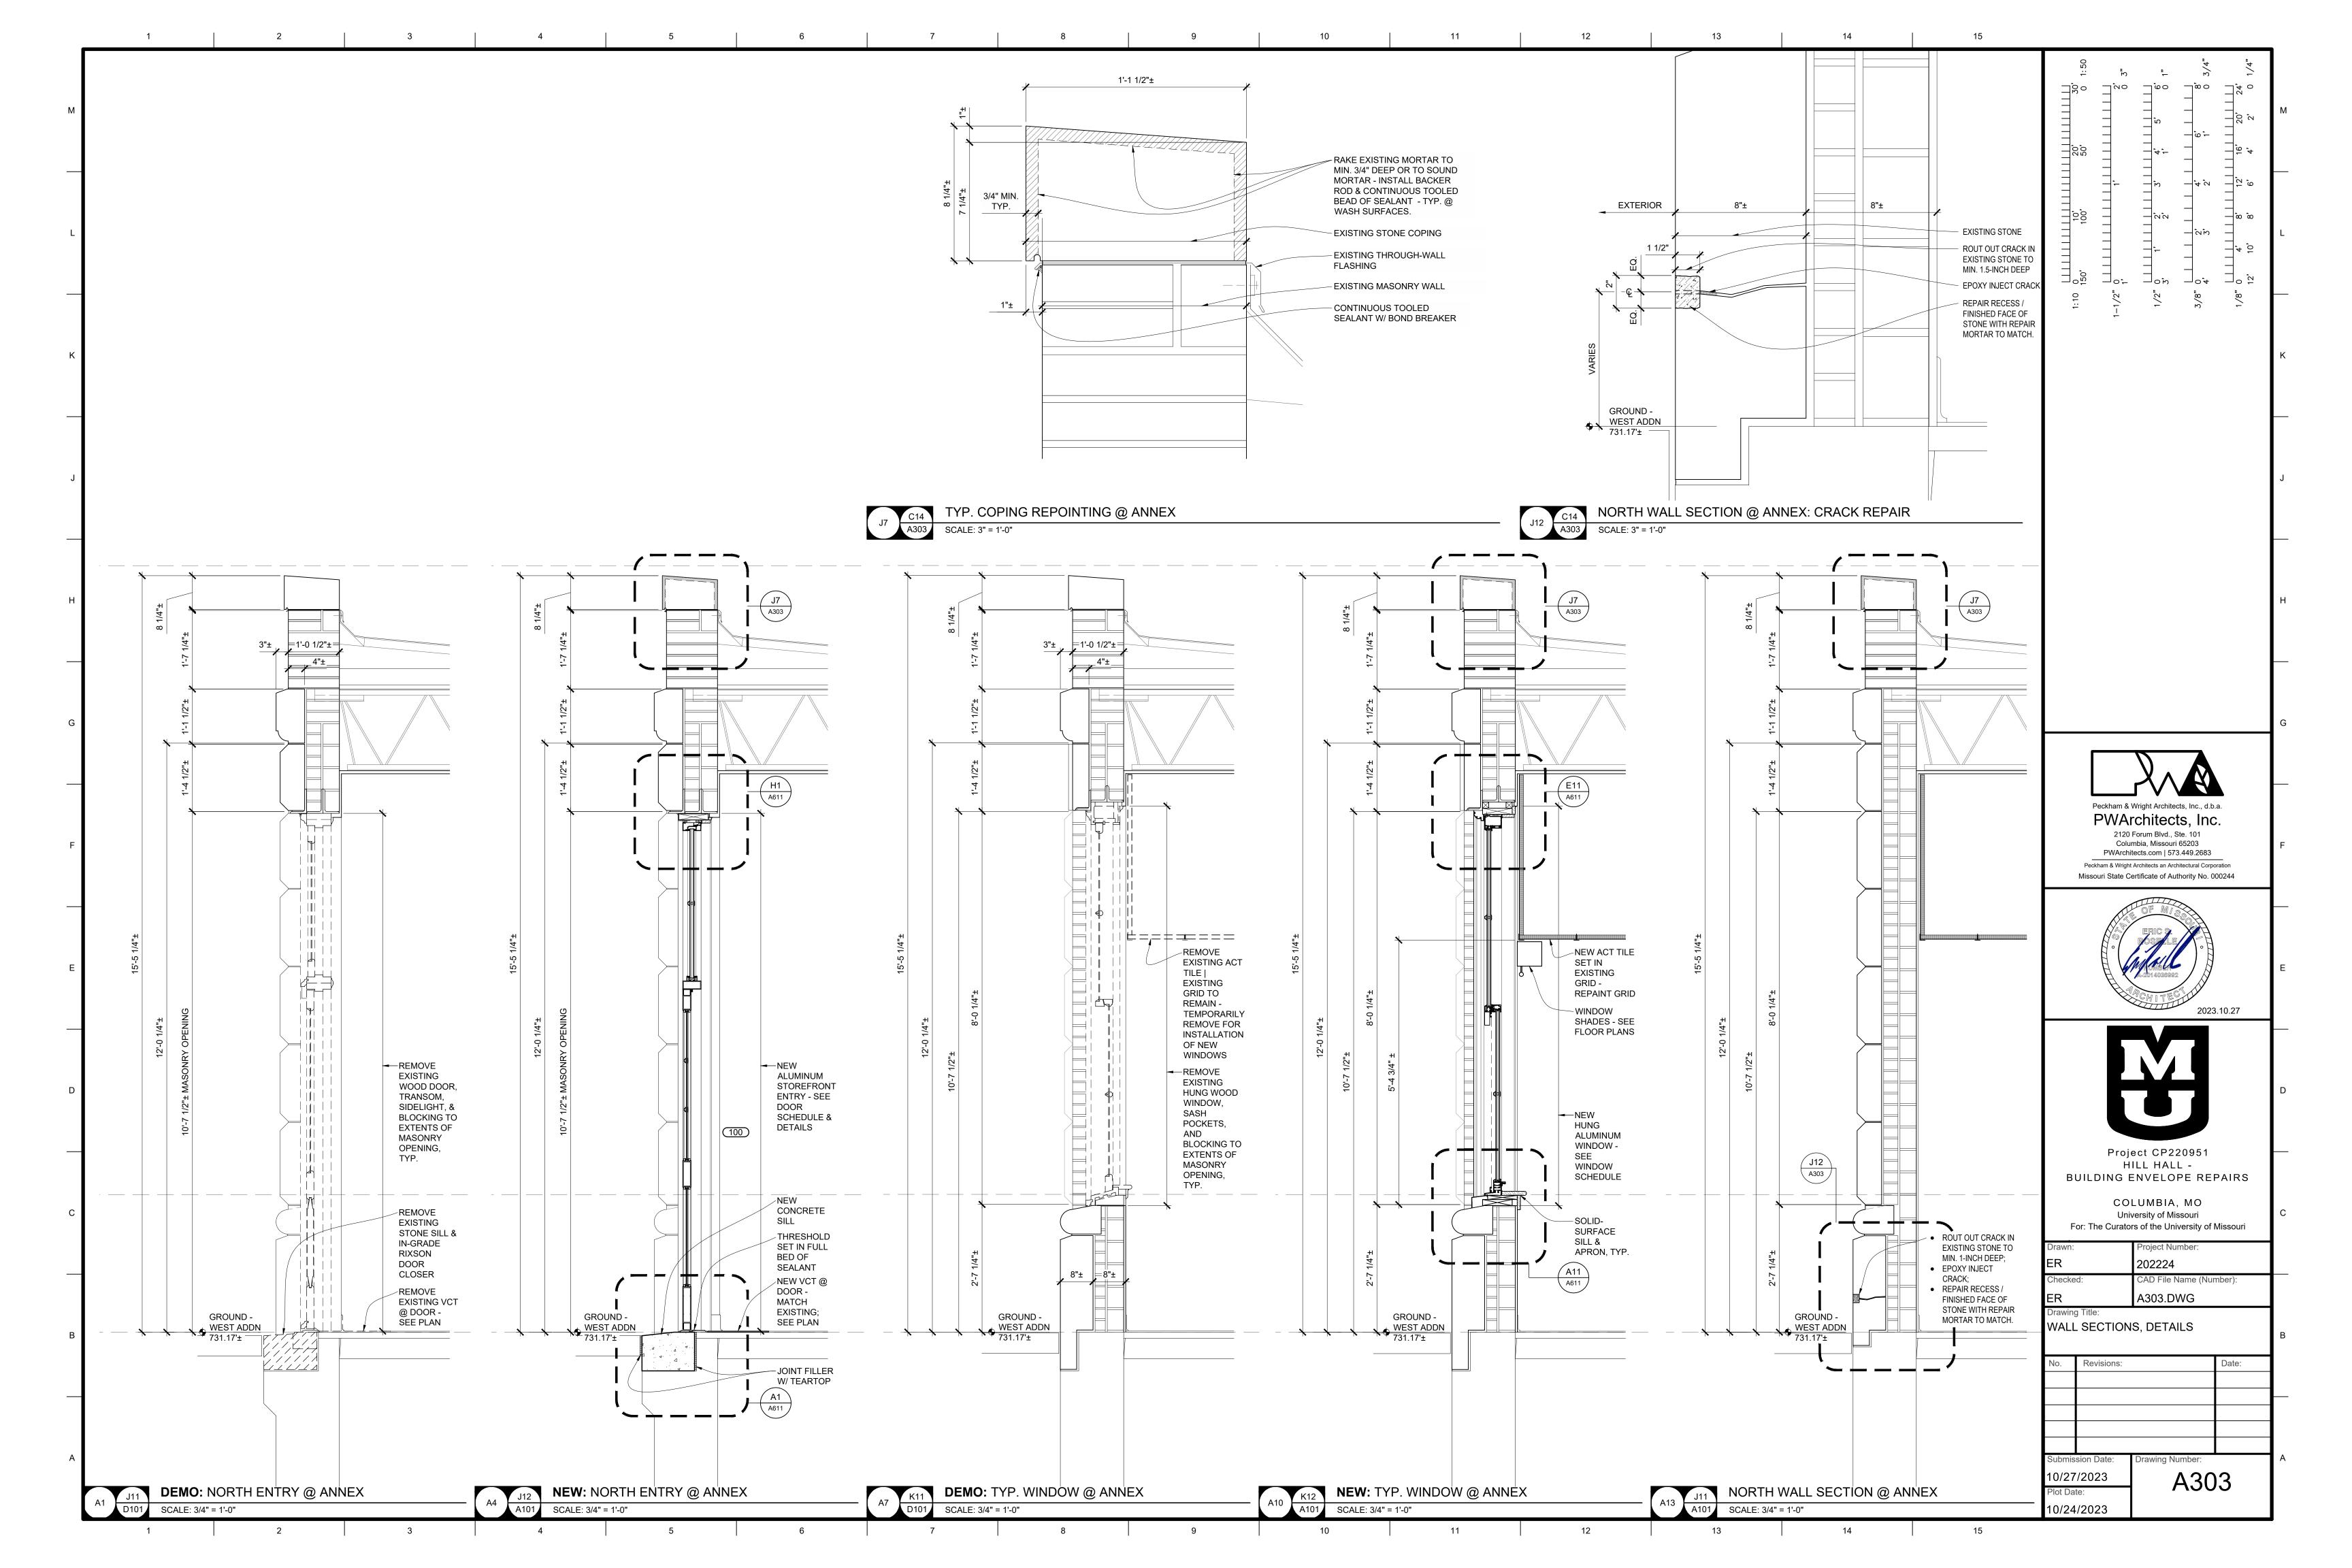


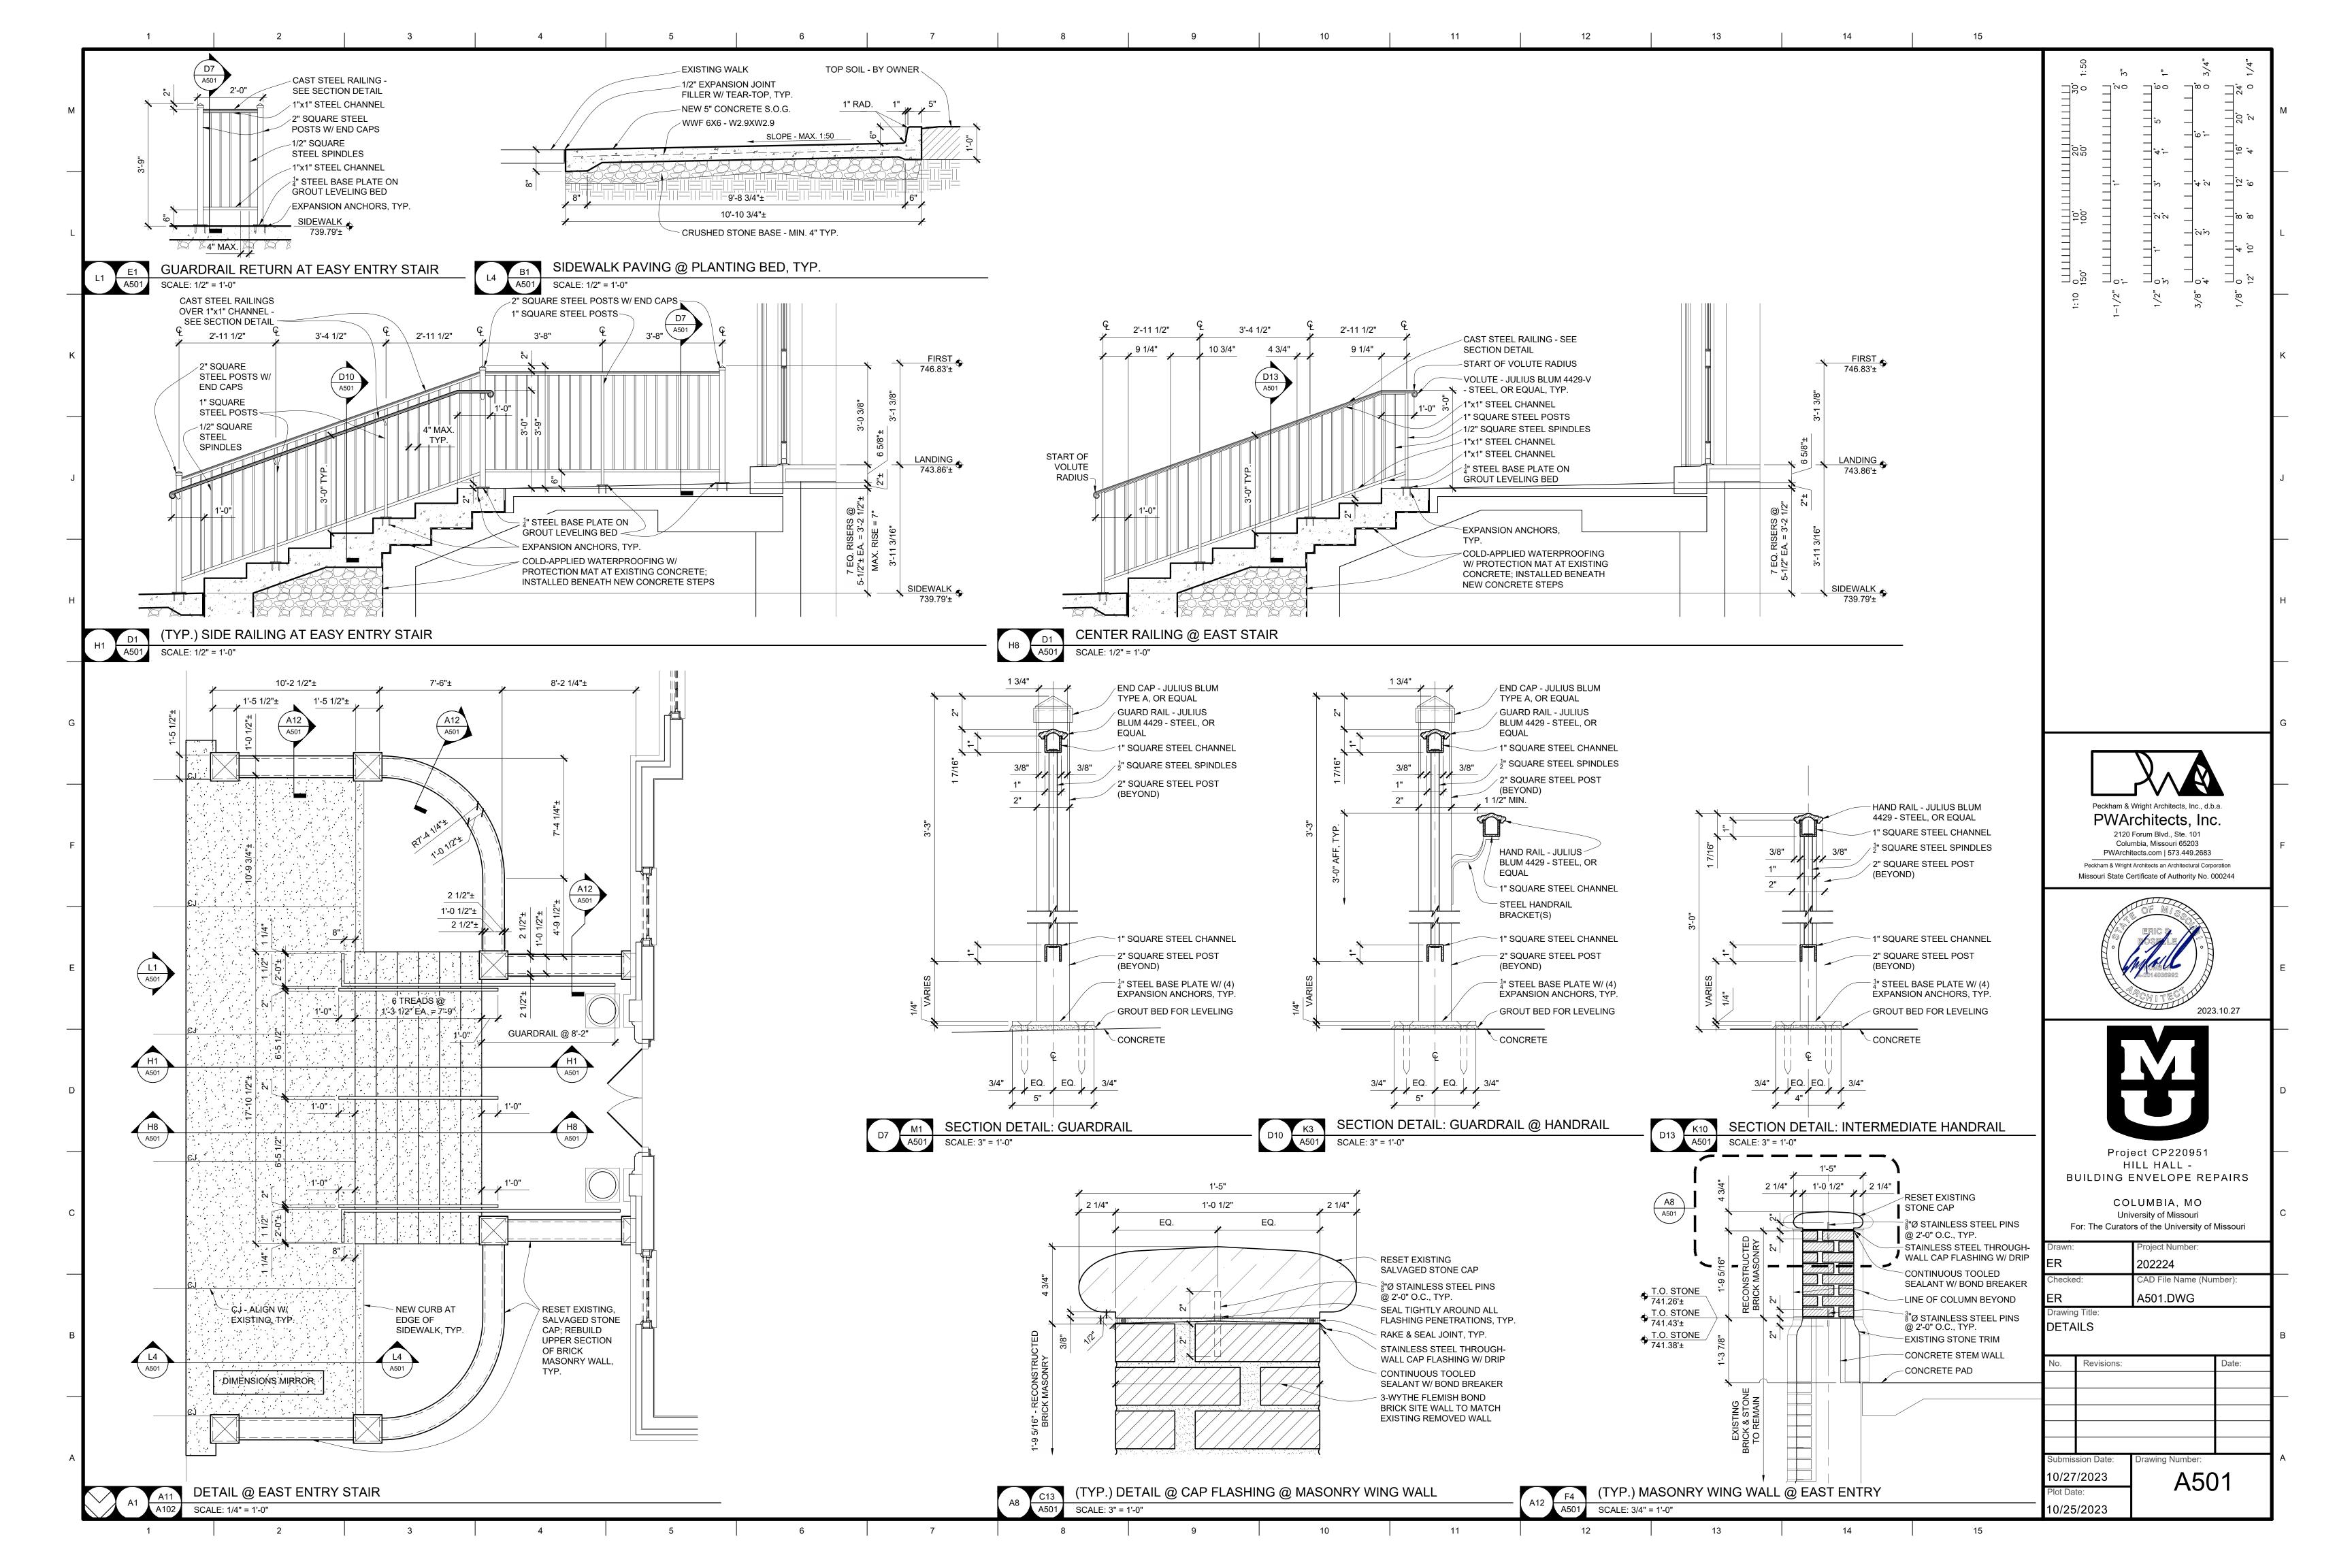


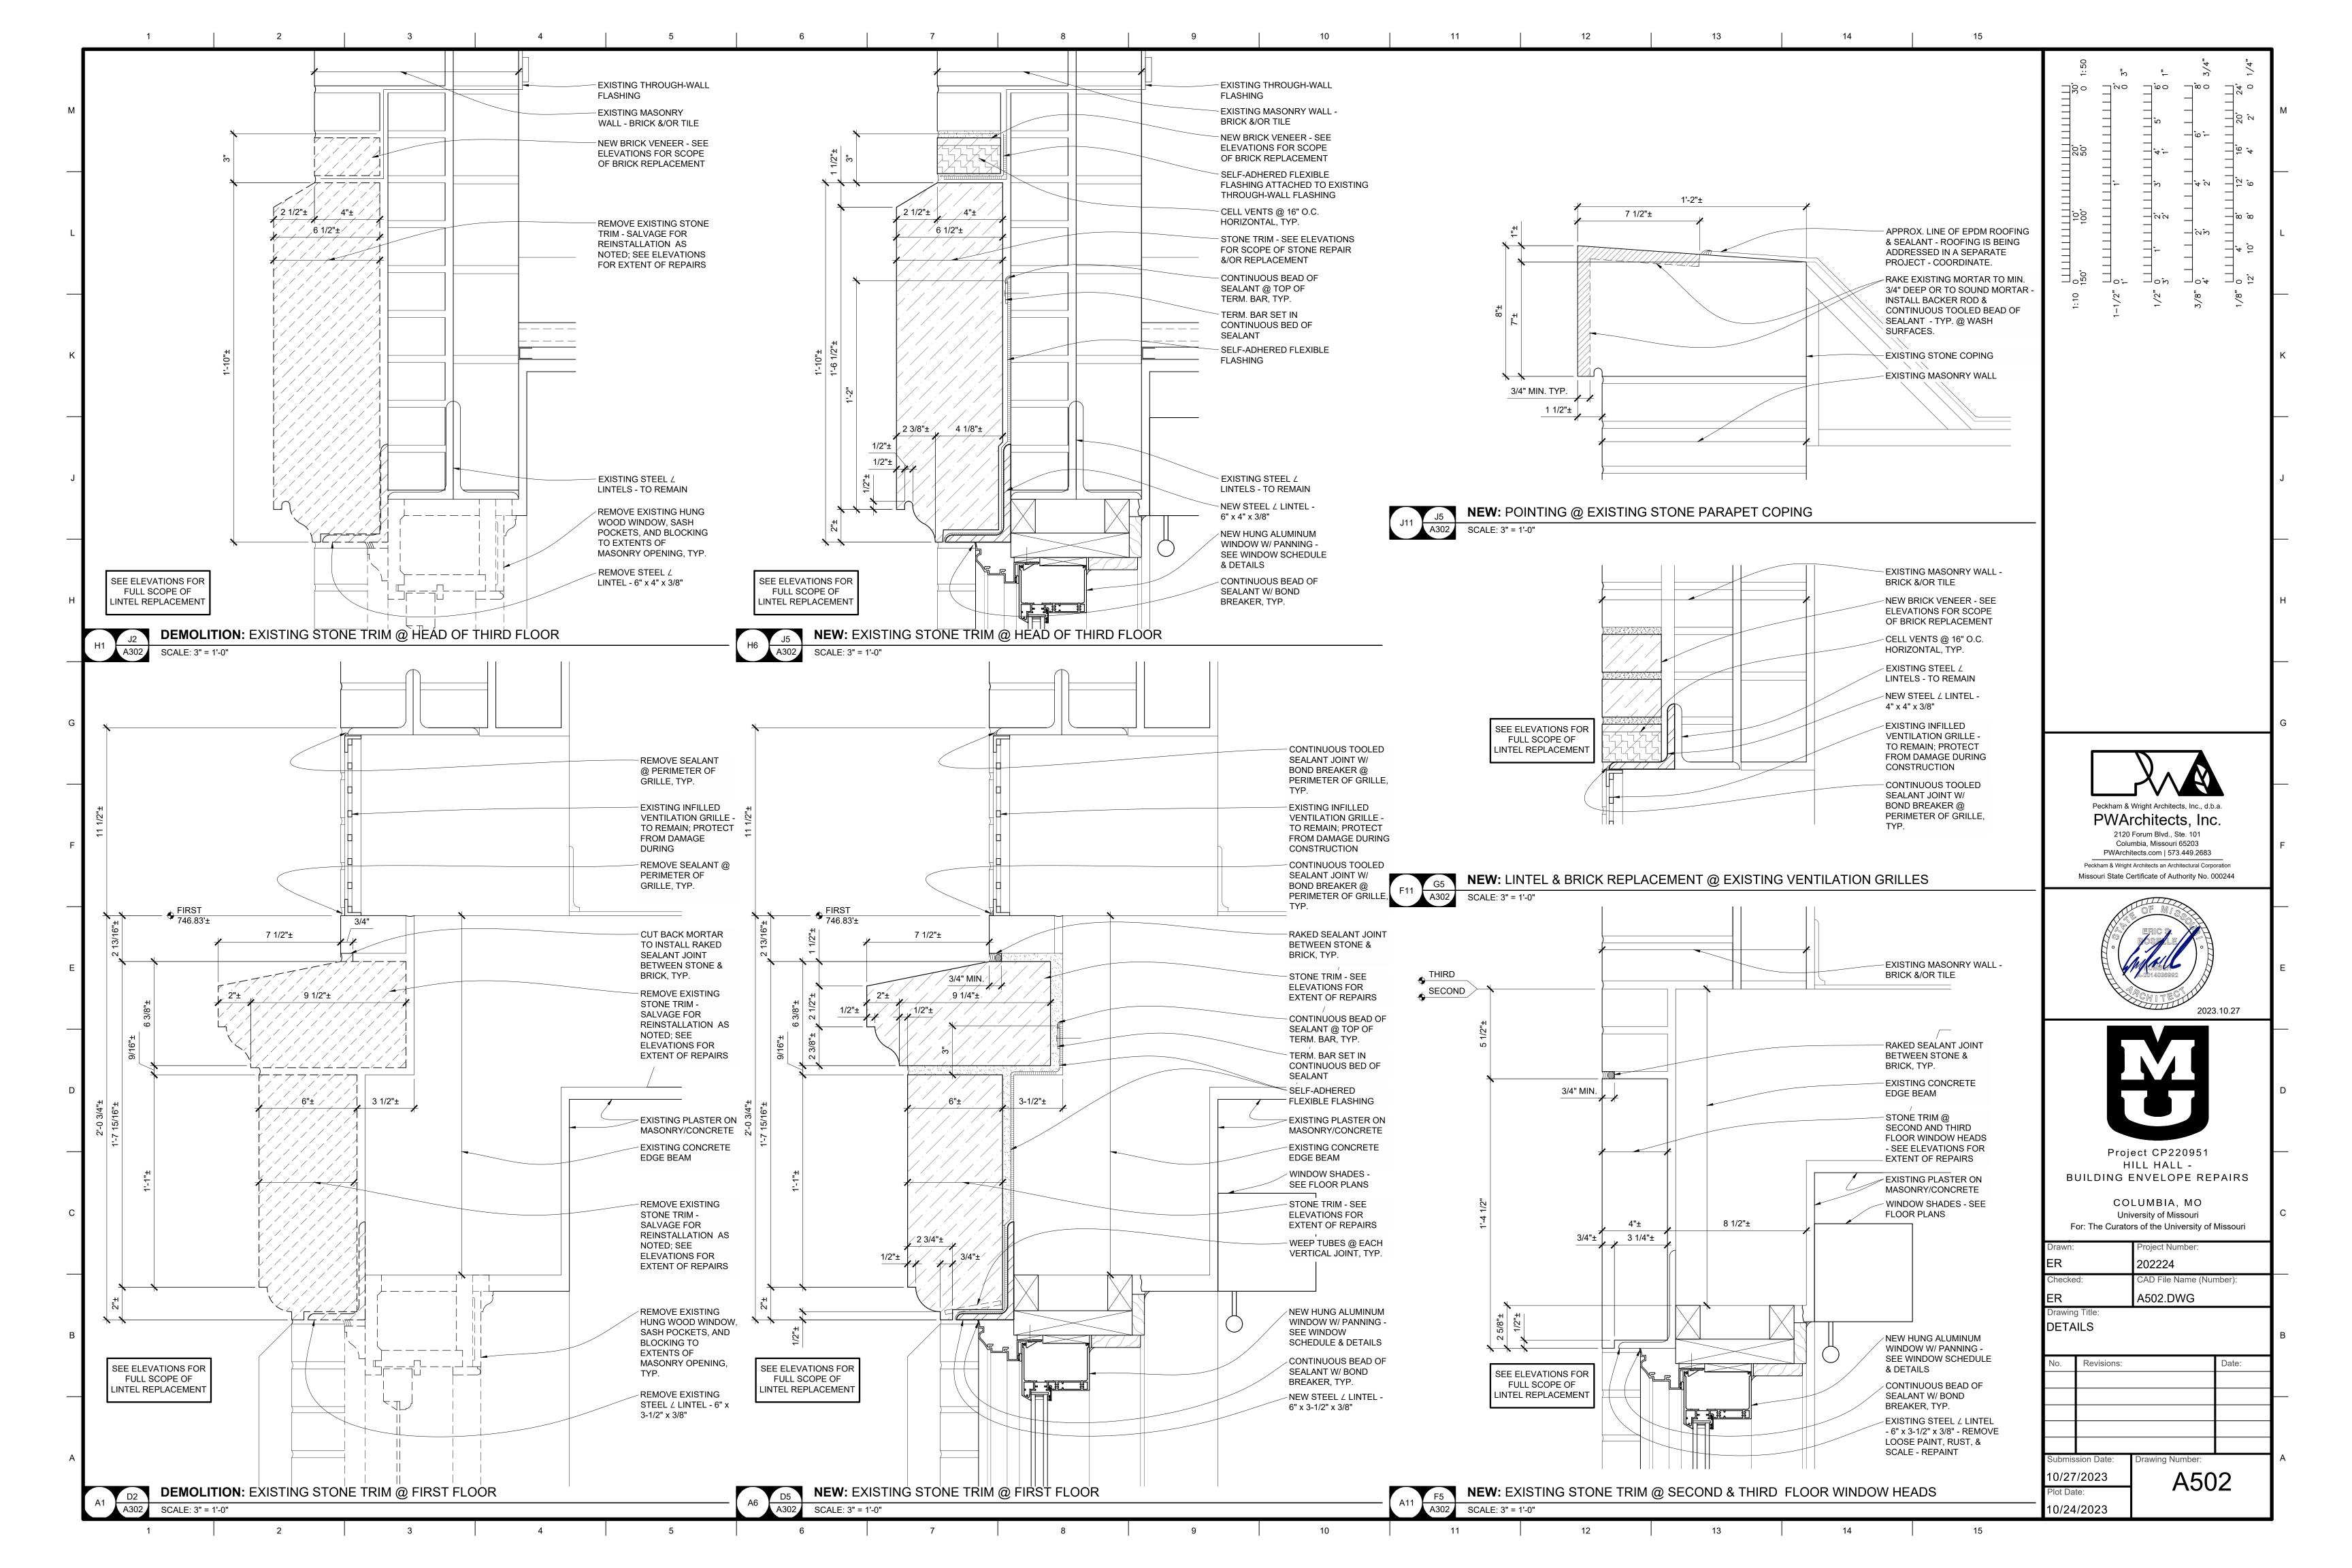


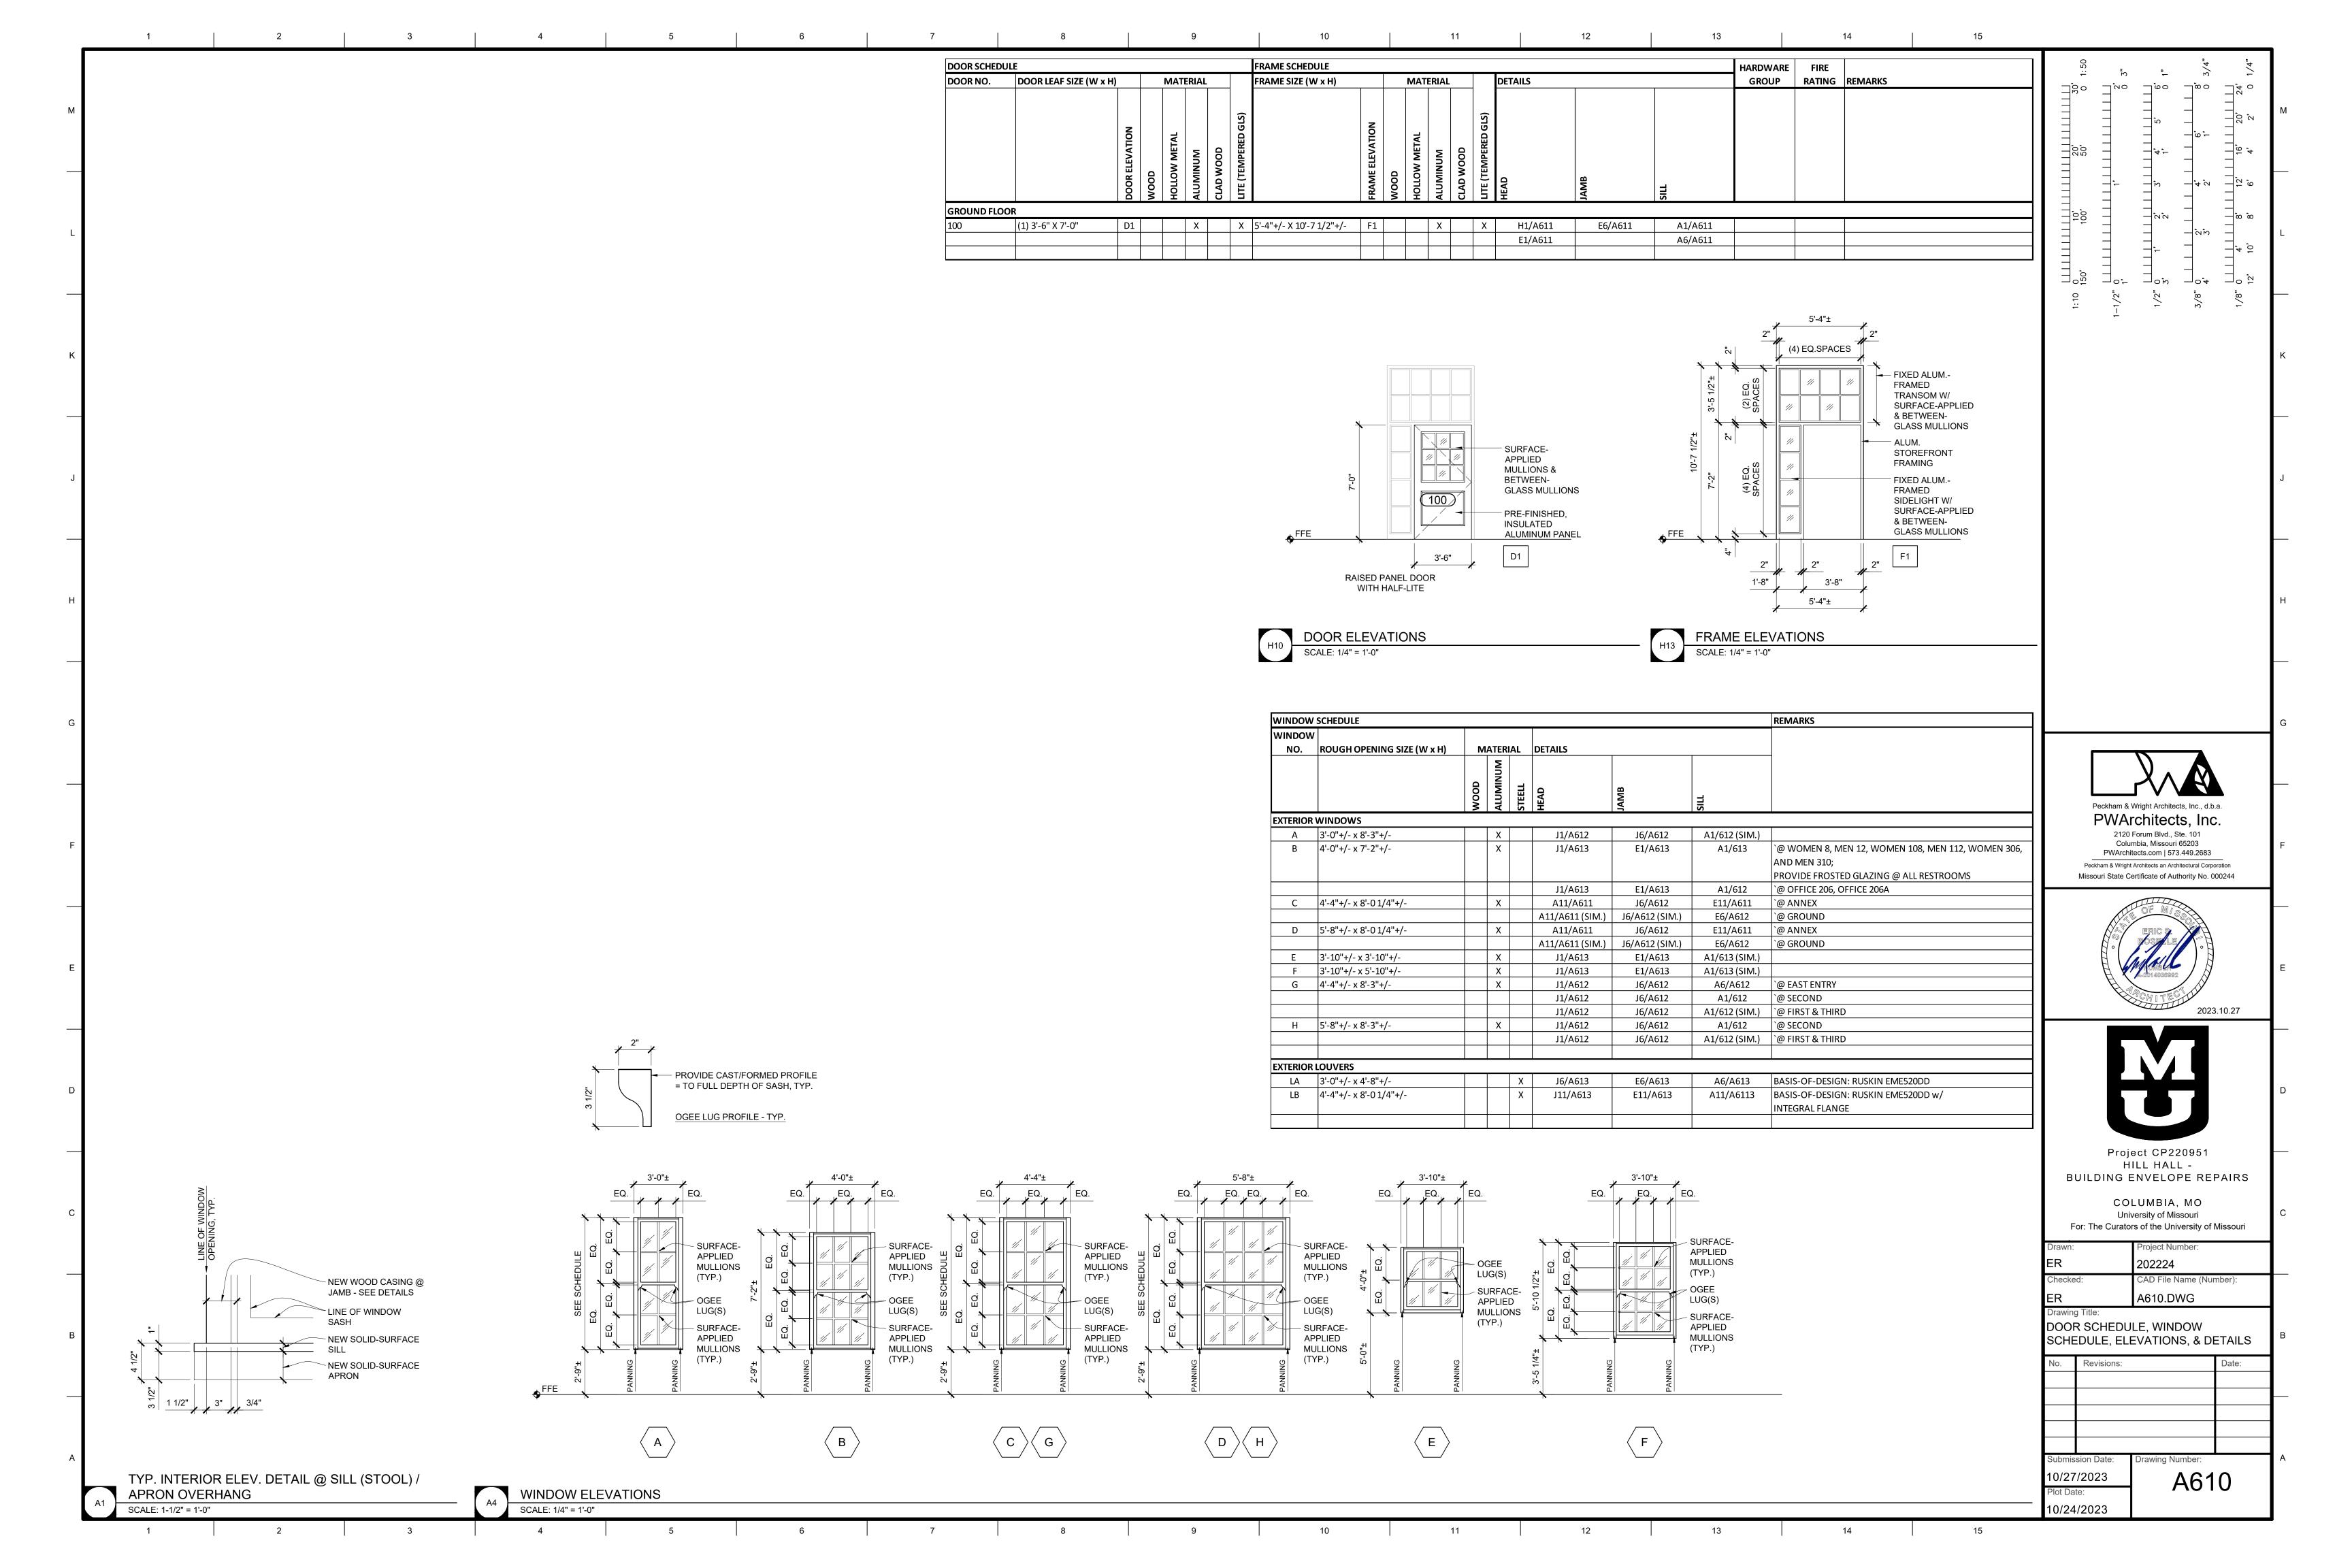


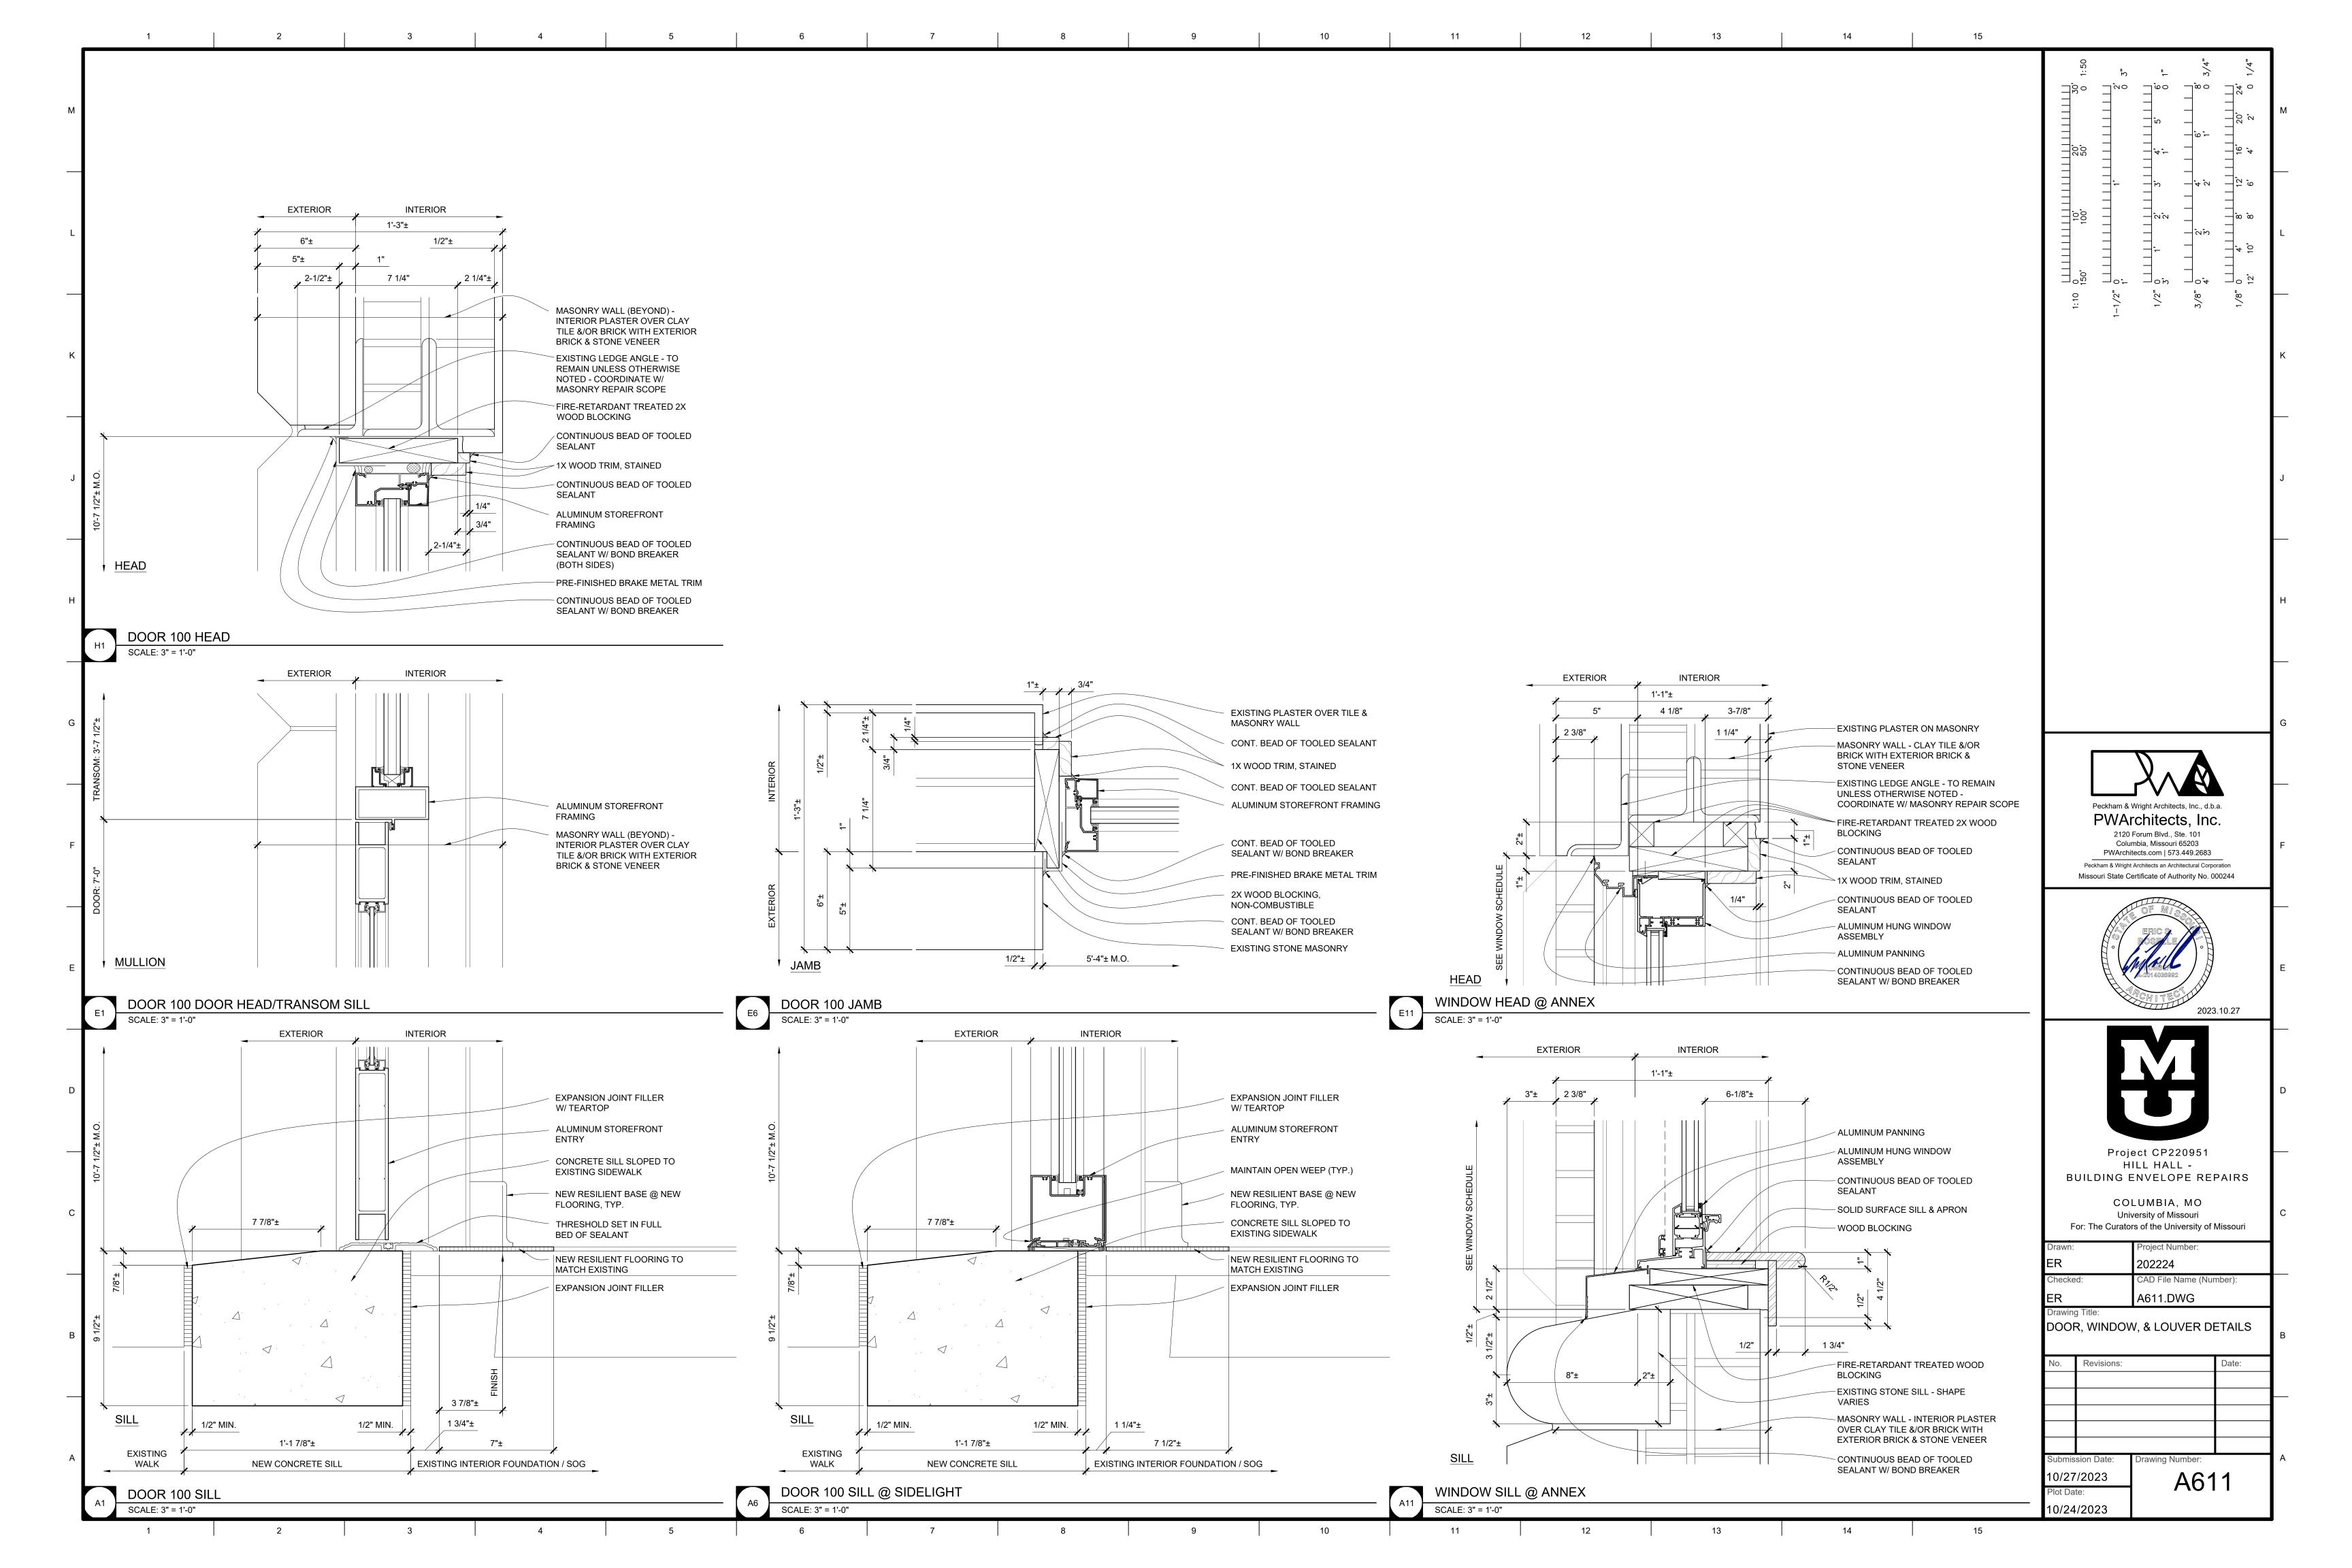

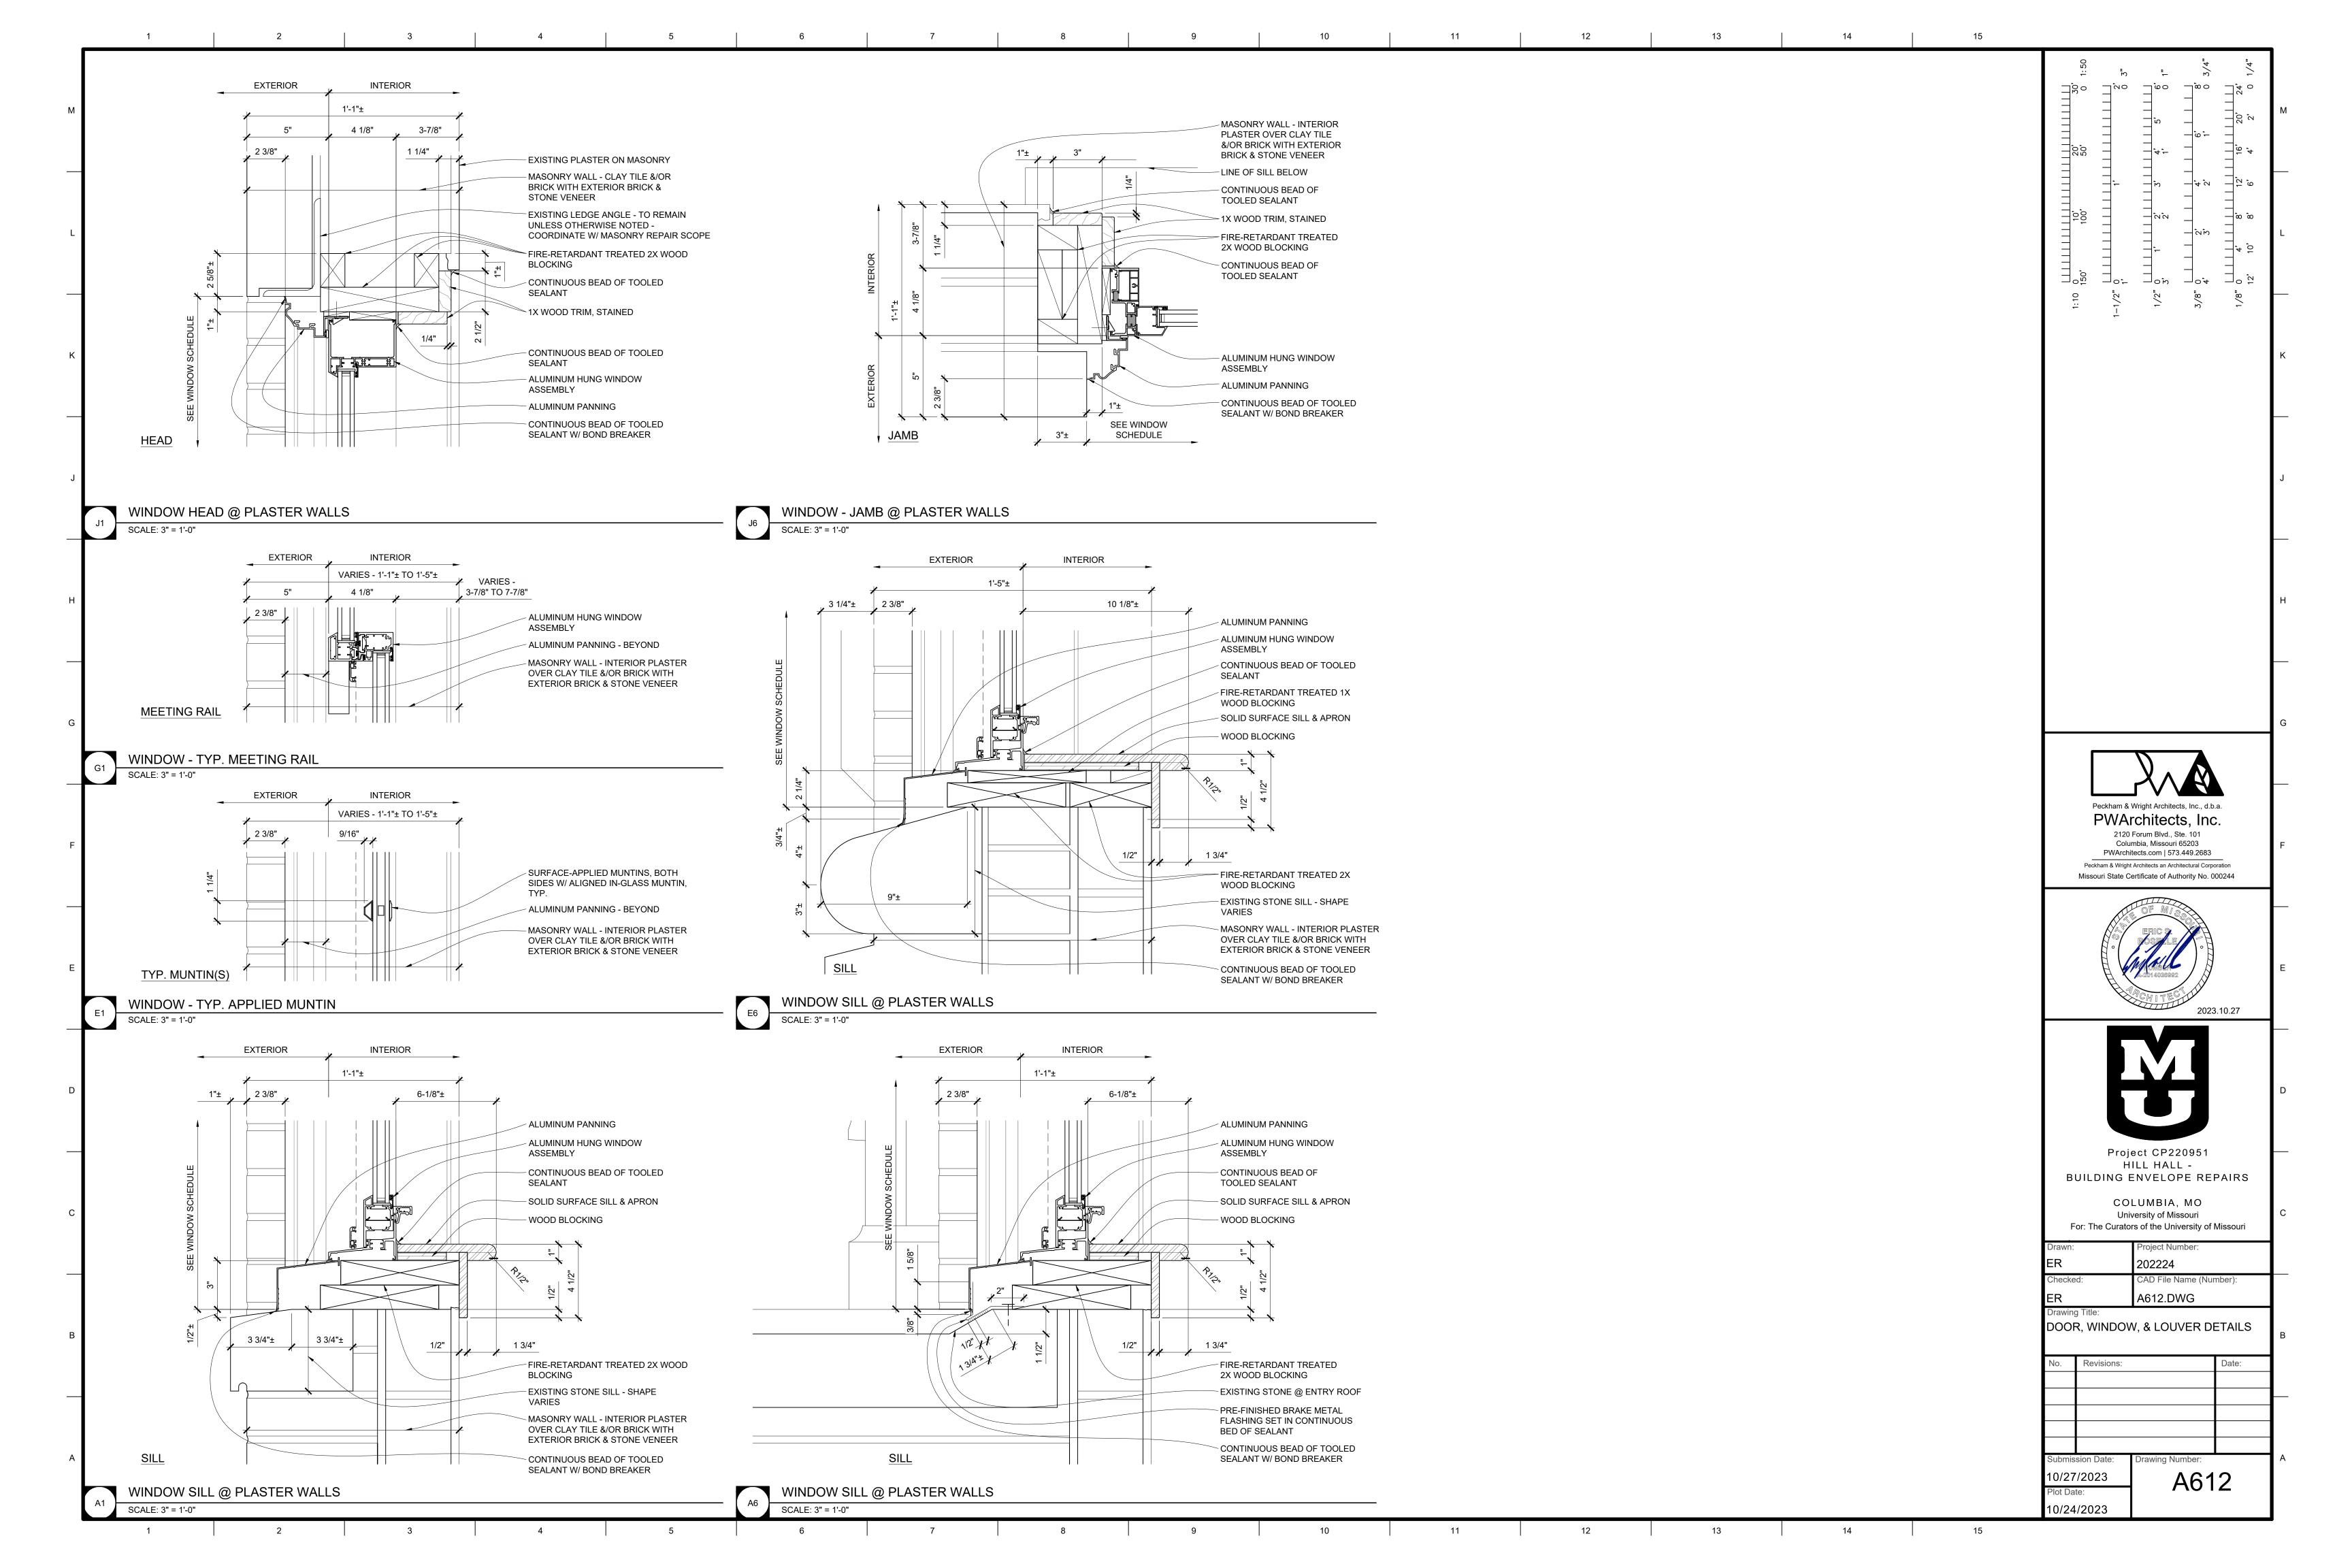

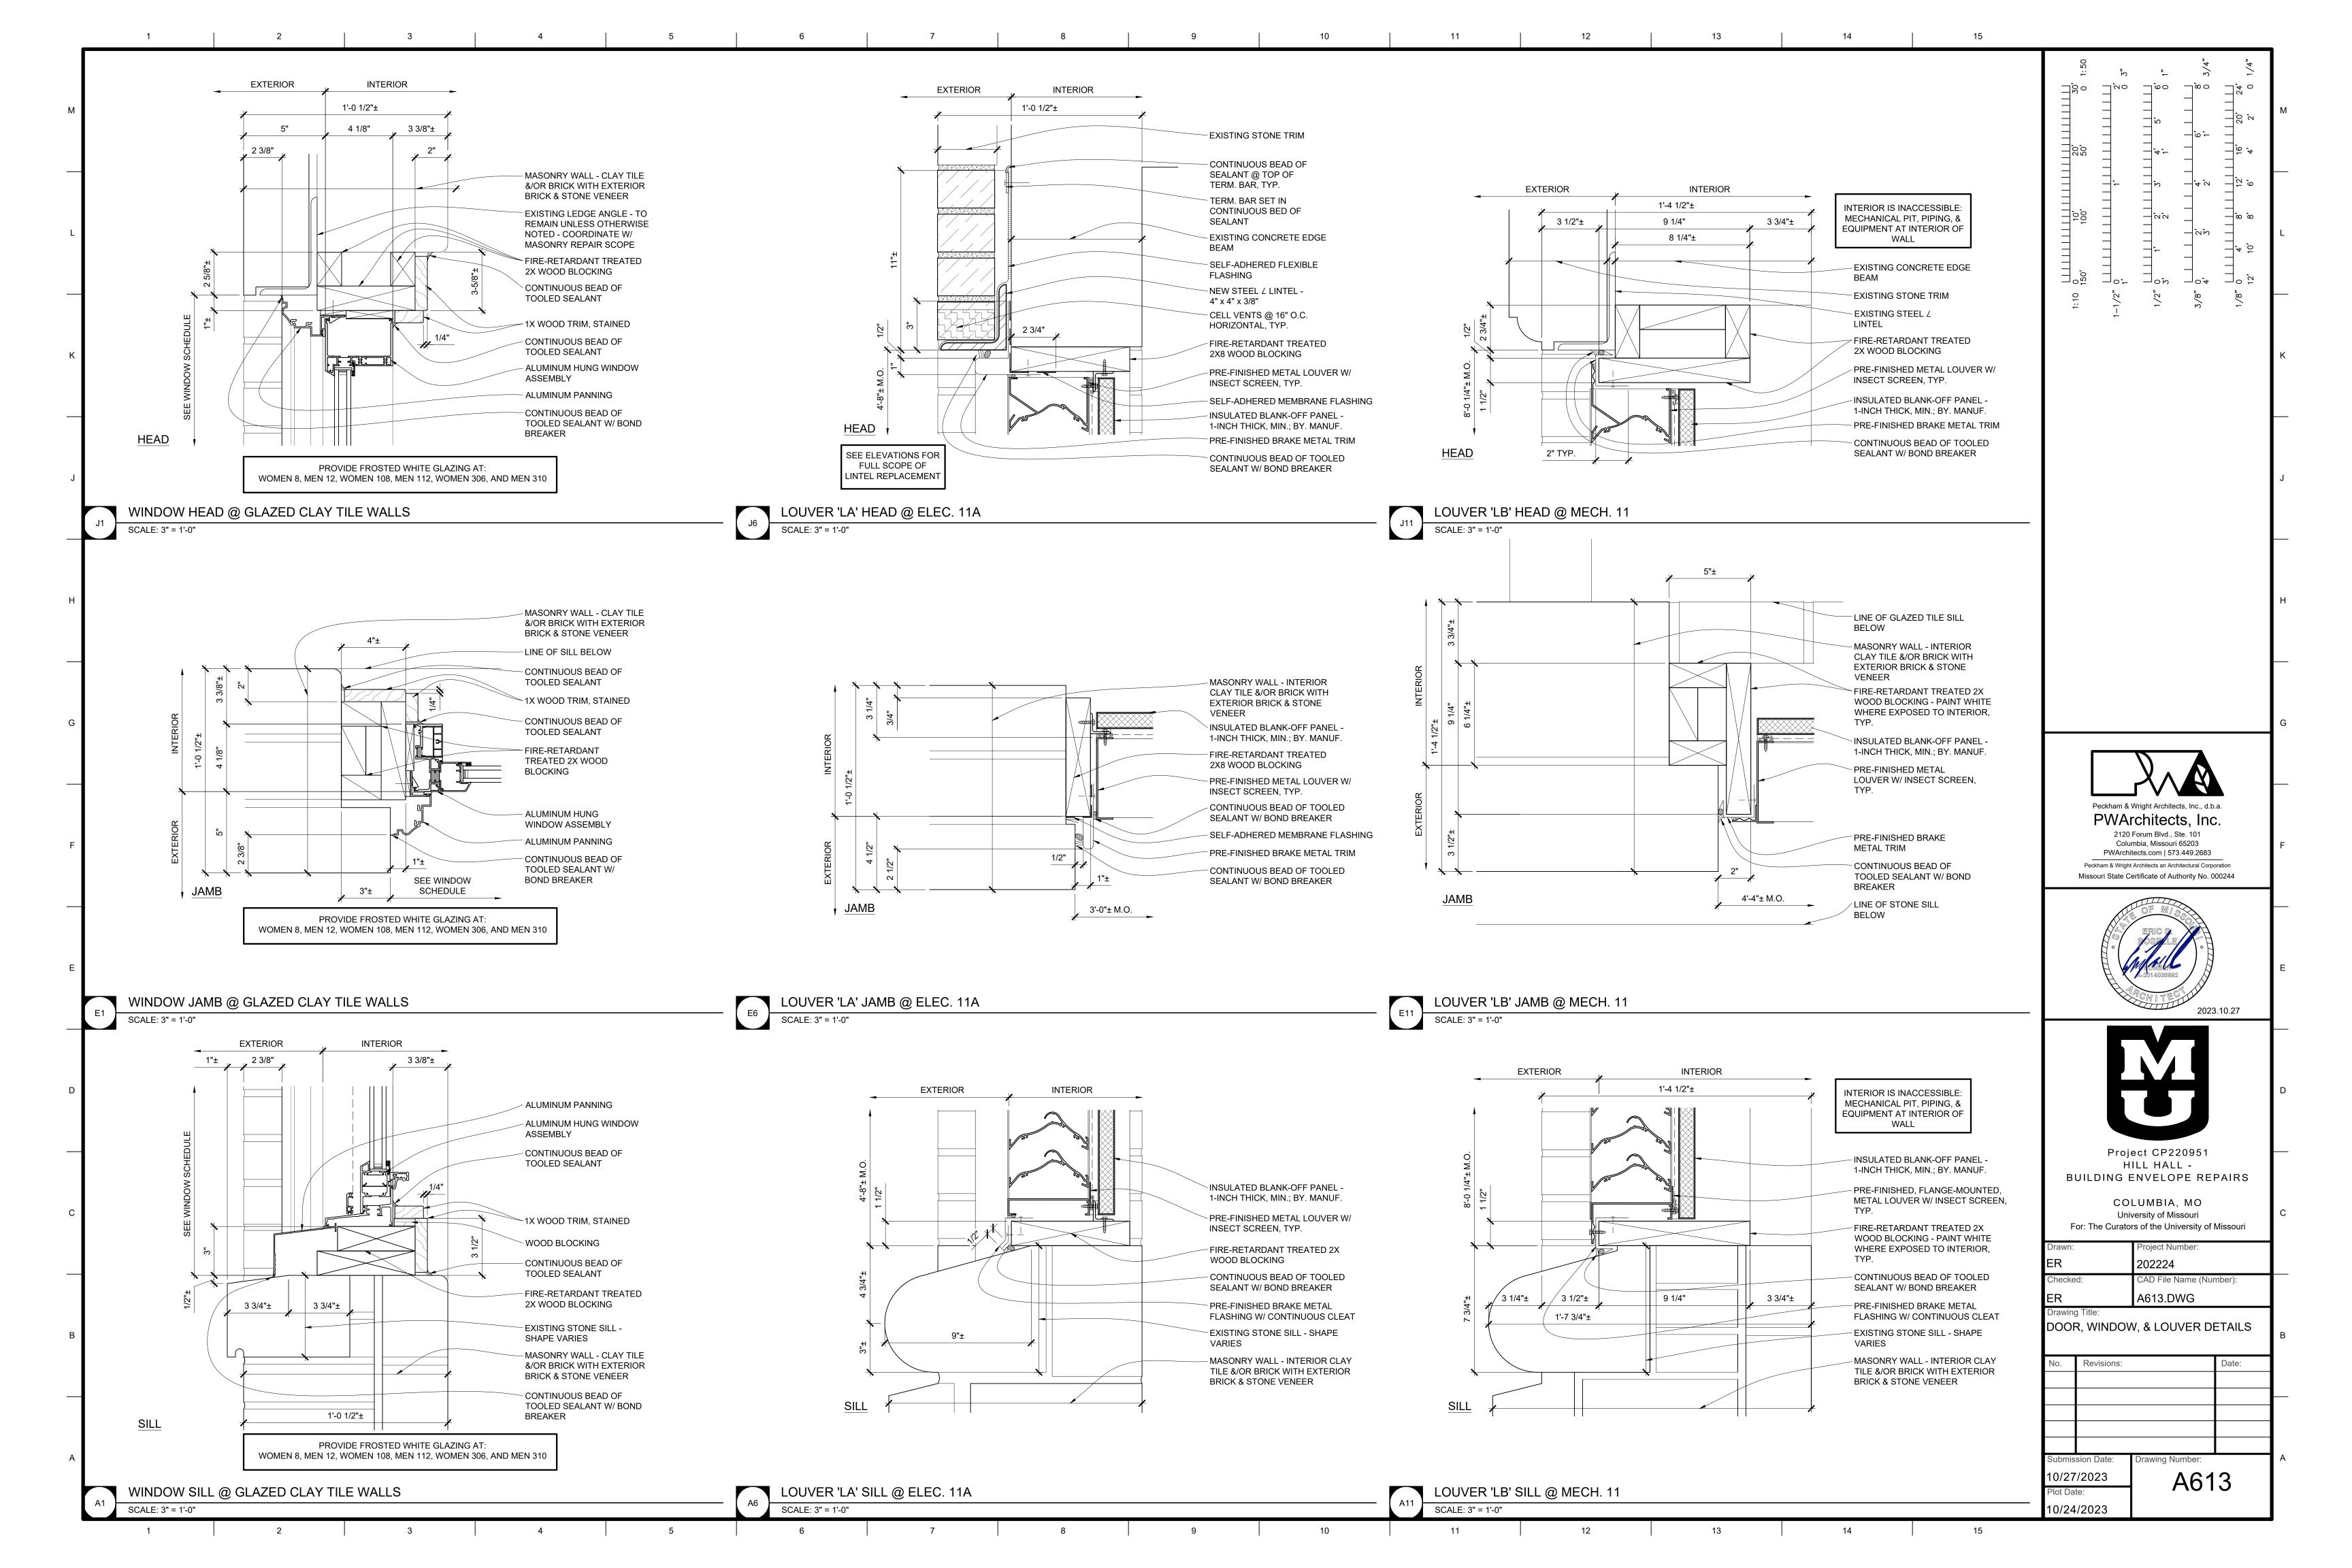

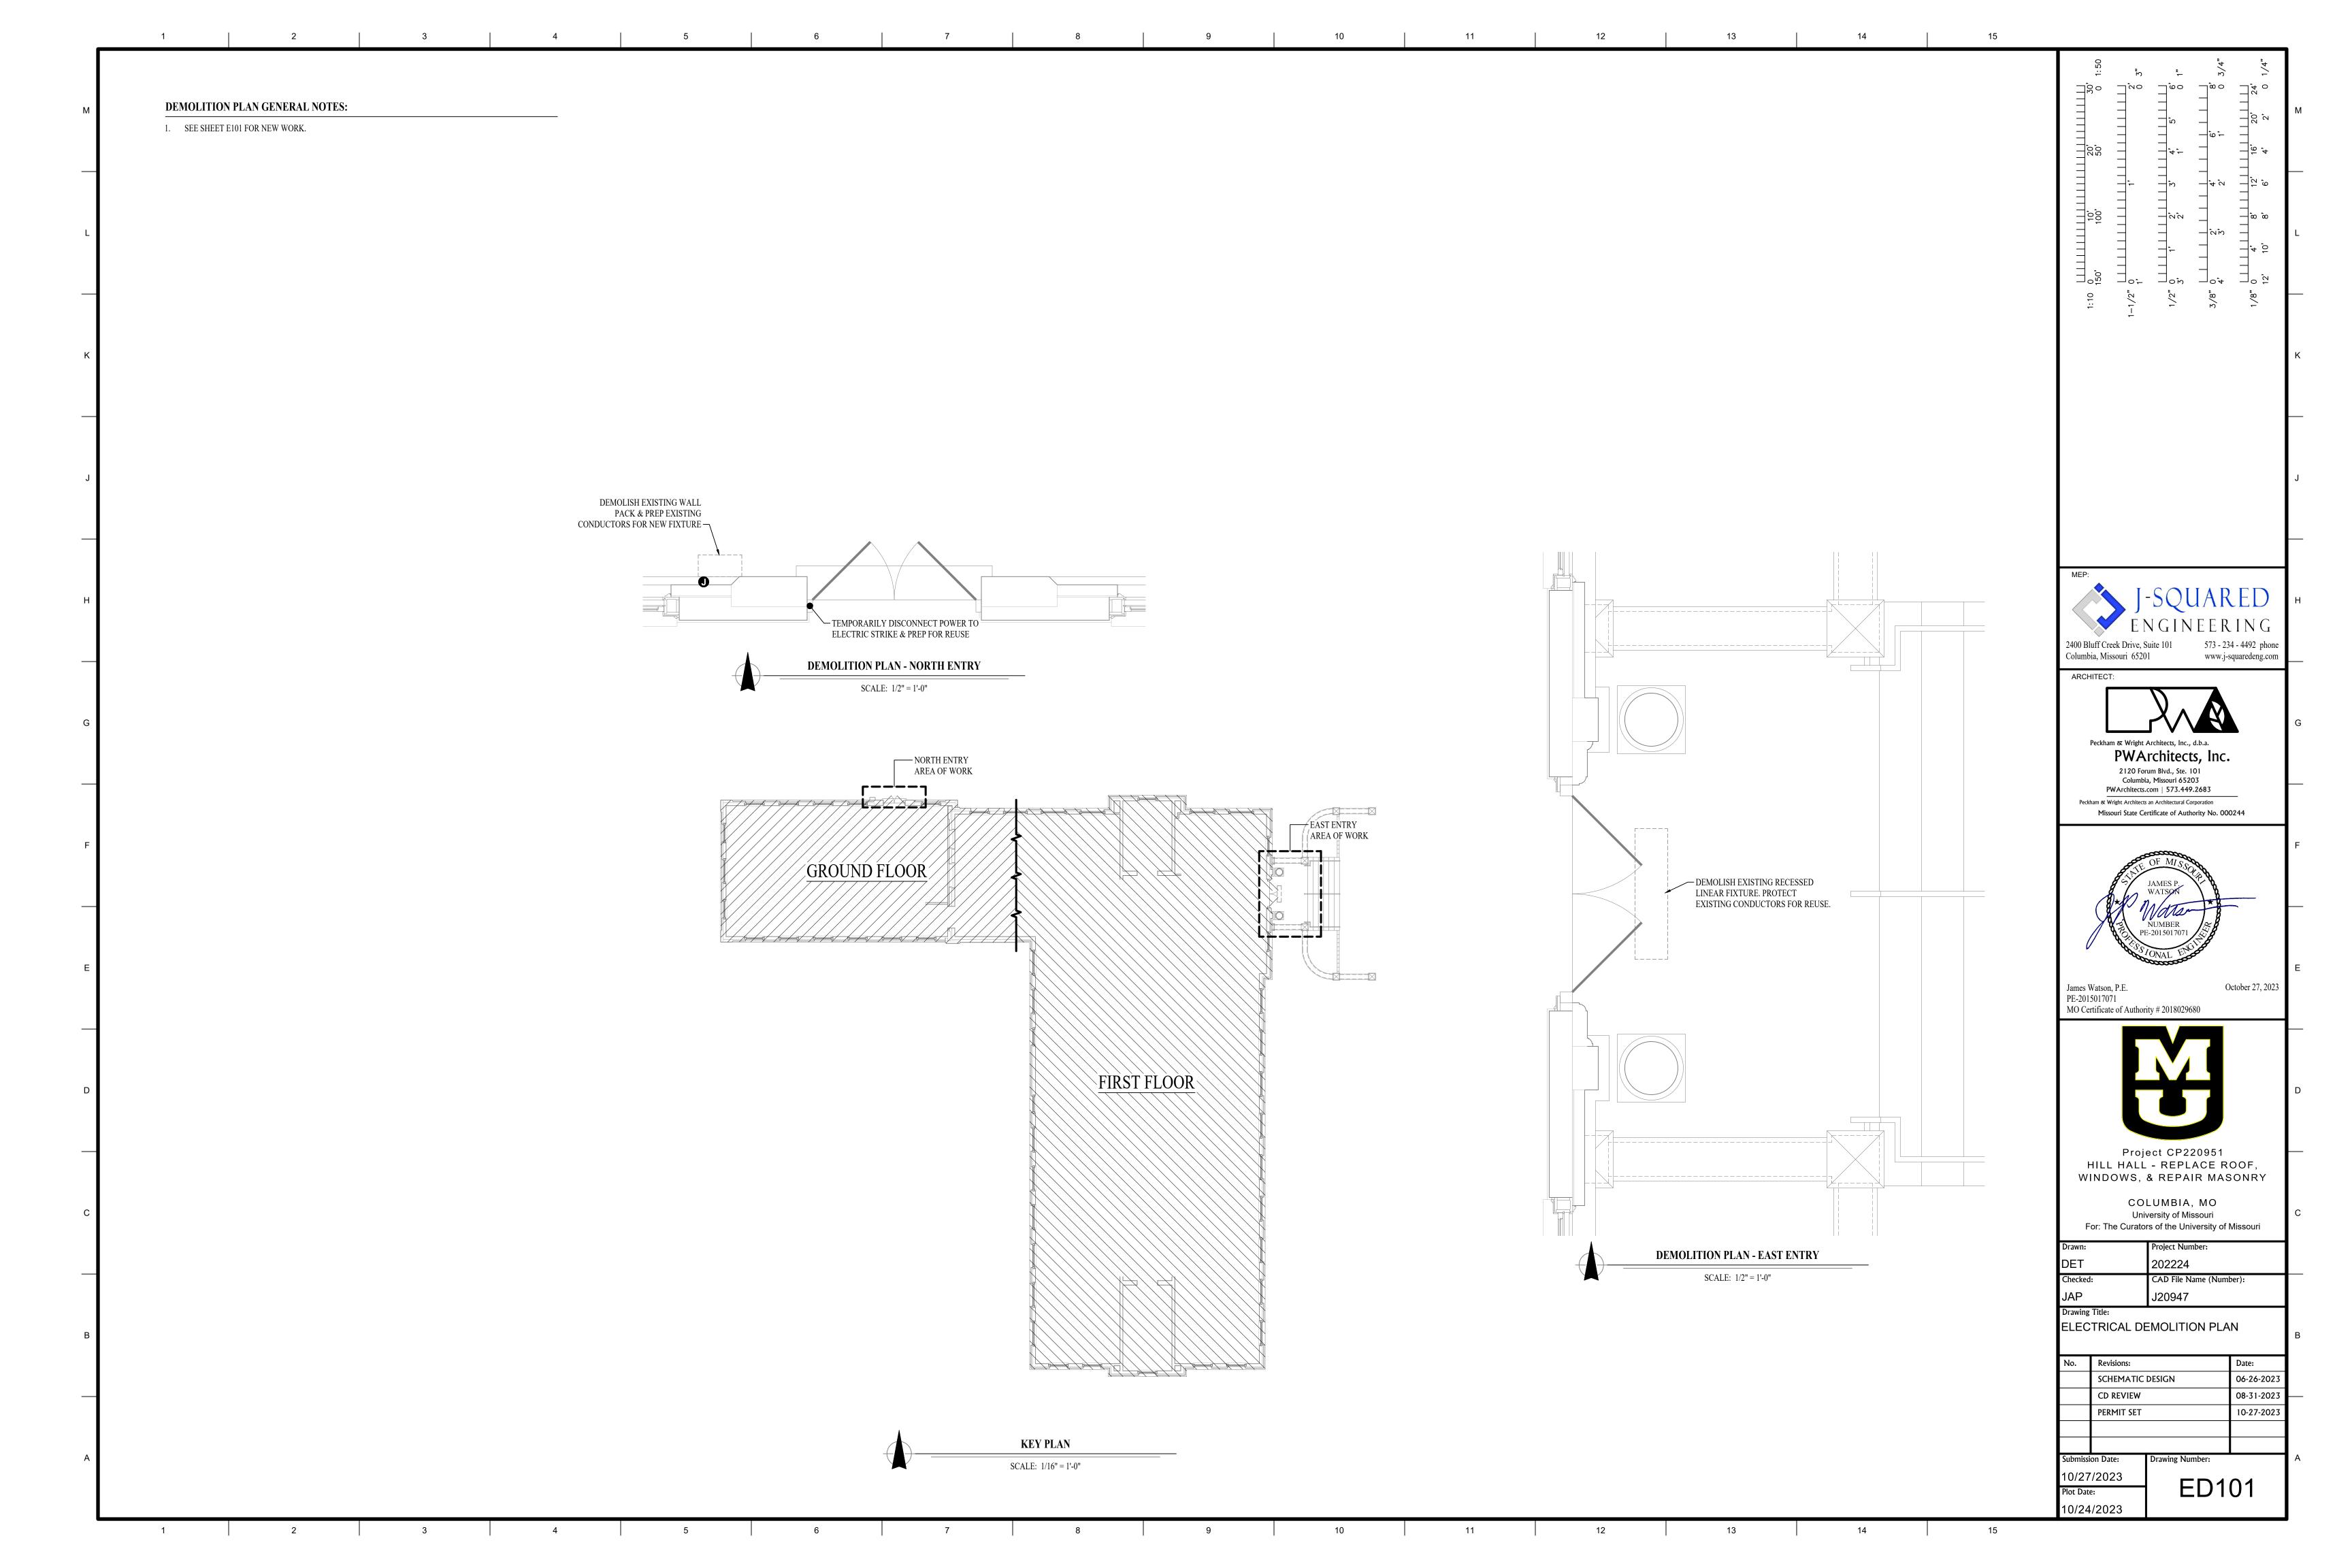

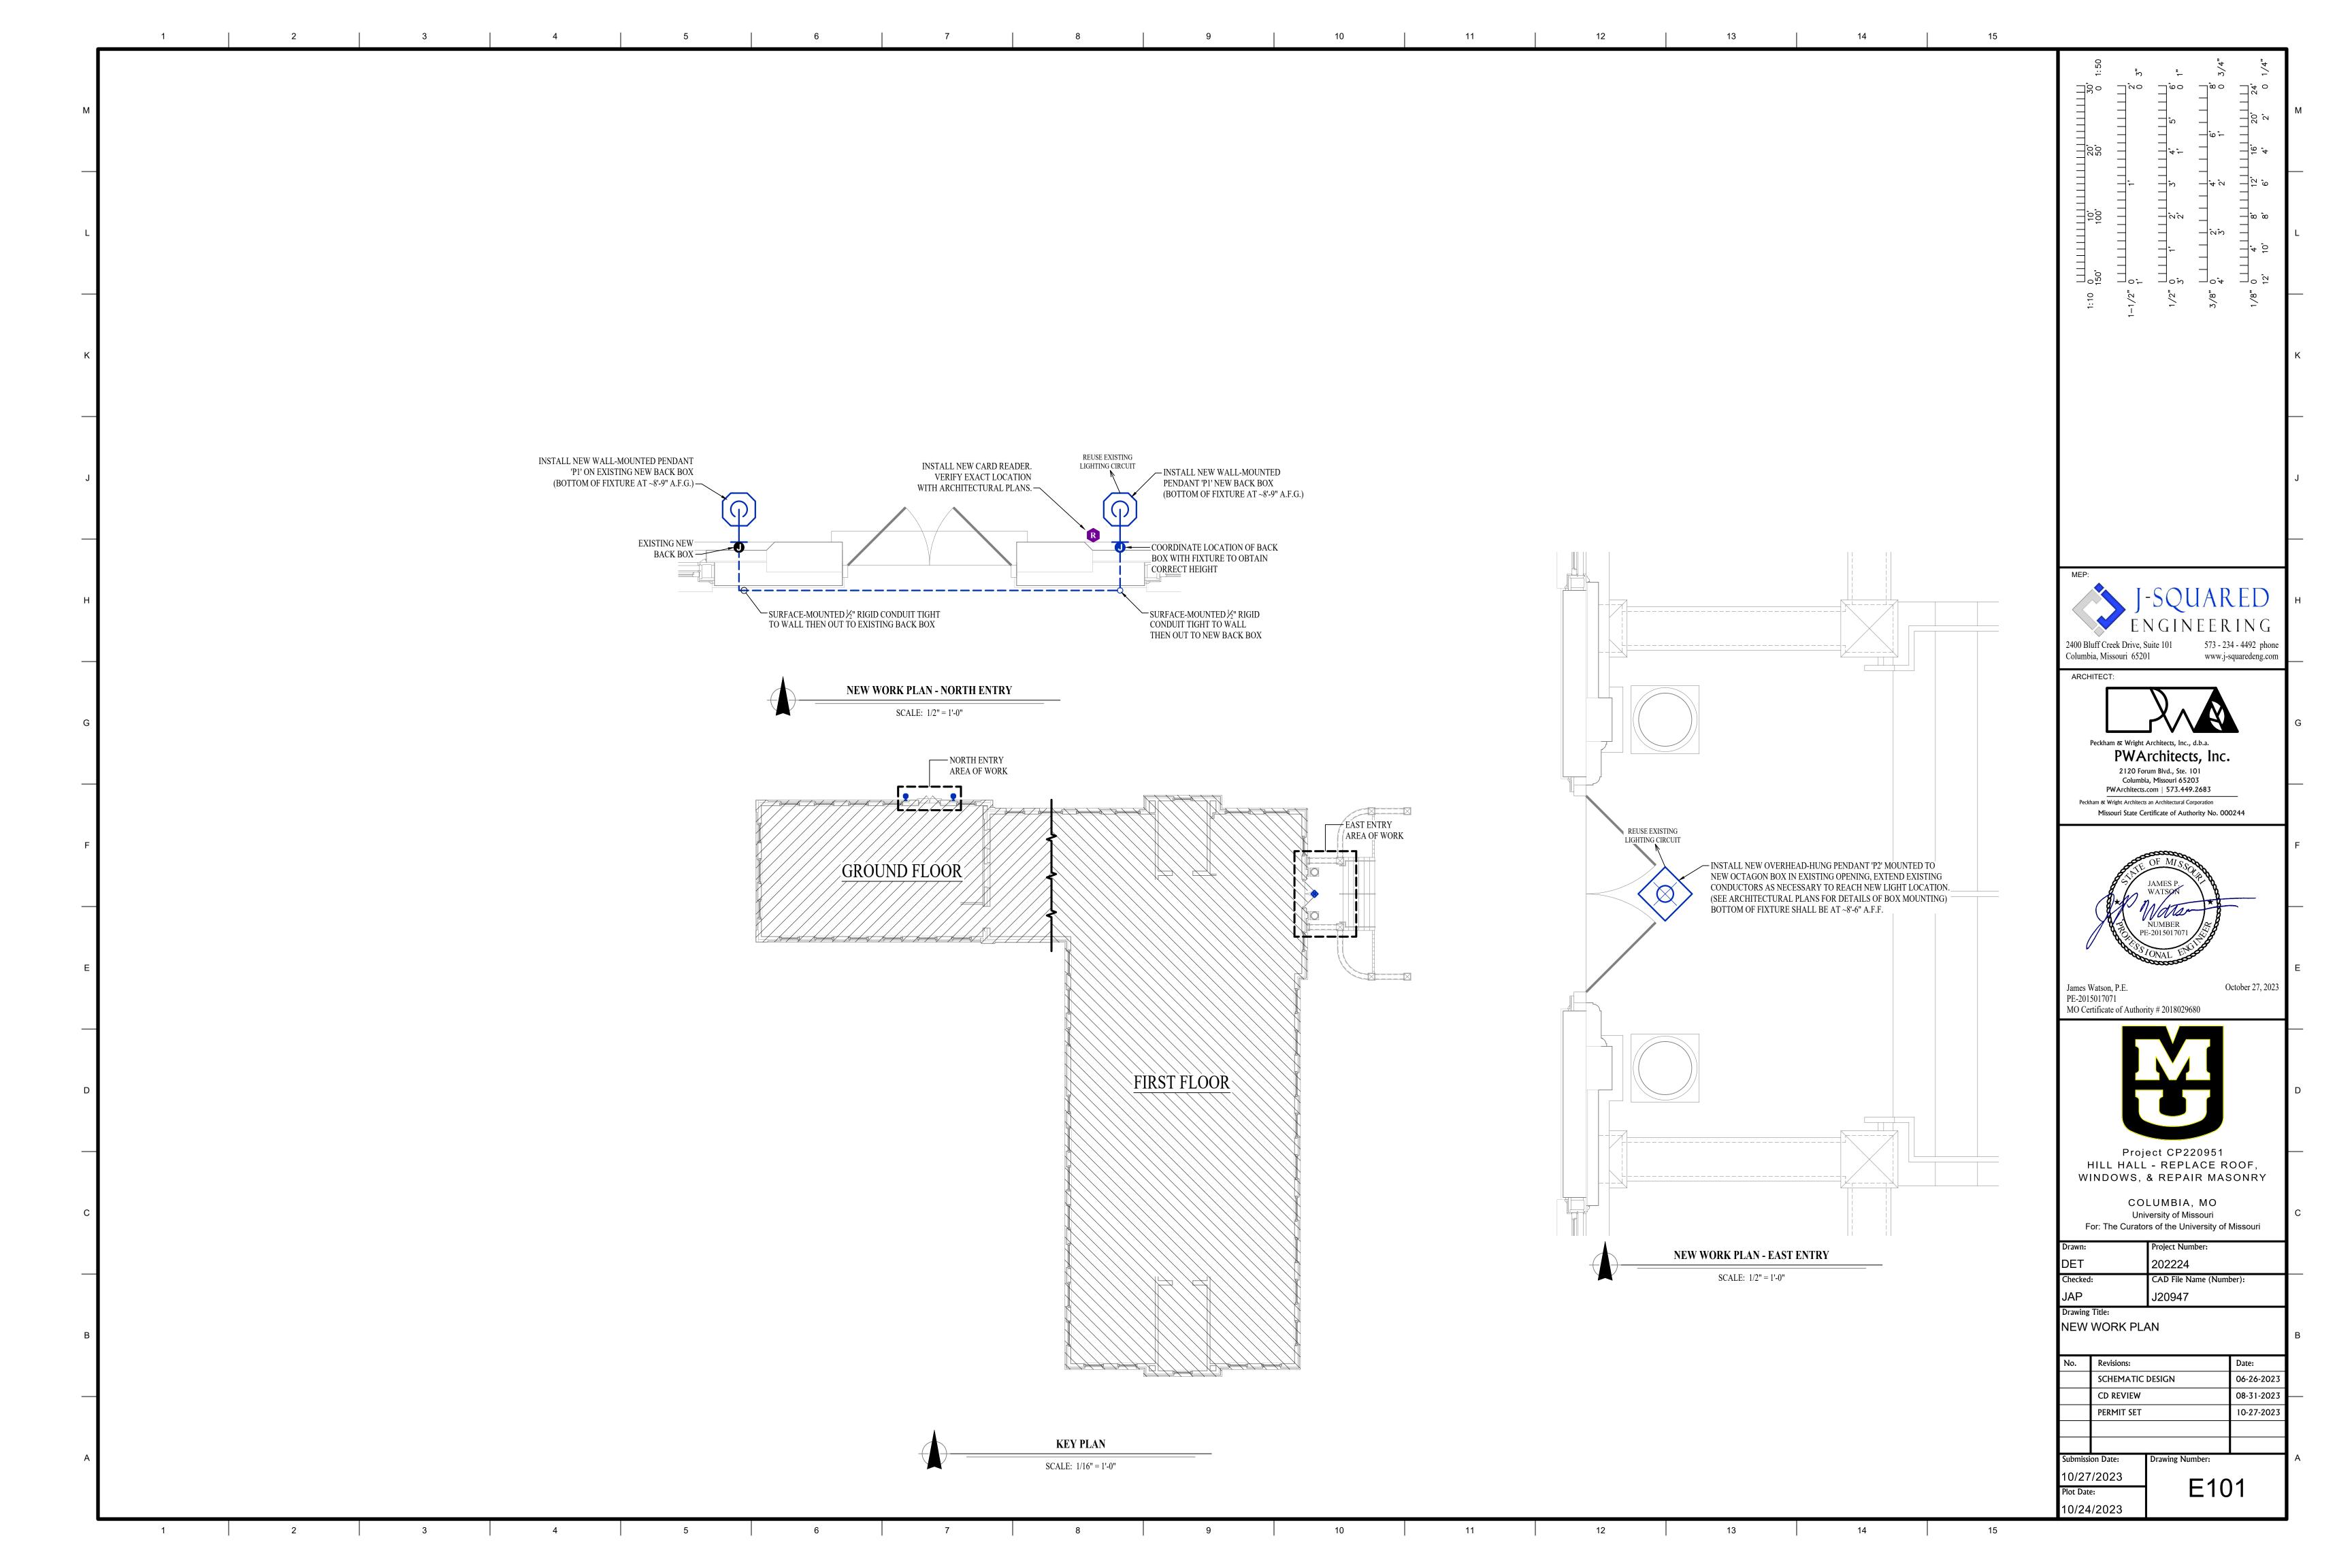

					ELECTRICAL SPECIFICATIONS	30,
		LIGHT FIXTURE SCHEDU	JLE		<ol> <li>GENERAL</li> <li>1.1. THE ENTIRE ELECTRICAL SYSTEM SHALL BE CONTINUOUSLY GROUNDED. EVERY BRANCH CONDUIT SHALL INCLUDE A GREEN GROUND CONDUCTOR SIZED PER NEC.</li> </ol>	20,
	TAG MANUFACTURER MODEL NUMBER (OR EQUAL) (OR EQUAL)	DES CRIPTION MOUNTING	LUMEN OUTPUT CCT (°K) CRI VOLTS WATTS	NOTES	<ul><li>1.2. PROVIDE TYPE WRITTEN PANEL SCHEDULE FOR EACH PANEL.</li><li>2. MATERIALS</li><li>2.1. CONDUIT &amp; CONDUCTORS</li></ul>	
	P1 STERNBERG LIGHTING 1W-9930B-VCOB-4L30TA-MDL03-SV1/80DWB/BK P2 STERNBERG LIGHTING CH44-45"-9930H-VCOB-4L30TA-MDL03-SV1/BK7		5120         3000         70         MVOLT         53           5120         3000         70         MVOLT         53		2.1.1. ALL CONDUCTORS SIZES INDICATED ON PLANS ARE COPPER UNLESS NOTED OTHERWISE.	100,
	NOTES:  1. VERIFY LIGHT FIXTURE FINISHES WITH OWNER / ARCHITECT PRIOR TO	INSTALLATION			<ul> <li>2.1.2. ABOVE GRADE CONDUCTORS SHALL BE THHN COPPER.</li> <li>2.1.3. MINIMUM CONDUCTOR SIZE SHALL BE #12 UNLESS NOTED OTHERWISE. 120V, 20 AMP CIRCUITS WITH CONDUCTOR LENGTH GREATER THAN 100' SHALL BE MINIMUM #10.</li> </ul>	
<u>L</u>					ELECTRICAL CONTRACTOR IS RESPONSIBLE FOR MEASURING ACTUAL CONDUCTOR LENGTH AND INCREASING CONDUCTOR SIZE TO COMPENSATE FOR VOLTAGE DROP AS REQUIRED BY NEC.	000000000000000000000000000000000000000
					2.2. DEVICES 2.2.1. CONTRACTOR TO PROVIDE J-BOXES, COVER PLATES, AND ANY ACCESSORIES REQUIRED TO PROVIDE A COMPLETE SYSTEM. SEE ARCHITECTURAL PLANS FOR DEVICE COLORS.	1:10
					TO FROVIDE A COMPLETE STSTEM. SEE ARCHITECTURAL FLANS FOR DEVICE COLORS.	
						MEP:
						EN
						2400 Bluff Creek Drive, Sui Columbia, Missouri 65201
					$\neg \mid \mid$	ARCHITECT:
					—2 CONDUCTOR	
				OOR POSITION SWITCH(ES)	18 AWG, STRANDED	Peckham & Wright A
				6 CONDUCTOR 22 AWG, STRANDED —		PWAr 2120 Foru Columbia,
						PWArchitects.co Peckham & Wright Architects a Missouri State Cert
			2 CONDUCTOR 18 AWG, STRANDED	CARD READER		A LANGE
				LECTRIC PANIC DEVICE (O/C)	EXISTING CA PANEL	
						PE.
						00000
						James Watson, P.E. PE-2015017071 MO Certificate of Authorit
						MO Certificate of Authorit
				CEQUENCE OF OPENAT		
			NOTES:  1. ALL WIRING MUST BE IN MINIMUM 3/4" RIGID CONDUIT.	SEQUENCE OF OPERAT  1. LOCKED HOURS WILL BE	E DETERMINED BY THE CARD ACCESS SYSTEM.	Proje
			<ol> <li>ALL LOW VOLTGE WIRING (&lt;25 V) TO BE MINIMUM 18 AWG STRAUNLESS SPECIFIED OTHERWISE OR REQUIRED BY THE DEVICE.</li> </ol>		JRS, THE CONTROLLER WILL ENERGIZE THE LOCKING DEVICE.	HILL HALL WINDOWS, &
			<ol> <li>O/C = OWNER PROVIDED, CONTRACTOR INSTALLED. ALL OTHER PROVIDED AND CONTRACTOR INSTALLED.</li> </ol>		S, THE CONTROLLER WILL DE-ENERGIZE THE LOCKING DEVICE D IS READ BY THE CARD READER.	COL Unive
			4. SEE DRAWINGS FOR CARD ACCESS PANEL LOCATION			For: The Curators  Drawn:
			5. ALL ELECTRONIC LOCKING DEVICES MUST HAVE 24VDC COILS. 1A IN RUSH OR 500MA MUST HAVE ITS OWN POWER SUPPLY.	DEVICES REQUIRING MORE THAN		DET 2
			6. ANY DOOR FRAME WIRE PENETRATIONS MUST BE INSTALLED W			JAP Drawing Title:
			7. PROVIDE ADDITIONAL ELECTRONIC LOCKING DEVICES CONNEC AS REQUIRED FOR EACH DOOR LOCATION.	TED TO DOOR CONTROLLER SIGNAL		ELECTRICAL DE
			8. DOOR POSITION SWITCH PREFERRED TO BE INTEGRAL LATCH M CONCEALED MAGNETIC SWITCH. INSTALL ONE DPS FOR EACH L			No. Revisions:
						SCHEMATIC DE CD REVIEW
				CABB ACCECC BOOR BETAIN		PERMIT SET
			-	CARD ACCESS DOOR DETAIL		Submission Date: D
						10/27/2023